

Final Decision

Planning Commission

File number(s):

DR 22-07 & EXCP 22-03

Project name:

Do It Best Expansion

Date of decision:

June 23, 2022

Date of mailing:

June 24, 2022

Applicant:

Tim Miller, Do It Best Corp.

Landowner:

Do It Best Corp.

Site location:

333 S. Woodland Avenue (Tax Lot 052W110000101)

Summary:


The Planning Commission held a public hearing on June 23, 2022 and unanimously approved the Design Review (DR) and Exception to Street Right of Way and Improvement Requirements ("Street Exception", EXCP) application package with the conditions recommended by staff through the staff report published June 16. No parties testified in opposition.

The subject property is 333 S. Woodland Ave, a 28.02-acre property in the Light Industrial (IL) zoning district and Interchange Management Area (IMA) overlay district. The property is developed with an industrial warehouse and distribution facility occupied by Do It Best Corp.

The Planning Commission approved an expansion to the building, adding approximately 167,200 square feet of warehouse/distribution space, 9,750 square feet of flammable storage space, and 10,000 square feet of office space. Additional site improvements include added parking and trailer storage spaces and landscaping, as well as realignment of the emergency access driveway on Newberg Hwy / OR 219. The Commission also approved the applicant's Street Exception request to maintain existing street improvements along the Newberg Hwy / OR 219 and S. Woodland Ave frontages.



Aerial view of the subject property

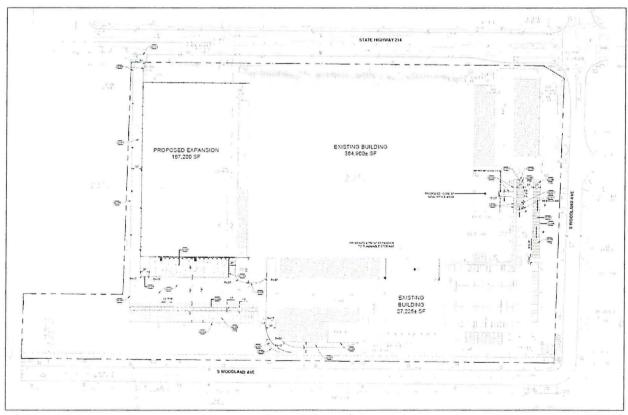


Approved site plan

Conditions of Approval

- 1. Substantial Conformance: The applicant or successor shall develop the property in substantial conformance with the final plans submitted and approved with this application, except as modified by these conditions of approval. Were the applicant to revise plans other than to meet conditions of approval or meet building code, even if Planning Division staff does not notice and signs off on building permit issuance, Division staff retains the right to obtain restoration of improvements as shown on an earlier land use review plan set in service of substantial conformance.
- 2. Public Works: Follow the attached "Public Works Conditions May 18, 2022" (Attachment 101A).
- 3. Fence Permit: To demonstrate conformance with WDO 2.06.02 and 5.01.03, the applicant shall submit application for and obtain approval of a Fence Permit prior to building permit issuance.
- 4. Public Utility Easement: Pursuant to WDO 3.02.01 and Figure 3.01B, the applicant shall either provide documentation of an existing 10-foot wide public utility easement (PUE) along the frontage of Newberg Hwy, or grant a 10-foot wide PUE along this frontage. This is due prior to building permit issuance.


5. Emergency Access Driveway:

- a. For the relocated emergency access driveway along Newberg Hwy, the paved width at the north property line shall be no wider than 20 feet, unless required to be wider by the Woodburn Fire District.
- b. Prior to building permit final inspection, the applicant shall remove the existing emergency access driveway improvements within the right-of-way and construct restorative curb, sidewalk, and lawn landscaping. This is due prior to building permit final inspection.
- 6. Bicycle Parking: To meet WDO 3.05.03E, the applicant shall revise the site plan to illustrate and note at least three new bicycle parking stalls. This is due prior to building permit issuance.
- 7. Tree Preservation: The applicant shall make a reasonable effort to protect and preserve the three existing trees east of the proposed office expansion and north of the parking lot improvements (see the image on the following page), following the City of Portland Tree Protection Rules (Attachment 101B) throughout the entire construction process for the development. These trees may only be removed if the applicant provides an arborist report documenting why and how preservation is not physically possible. If it is determined that a tree cannot be preserved, the applicant shall pay a tree removal fee of \$185 per tree.

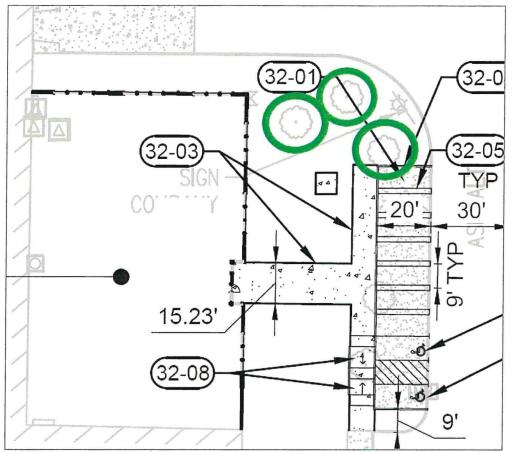

Condition 7: Site plan excerpt with existing trees to be preserved circled in green.

8. Newberg Hwy Tree Line: The applicant shall revise landscaping plans to fill in the approximately 120-foot long gap in the tree line along Newberg Highway in the northeast corner of the property, between the existing tree line and the eastern boundary of the paved trailer parking area (see image below). Tree planting within this gap shall match the tree species and spacing illustrated on Sheet L1.10. Revised plans are due prior to building permit issuance.

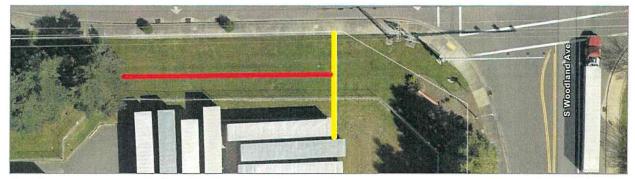

Condition 8: Continue the tree line roughly along the red line to the eastern boundary of the paved trailer parking area (approximated by the yellow line).

Notes to the Applicant

The following are not planning / land use / zoning conditions of approval, but are notes for the applicant to be aware of and follow:

- 1. Permits: Permits are applied for using the <u>Oregon ePermitting</u> online permit system. The City Building Division administers building and mechanical permits; Marion County Public Works administers plumbing and electrical permits.
- 2. Demolition Permits: Demolition of any existing structures may require <u>Demolition Permit</u> approval through the Building Division.
- 3. Records: Staff recommends that the applicant retain a copy of the subject approval.
- 4. Fences, fencing, & free-standing walls: The approval excludes any new fences, fencing, & free-standing walls, which are subject to WDO 2.06 and the permit process of 5.01.03.
- 5. Signage: The approval excludes any signage, which is subject to WDO 3.10 and the permit process of 5.01.10.
- 6. Other Agencies: The applicant, not the City, is responsible for obtaining permits from any county, state and/or federal agencies, which may require approval or permit, and must obtain all applicable City and County permits for work prior to the start of work and that the work meets the satisfaction of the permit-issuing jurisdiction. The Oregon Department of Transportation (ODOT) might require highway access, storm drainage, and other right-of-way (ROW) permits. All work within the public ROW or easements within City jurisdiction must conform to plans approved by the Public Works Department and must comply with a Public Works Right-of-Way permit issued by said department. Marion County plumbing permits must be issued for all waterline, sanitary sewer, and storm sewer work installed beyond the Public Right-of-Way, on private property.
- 7. Inspection: The applicant shall construct, install, or plant all improvements, including landscaping, prior to City staff verification. Contact Planning Division staff at least three (3) City business days prior to a desired date of planning and zoning inspection of site improvements. This is required and separate from and in addition to the usual building code and fire and life safety inspections. Note that Planning staff are not primarily inspectors, do not have the nearly immediate availability of building inspectors, and are not bound by any building inspector's schedule or general contractor convenience.
- 8. Stormwater management: The storm sewer system and any required on-site detention for the development must comply with the City Storm Water Management Plan, Public Works storm water practices and the Storm Drainage Master Plan.
- Public Works Review: Staff performs final review of the civil plans during the building permit stage. Public infrastructure must be constructed in accordance with plans approved by the City, as well as current Public Works construction specifications, Standard Drawings, Standard Details, and General Conditions.

- 10. Franchises: The applicant provides for the installation of all franchised utilities and any required easements.
- 11. Water: All water mains and appurtenances must comply with Public Works, Building Division, and Woodburn Fire District requirements. Existing water services lines that are not going to be use with this new development must be abandoned at the main line. The City performs required abandonment of existing water facilities at the water main with payment by the property owner. All taps to existing water mains must be done by a "Hot Tap" method and by approved City of Woodburn Contractors. The applicant shall install the proper type of backflow preventer for all domestic, lawn irrigation and fire sprinkler services. The backflow devices and meters shall be located near the city water main within an easement, unless approved otherwise by Public Works. Contact Byron Brooks, City of Woodburn Water Superintendent, for proper type and installation requirements of the backflow device at (503) 982-5380.
- 12. Grease Interceptor/Trap: If applicable, a grease trap would need to be installed on the sanitary service, either as a central unit or in the communal kitchen/food preparation area. Contact Marion County Plumbing Department for permit and installation requirements, (503) 588-5147.
- 13. Fire: Fire protection requirements must comply with the Woodburn Fire District standards and requirements. Place fire hydrants within the public ROW or public utility easement and construct them in accordance with Public Works Department requirements, specifications, standards, and permit requirements. Fire protection access, fire hydrant locations and fire protection issues must comply with current fire codes and Woodburn Fire District standards. See City of Woodburn Standard Detail No. 5070-2 Fire Vault. The fire vault must be placed within the public right-of-way or public utility easement.
- 14. SDCs: The developer pays System Development Charges prior to building permit issuance.

Expiration

Per Woodburn Development Ordinance (WDO) 4.02.04B., a final decision expires within three years of the date of the final decision unless:

- 1. A building permit to exercise the right granted by the decision has been issued;
- 2. The activity approved in the decision has commenced; or
- 3. A time extension, Section 4.02.05, has been approved.

Appeals

Per WDO 4.01.11E., the decision is final unless appealed pursuant to Oregon Revised Statutes (ORS), state administrative rules, and WDO $\underline{4.02.01}$. The appeal to City Council due date is twelve (12) days from the mailing date of this final decision notice per 4.02.01B.1. A valid appeal must meet the requirements of 4.02.01.

A copy of the decision is available for inspection at no cost, and the City would provide a copy at reasonable cost at the Community Development Department, City Hall, 270 Montgomery Street, Woodburn, OR 97071. For questions or additional information, contact the Planning Division at (503) 982-5246 or planning@ci.woodburn.or.us.

Sincerely

Dan/Händěl, AICP, Planner

Date

Affirmed,

Charles Piper Chair, Planning Commission

Date

attachments:

- 1. Public Works Conditions May 18, 2022 (Planning Commission Staff Report Attachment 101A)
- 2. City of Portland Tree Protection Rules (Planning Commission Staff Report Attachment 101B)
- 3. Site Plans (Planning Commission Staff Report Attachment 104)



Public Works Comments
Do It Best Corporation
Expansion
333 S Woodland Avenue

May 18, 2022


A. CONDITIONS OF LAND USE APPROVAL:

- 1. The applicant, not the city, is responsible for obtaining required permits from any county, state, and/or federal agencies.
- 2. All work within the public rights-of-way or easements within city jurisdiction shall require plan approval and permit issuance from the Public Works Department. All public improvements construction work shall be performed in accordance with the plans stamped "approved" by the City, and comply with the City's Standard Specifications and Standard drawings.
- System Development fees shall be paid prior to building permit issuance. The Water, Sewer, Storm and Parks SDC fees will be determined after the developer provides a complete Commercial/Industrial Development information sheet
- 4. Applicant to submit a final stormwater report indicating that the design complies with both City of Woodburn and Oregon Department of Transportation (ODOT) requirements. The westerly private storm system conveys drainage to ODOT's system located on State Highway 219. Report shall address the plan to maintain the same detention on the southeast detention pond, compensate for the proposed improvements.
- 5. Applicant to obtain approval from ODOT for proposed improvement along State Highway 219.
- 6. Applicant to obtain a plumbing permit from Marion County for the proposed modifications to the onsite private storm drainage system.
- 7. Applicant to comply with Planning Division and Woodburn Fire District requirements for emergency access.
- 8. Traffic impact analysis (TIA) shall comply with both City of Woodburn and ODOT requirements.
- 9. Fire protection requirements shall comply with the Woodburn Fire District standards and requirements.
- 10. For information, the applicant is not requesting additional sewer services, storm drainage connections, and water services (domestic, irrigation or fire protection).


Attachment 101B

The applicant shall protect the preserved trees pursuant similar to City of Portland Title <u>11.60.030</u>, specifically either the subsections set of C.1.a.(1), (3) and C.1.b., e., & f. (clear and objective) and D.; or, the subsections set of C.2.a., b., & d.-f. (arborist's discretion) and D. as modified below and shall do so between land use approval and issuance of certificate of occupancy (C of O):

- C. Protection methods. The Tree Plan shall show that the contractor adequately protects trees to be preserved during construction using one of the methods described below:
 - 1. Clear & Objective Path.
 - a. A root protection zone is established as follows:
 - (1) For trees on the development site a minimum of 1 foot radius (measured horizontally away from the face of the tree trunk) for each inch of tree diameter (see Figure 80-2)

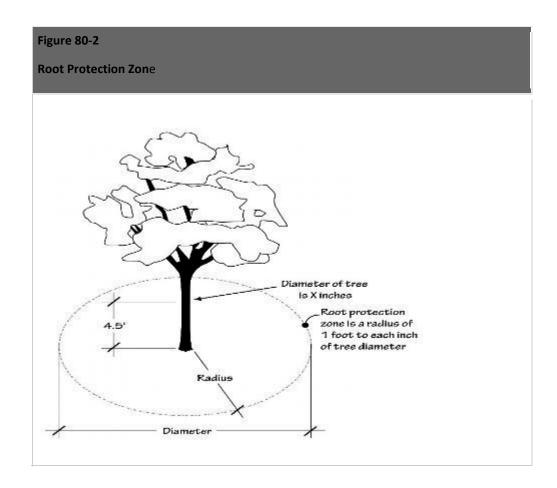

- (3) Existing encroachments into the root protection zone, including structures, paved surfaces and utilities, may remain. New encroachments into the root protection zone are allowed provided:
 - (a) the area of all new encroachments is less than 25 percent of the remaining root protection zone area when existing encroachments are subtracted; and
 - (b) no new encroachment is closer than 1/2 the required radius distance (see Figure 60-1);

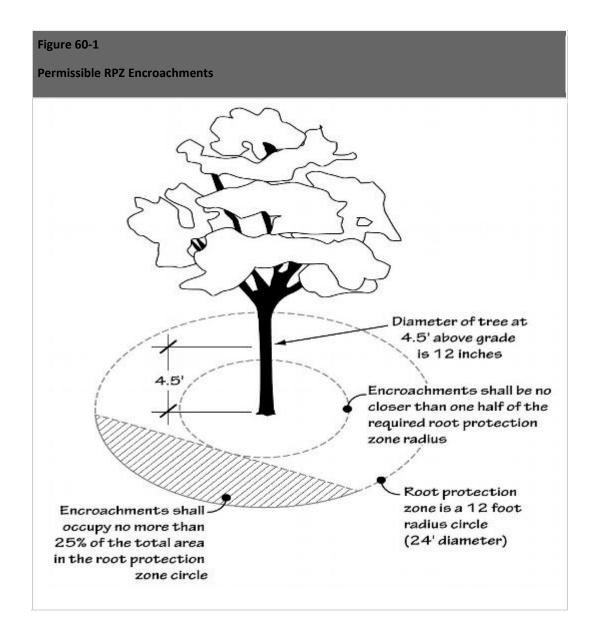

b. Protection fencing

- (1) Protection fencing consisting of a minimum 6-foot high metal chain link construction fence, secured with 8-foot metal posts shall be established at the edge of the root protection zone and permissible encroachment area on the development site. Existing structures and/or existing secured fencing at least 3½ feet tall can serve as the required protective fencing.
- (2) When a root protection zone extends beyond the development site, protection fencing is not required to extend beyond the development site. Existing structures and/or existing secured fencing at least 3½ feet tall can serve as the required protective fencing.
- e. The following is prohibited within the root protection zone of each tree or outside the limits of the development impact area: ground disturbance or construction activity including vehicle or equipment access (but excluding access on existing streets or driveways), storage of

Attachment 101D

equipment or materials including soil, temporary or permanent stockpiling, proposed buildings, impervious surfaces, underground utilities, excavation or fill, trenching or other work activities; and

- f. The fence shall be installed before any ground disturbing activities including clearing and grading, or construction starts; and shall remain in place until final inspection by Planning Division staff.
- 2. Arborist's Discretion. When the prescriptive path is not practicable, the applicant may propose alternative measures to modify the clear and objective root protection zone (RPZ), provided the following standards are met:
 - a. The alternative RPZ is prepared by an arborist who has visited the site and examined the specific tree's size, location, and extent of root cover, evaluated the tree's tolerance to construction impact based on its species and health, identified any past impacts that have occurred within the root zone, and forwarded a report through the developer to Planning Division staff;
 - b. The arborist has prepared a plan providing the rationale used to demonstrate that the alternate method provides an adequate level of protection based on the findings from the site visit described above;
 - d. If the alternative methods require the arborist be on site during construction activity, the applicant shall submit a copy of the contract for those services prior to permit issuance and a final report from the arborist documenting the inspections and verifying the viability of the tree(s) prior to final inspection by the Planning Division;
 - e. If the alternative tree protection method involves alternative construction techniques, an explanation of the techniques and materials used shall be submitted;
 - f. The arborist shall sign the tree preservation and protection plan and include contact information.
- D. Changes to tree protection. Changes to the tree protection measures during the course of the development may be approved as a revision to a permit provided that the change is not the result of an unauthorized encroachment into a root protection zone (RPZ), and the applicant demonstrates that the tree protection standards of this Section continue to be met. When an unauthorized encroachment has occurred, the City may pursue an enforcement action or other remedy.

DO IT BEST EXPANSION

333 S WOODLAND AVE, WOODBURN LU SUBMITTAL - APRIL 14, 2022

ABBREVI	ATIONS	
@	AT	GA
AB	ANCHOR BOLT	GAL
AC	ASPHALTIC CONCRETE	GEN
ACI ADA	AMERICAN CONCRETE INSTITUTE AMERICANS WITH DISIBILITIES ACT	GLE GLZ
ADD'L	ADDITIONAL	GR
ADJ AESS	ADJACENT/ ADJUSTABLE ARCHITECTURALLY EXPOSED	GRI GS/
AESS	STRUCTURAL STEEL	GSF
AFF AISC	ABOVE FINISH FLOOR AMERICAN INSTITUTE OF STEEL	GYF
AISC	CONSTRUCTION	НВ
AL / ALUM ALT	ALUMINUM ALTERNATE	НС
APPROX	APPROXIMATE	HCN HDF
ARCH	ARCHITECT(URAL)	HDF
ATR	ALL-THREAD ROD	HD\ HGI
B/	BOTTOM OF	HL
BATT BD	BATTEN INSULATION BOARD	HM
BLD / BLDG	BUILDING	HMI HM\
BLK	BLOCK	HOF
BLKG BM	BLOCKING BENCHMARK / BEAM	HR(
BN	BOUNDARY NAIL	HS HSE
BOT / BOTT	BOTTOM	HSS
BRG BSMT	BEARING BASEMENT	HTC HVA
BTWN	BETWEEN	ПУР
BUR	BUILT UP ROOFING	HW
CAB	CABINET	IBC
CB CDF	CATCH BASIN CONTROLLED DENSITY FILL	ID IE
CIP	CAST IRON	IF
CJ	CONTROL JOINT	IFC
CL / CLNG	CENTERLINE CEILING	IMC INF
CLR	CLEAR	INS
CMP CMU	CORRUGATED METAL PIPE CONCRETE MASONRY UNIT	INS INT
CNTR	CENTER	IPC
CO	CLEAN OUT	
COL CONC	COLUMN CONCRETE	JNT JST
CONF	CONFERENCE	301
CONN	CONNECTION	K
CONN CONST	CONNECTION CONSTRUCTION	KSF KSI
CONT	CONTINUOUS	
CONTR	CONTRACTOR COORDINATE	L
COORD CORR	COORDINATE CORRUGAT(ED) (ION)	LAN LAV
CPT	CARPET	LB
CRC CSK	CHEMICAL RESISTANT COATING COUNTERSINK	LL LLV
CSP	CONCRETE SEWER PIPE	LON
CTOP	COUNTERTOP	LP
CTR / CNTR CW	CENTER CONCRETE WALL	LSL LVL
d	PENNY(NAILS)	LW
DBA	DEFORMED BAR ANCHOR	М
DBL DC	DOUBLE DEMAND CRITICAL WELD	M/E
DET / DTL	DETAIL	1AM
DET/DTL	DETAIL	MAS MA
DF DIA / ø	DRINKING FOUNTAIN / DOUGLAS FIR DIAMETER	MA)
DIAPH	DIAPHRAGM	MB
DIM DL	DIMENSION DEAD LOAD	MDI
DN	DOWN	ME
DP	DEEP	MFI MF
DR DS	DOOR DOWN SPOUT	MFF
DWG	DRAWING	MG
DWLS	DOWELS	MH MIN
(E) / EXIST	EXISTING	MIS MK
E/ EA	EDGE OF EACH	MLF
EF	EACH FACE	MO
EIFS	EXTERIOR INSULATION FINISH	MO MP
ELECT	SYSTEM ELECTRICAL	MP MTL
ELEV	ELEVATION	_
ENCR	EDGE NAIL	
ENGR EOP	ENGINEER EDGE OF PANEL	
EP	EPOXY PAINT / EDGE OF PAVEMENT	
EPDM	ETHYLENE PROPYLENE DIENE MONOMER	
EQ	EQUAL	
ES ETC	EACH SIDE EPOXY TRAFFIC COATING / ETCETERA	

FIRE DEPARTMENT CONNECTION

FACTORY FINISH / FINISHED FACE

FURNISH BY OWNER INSTALL BY

EACH WAY

EXTERIOR

FACE OF FACE OF STUD FLAT BAR FACE OF CURB FLOOR DRAIN

FINISH(ED) FLUSH

FLOOR

EXPOSED STRUCTURE

EXPANSION JOINT

FIRE EXTINGUISHER

FACTORY MUTUAL

FACE OF CONCRETE

FACE OF MASONRY FACE OF STUD FACE OF WALL FAR SIDE

FEET/FOOT FIRE TREATED

FIELD NAILING

FOUNDATION

FACE OF FINISH

CONTRACTOR

FOOTING

FINISH FLOOR ELEVATION

ETC

EXP

FOC

FOF

FTG

EXP JT / EJ

	GAUGE	(N)	NEW
/	GALVANIZED	NFPA	NATIONAL FIRE PROTECTION AGENC
	GENERAL	NIC	NOT IN CONTRACT
	GLULAM BEAM	NO. / #	NUMBER
	GLAZING	NOM	NOMINAL
	GRADE GRID ONLY	NR NS	NON RATED NEAR SIDE
	U.S. GENERAL SERVICES	NTE	NOT TO EXCEED
	ADMINISTRATION	NTS	NOT TO SCALE
BD	GYPSUM BOARD	O/A	OVERALL
	HOSE BIB	O/A OC	ON CENTER
	HOLLOW CORE / HANDICAP	OD	OUTSIDE DIAMETER
_	HOLLOW CLAY MASONRY	OFCI	OWNER FURNISHED, CONTRACTOR
-	HIGH DENSITY POLYETHELENE HEADER	OFOI	INSTALLED OWNER FURNISHED, OWNER
R	HARDWARE	01 01	INSTALLED
	HANGER	ОН	OPPOSITE HAND
	HALF LITE	OHD	OVERHEAD DOOR
	HOLLOW METAL KNOOK BOWN	OPNG OPP	OPENING OPPOSITE
	HOLLOW METAL KNOCKDOWN HOLLOW METAL WELDED	OSF / O/FACE	OUTSIDE FACE
Z	HORIZONTAL	OSSC	OREGON STRUCTURAL SPECIALTY
_)	HOUR(S)	0.70	CODE
	HEADED STUD	OTS	OPEN TO STRUCTURE
	HIGH STRENGTH BOLT	Р	PAINT
	HOLLOW STRUCTURAL STEEL HEATING	P-LAM	PLASTIC LAMINATE
;	HEATING HEATING, VENTILATION AND AIR	P.E.	PROFFESSIONAL ENGINEER
	CONDITIONING	PB	PARTICLE BOARD
	HEADED WELD STUD	PDA / PAF	POWDER DRIVEN ANCHORS/POWDEL ACTUATED FASTENER
	INTERNATIONAL BUILDING CODE	PJ	PANEL JOINT
	INSIDE DIAMETER	PL/	PLATE
	INVERT ELEVATION	PLB	PARALLAM BEAM
	INSIDE FACE	PLMB PLY / PLYWD	PLUMBING PLYWOOD
	INTERNATIONAL FIRE CODE	PNL PLTWD	PANEL
	INTERNATIONAL MECHANCIAL CODE INFORMATION	PR	PAIR
	INSPECTION / INSPECTOR	PS	POUR STRIP
L	INSULATION	PSF	POUNDS PER SQUARE FOOT
	INTERIOR	PSI PSL	POUNDS PER SQUARE INCH PARALLEL STRAND LUMBER
	INTERNATIONAL PLUMBING CODE	PT	PRESSURE TREATED / PORCELAIN
	JOINT		TILE
	JOIST	PVC PVMT	POLY VINYL CHLORIDE PAVEMENT
	KIPS		1 / WEINER
	KIPS PER SQUARE FOOT	R	RADIUS
	KIPS PER SQUARE INCH	RAD	RADIUL
		RB RBE	RUBBER BASE ROOF BASE ELEVATION
	ANGLE	RCP	REFLECTED CEILING PLAN
	LAMINATE LAVATORY	RD	ROOF DRAIN
	LAG BOLT	RECEPT	RECEPTION(IST)
	LIVE LOAD	REF	REFERENCE / REFRIGERATOR
	LONG LEG VERTICAL	REINF	REINFORCING
6 / LONGIT	LONGITUDINAL	REQ / REQ'D REV	REQUIRED REVISION
	LOWPOINT	RM	ROOM
	LAMINATED STRAND LUMBER LAMINATED VENEER LUMBER	RO	ROUGH OPENING
	LIGHTWEIGHT CONCRETE	ROW	RIGHT OF WAY
		S	STAIN
)	MIRROR	SAT	SUSPENDED ACOUSTICAL TILE
	MECHANICAL/ ELECTRICAL/ PLUMBING OR PROCESS	SC	SEALED CONCRETE / SOLID CORE
:	MANUFACTURER	SCHED	WOOD SCHEDULE
	MASONRY	SCHED	STRUCTURAL CLAY MASONRY
	MATERIAL MAYIMI IM	SF	STORE FRONT / SQUARE FEET
	MAXIMUM MACHINE BOLT	SFRS	SEISMIC FORCE RESISTING SYSTEM
MDO	MEDIUM DENSITY FIBERBOARD /	SHTG / SHT'G	SHEATHING
	OVERLAY	SIM SLRS	SIMILAR SEISMIC LOAD RESISTIVE SYSTEM
1	MECHANICAL MANUEACTURED	SLV	SHORT LEG VERTICAL
	MANUFACTURED MANUFACTURING	SMS	SHEET METAL SCREW
	MANUFACTURER	SOG	SLAB ON GRADE
	MANAGER	SP SPEC(S)	SPACE(D)(S)
	MAN HOLE	SPEC(S) SQ	SPECIFICATION(S) SQUARE
	MINIMUM MISCELLANEOUS	SS	STAINLESS STEEL / SOLID SURFACE
	MISCELLANEOUS MARK	ST	STONE
	METAL LINEAR PANEL	STA PT	STATION POINT
	MASONRY OPENING	STAGG	STANDARD
BIT	MODIFIED BITUMINOUS	STD STIFF	STANDARD STIFFENER
	METAL PANEL	STL	STEEL
	METAL	STRUCT	STRUCTURAL
		SUSP	SUSPENDED
		SV	SHEET VINYL

HW 211

WOODBURN

PROJECT SITE

GERVAIS

T&B TOF TOS TOW TPO TRANS / TRANSV VCT **VERT** VEST VFY WRGB WS

TEMPERED

TOP OF CURB

TOTAL LOAD

TOP OF FOOTING

TOP OF STEEL

TOP OF WALL

TRANSVERSE

TUBE STEEL

UNDERSIDE

VERTICAL

VERIFY

VESTIBULE

VERIFY IN FIELD

VISION PANEL

RESISTANCE

WORK POINT WATER RESISTANT

WITHOUT WOOD BASE

UNDER COUNTER

TYPICAL

TOE NAIL

TOP OF

TOP OF

TOP AND BOTTOM

THICK / THICKNESS

TEMPERATURE / TEMPORARY

THERMOPLASTIC POLYOLEFIN

UNDER WRITERS LABORATORIES

UNLESS NOTED OTHERWISE

UNITED STATES GYPSUM

VINYL COMPOSITION TILE

COATING WITH CHEMICAL

WIDE FLANGE BEAM WATER HEATER

WATER CLOSET / WALL COVERING

WATER PROOF / WOOD PANELING /

WATER RESISTANT GYPSUM BOARD

WATER STOP / WELDED STUD WELDED WIRE FABRIC WELDED WIRE MESH

OWNER

DO IT BEST CORP. 333 S WOODLAND AVE WOODBURN, OR 97071 TELEPHONE: 260-748-5533 CONTACT: TIM MILLER EMAIL: TIM.MILLER@DOITBEST.COM

GENERAL CONTRACTOR

PERLO CONSTRUCTION 11450 SW AMU STREET TUALATIN, OR 97062 TELEPHONE: 503-624-2090 CONTACT: ADAM SMELLEY EMAIL: ASMELLEY@PERLO.BIZ

SURVEY CONSULTANT

AKS ENGINEERING AND FORESTRY, LLC. 3700 RIVER RD N, STE 1 KEIZER, OR 97303 TELEPHONE: 503-400-6028 CONTACT: JOSEPH SULLIVAN

ARCHITECT

MACKENZIE 1515 SE WATER AVE, SUITE 100 PORTLAND, OR 97214 TELEPHONE: 503-224-9560 ARCHITECT: SCOTT MOORE CONTACT: RYAN WESTON EMAIL: RWESTON@MCKNZE.COM

CIVIL ENGINEER

MACKENZIE 1515 SE WATER AVE, SUITE 100 PORTLAND, OR 97214 TELEPHONE: 503-224-9560 ENGINEER: NICOLE BURRELL CONTACT: NICOLE BURRELL EMAIL: NBURRELL@MCKNZE.COM

STRUCTURAL ENGINEER

MACKENZIE 1515 SE WATER AVE, SUITE 100 PORTLAND, OR 97214 TELEPHONE: 503-224-9560 ENGINEER: TBD CONTACT: TBD

LANDSCAPE ARCHITECT

MACKENZIE 1515 SE WATER AVE, SUITE 100 PORTLAND, OR 97214 TELEPHONE: 503-224-9560 LA ARCHITECT: CONTACT: NICOLE FERREIRA EMAIL: NFERREIRA@MCKNZE.COM

PROJECT GENERAL NOTES

- THE DRAWINGS LOCATE PRODUCTS, SURFACES, AND MATERIALS AND THE NOTES CONVEY DESIGN INTENT. THE PROJECT INTENT IS TO PROVIDE FOR A
- COMPLETE, WORKING SYSTEM. ALL WORKMANSHIP AND MATERIALS SHALL CONFORM TO THE LATEST ADOPTED BUILDING CODE EDITION, AND TO CONDITIONS AND SPECIFICATIONS
- OF ALL GOVERNING AUTHORITIES. VERIFY AND CONFIRM ALL CONDITIONS, DIMENSIONS, AND LAYOUT INFORMATION PRIOR TO START OF CONSTRUCTION. NOTIFY MACKENZIE OF ANY DISCREPANCIES PRIOR TO START OF WORK. ANY CORRECTION WORK REQUIRED AS A RESULT OF NOT REPORTING SUCH DISCREPANCIES SHALL BE PERFORMED AT NO ADDITIONAL COST TO THE OWNER. CONTRACTOR AND SUBCONTRACTORS SHALL CAREFULLY EXAMINE THE SITE
- INCONSISTENCIES IN THE PLANS OR SPECIFICATIONS SHALL BE CALLED TO THE ATTENTION OF MACKENZIE. REFER TO ENLARGED PLANS AND ELEVATIONS WHERE INDICATED FOR ADDITIONAL INFORMATION. ENLARGED PLANS TAKE PRECEDENCE OVER PLANS OF SMALLER SCALE, AND DETAILS TAKE PRECEDENCE OVER PLANS. IN THE

AND THE CONSTRUCTION DOCUMENTS OF THE ENTIRE WORK.


- CASE OF A CONFLICT, THE HIGHEST COST OPTION SHOULD BE PRICED. DETAIL REFERENCES SHALL BE APPLIED TO ALL INSTANCES WHERE THE SAME CONDITIONS OCCUR, UNLESS NOTED OTHERWISE. THE TERMS "ABOVE FINISH FLOOR" (AFF) AND "FINISH FLOOR ELEVATION" (FFE)
- REFER TO FINAL FINISHED FLOOR ELEVATION, WHETHER BUILT-UP SLAB, COMPOSITE DECK, OR RAISED ACCESS FLOOR. DO NOT SCALE DRAWINGS.
- CUTTING AND DRILLING OF STRUCTURAL MEMBERS NOT DETAILED REQUIRES THE WRITTEN PERMISSION OF THE STRUCTURAL ENGINEER OF RECORD. FINISH FLOOR ELEVATION OF 0'-0" = 273.00' AS INDICATED ON CIVIL DRAWINGS. SAVE AND RECYCLE DEMOLITION DEBRIS AS APPLICABLE. ALL DEMOLISHED OR REMOVED EXISTING MATERIAL SHALL BE LEGALLY DISPOSED. COORDINATE
- WITH CITY OF VANCOUVER REQUIREMENTS FOR RECYCLING/RE-USE OF DEMOLITION DEBRIS. THE CONTRACTOR IS RESPONSIBLE FOR ANY DAMAGE RESULTING FROM THEIR WORK. THE CONTRACTOR WILL COORDINATE CLEAN UP OF ALL AREAS AFFECTED BY DUST OR ANY MATERIALS, BOTH DURING CONSTRUCTION AND UPON COMPLETION OF THE PROJECT, INCLUDING THE INSIDE OF ALL WINDOWS AS NECESSARY SO THAT THE SPACE IS READY FOR OCCUPANCY BY
- ALL DESIGN-BUILD ITEMS, SYSTEMS, AND ELEMENTS ARE TO BE SUBMITTED FOR REVIEW AND APPROVED BY MACKENZIE. EXISTING MATERIAL NOTED TO BE RETURNED TO THE OWNER SHALL BE

SAFELY STORED AND PROTECTED UNTIL IT IS REMOVED FROM THE SITE BY

SYMBOLS AND REFERENCES

REVISION CLOUD

EMAIL: TBD

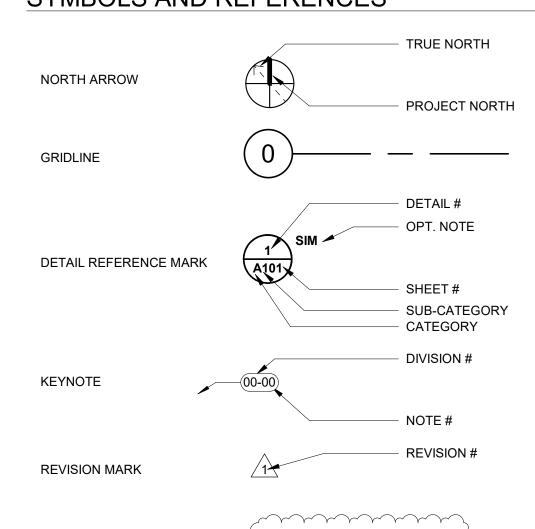

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PHOTOMETRIC DRAWINGS

1 OF 2 PHOTOMETRICS SITE

2 OF 2 PHOTOMETRICS OFFICE

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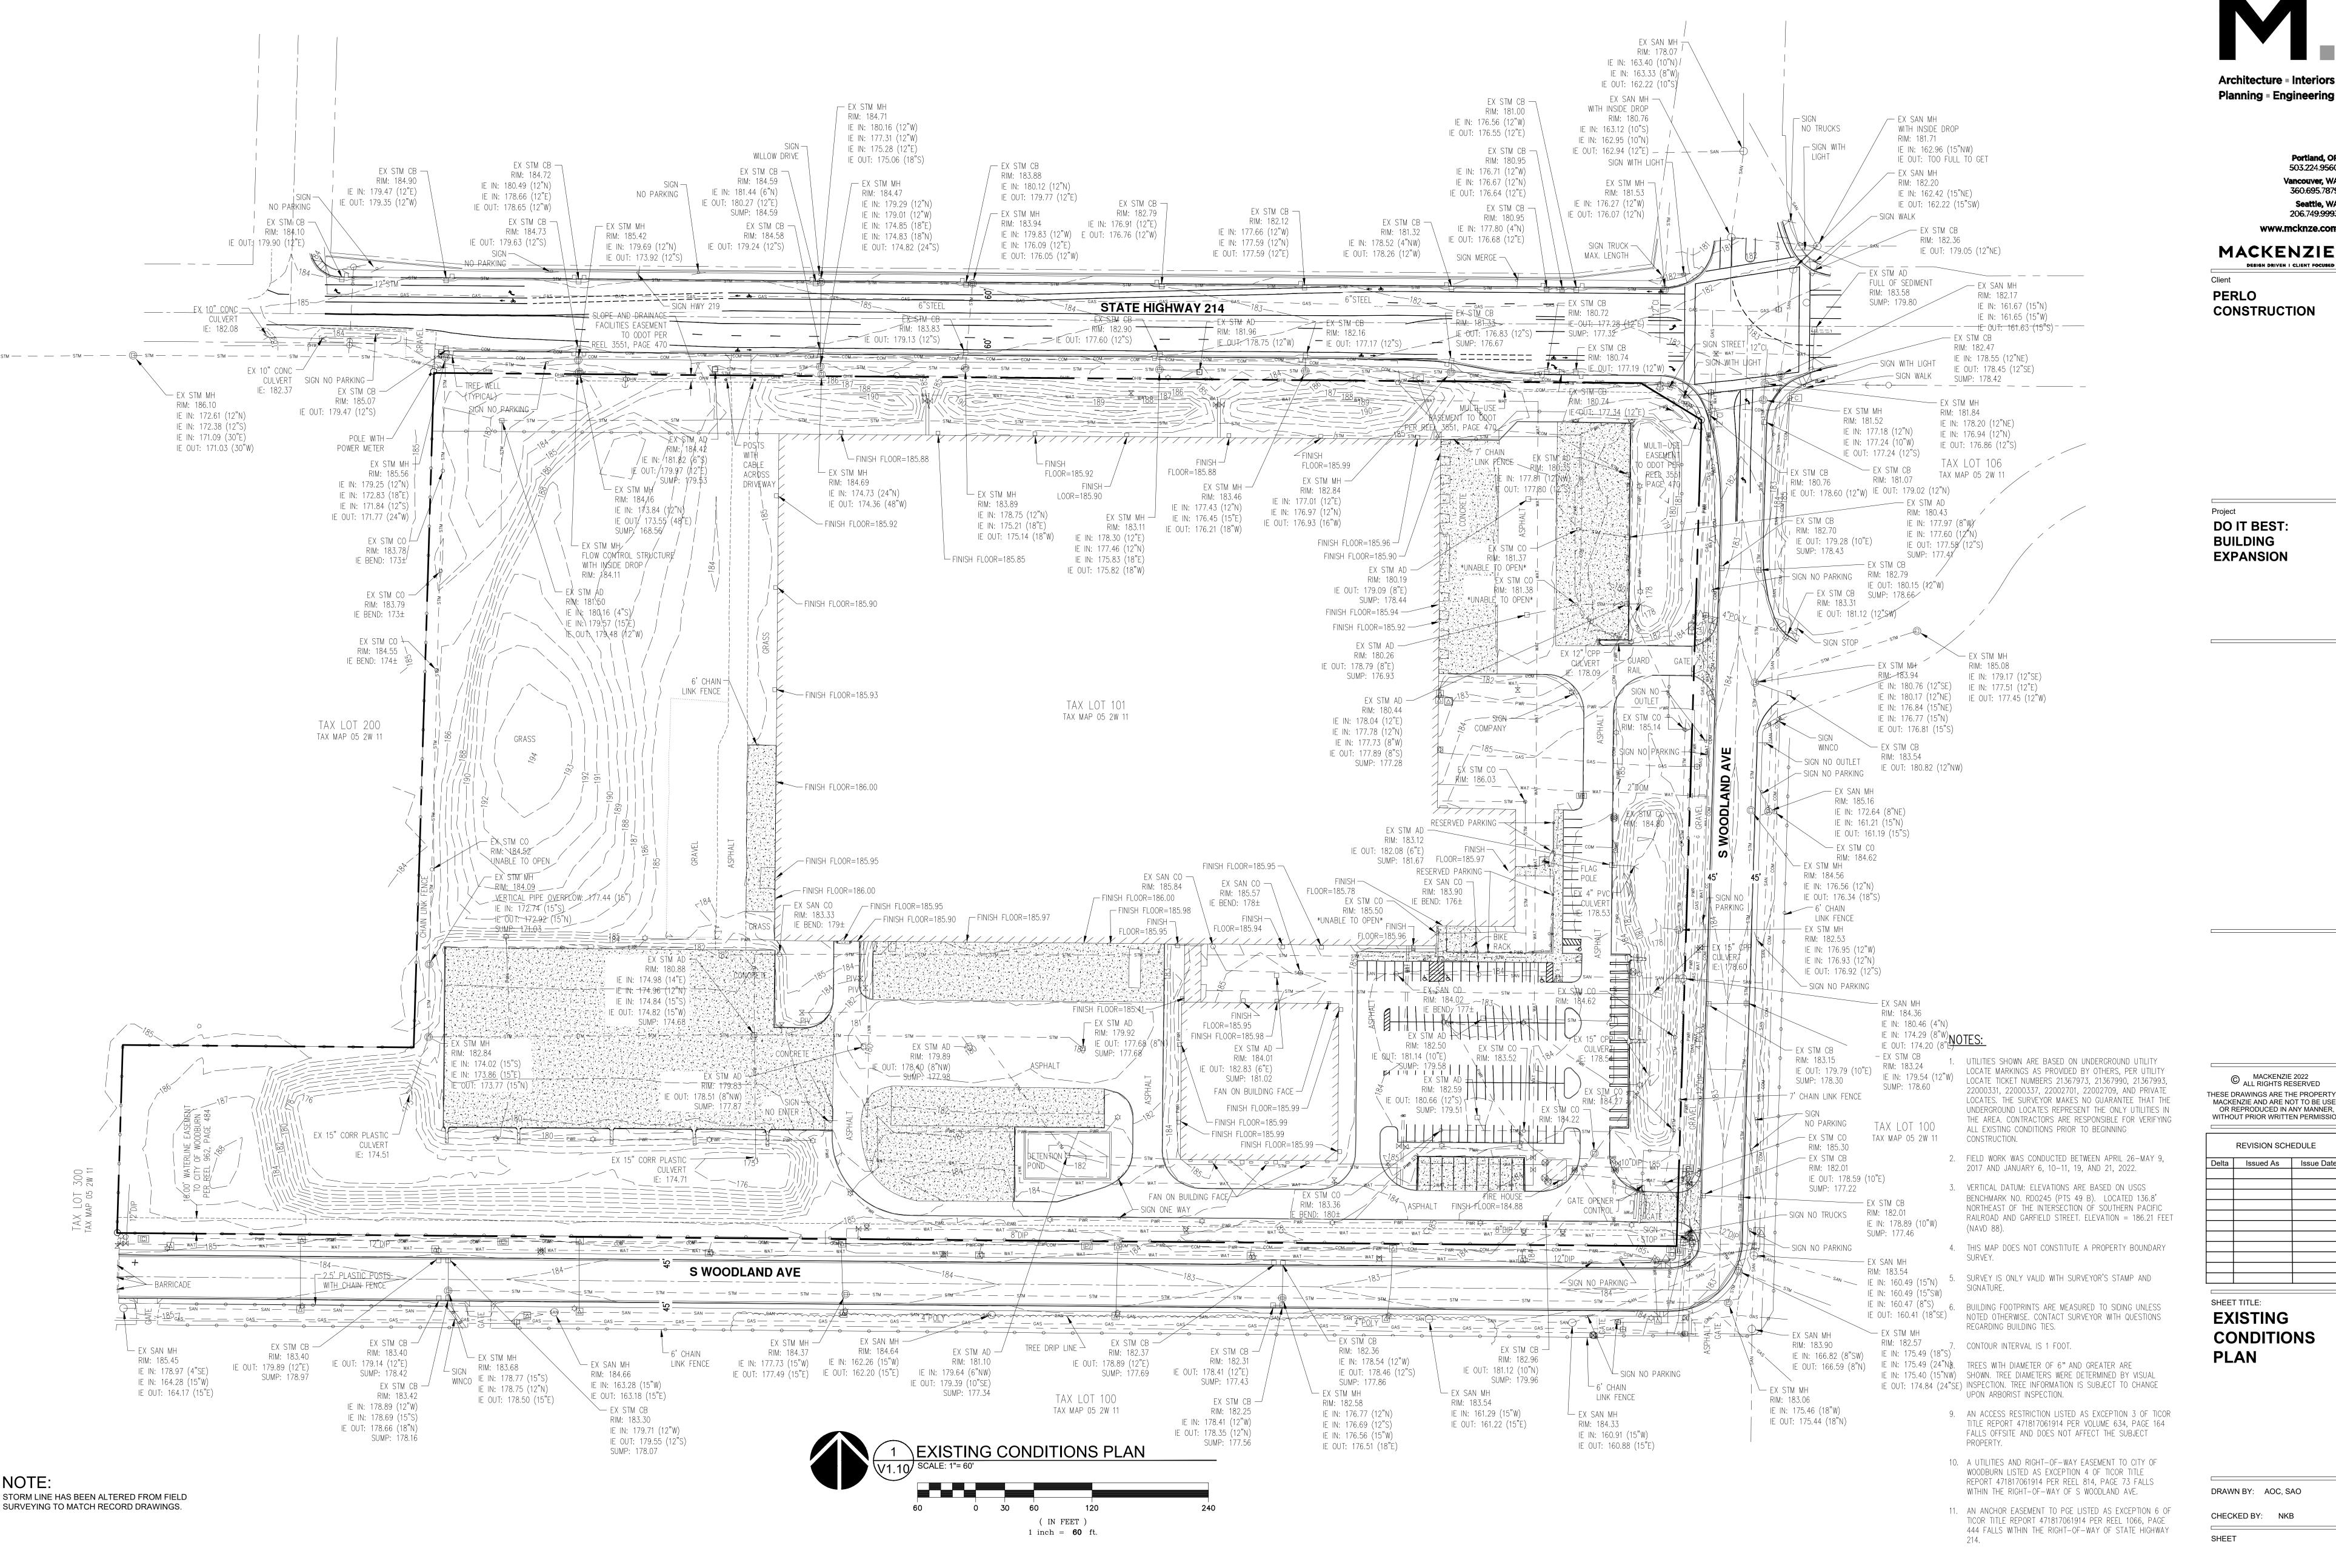
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TITLE SHEET **INDEX**

ATTACHMENT 104

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G0.01





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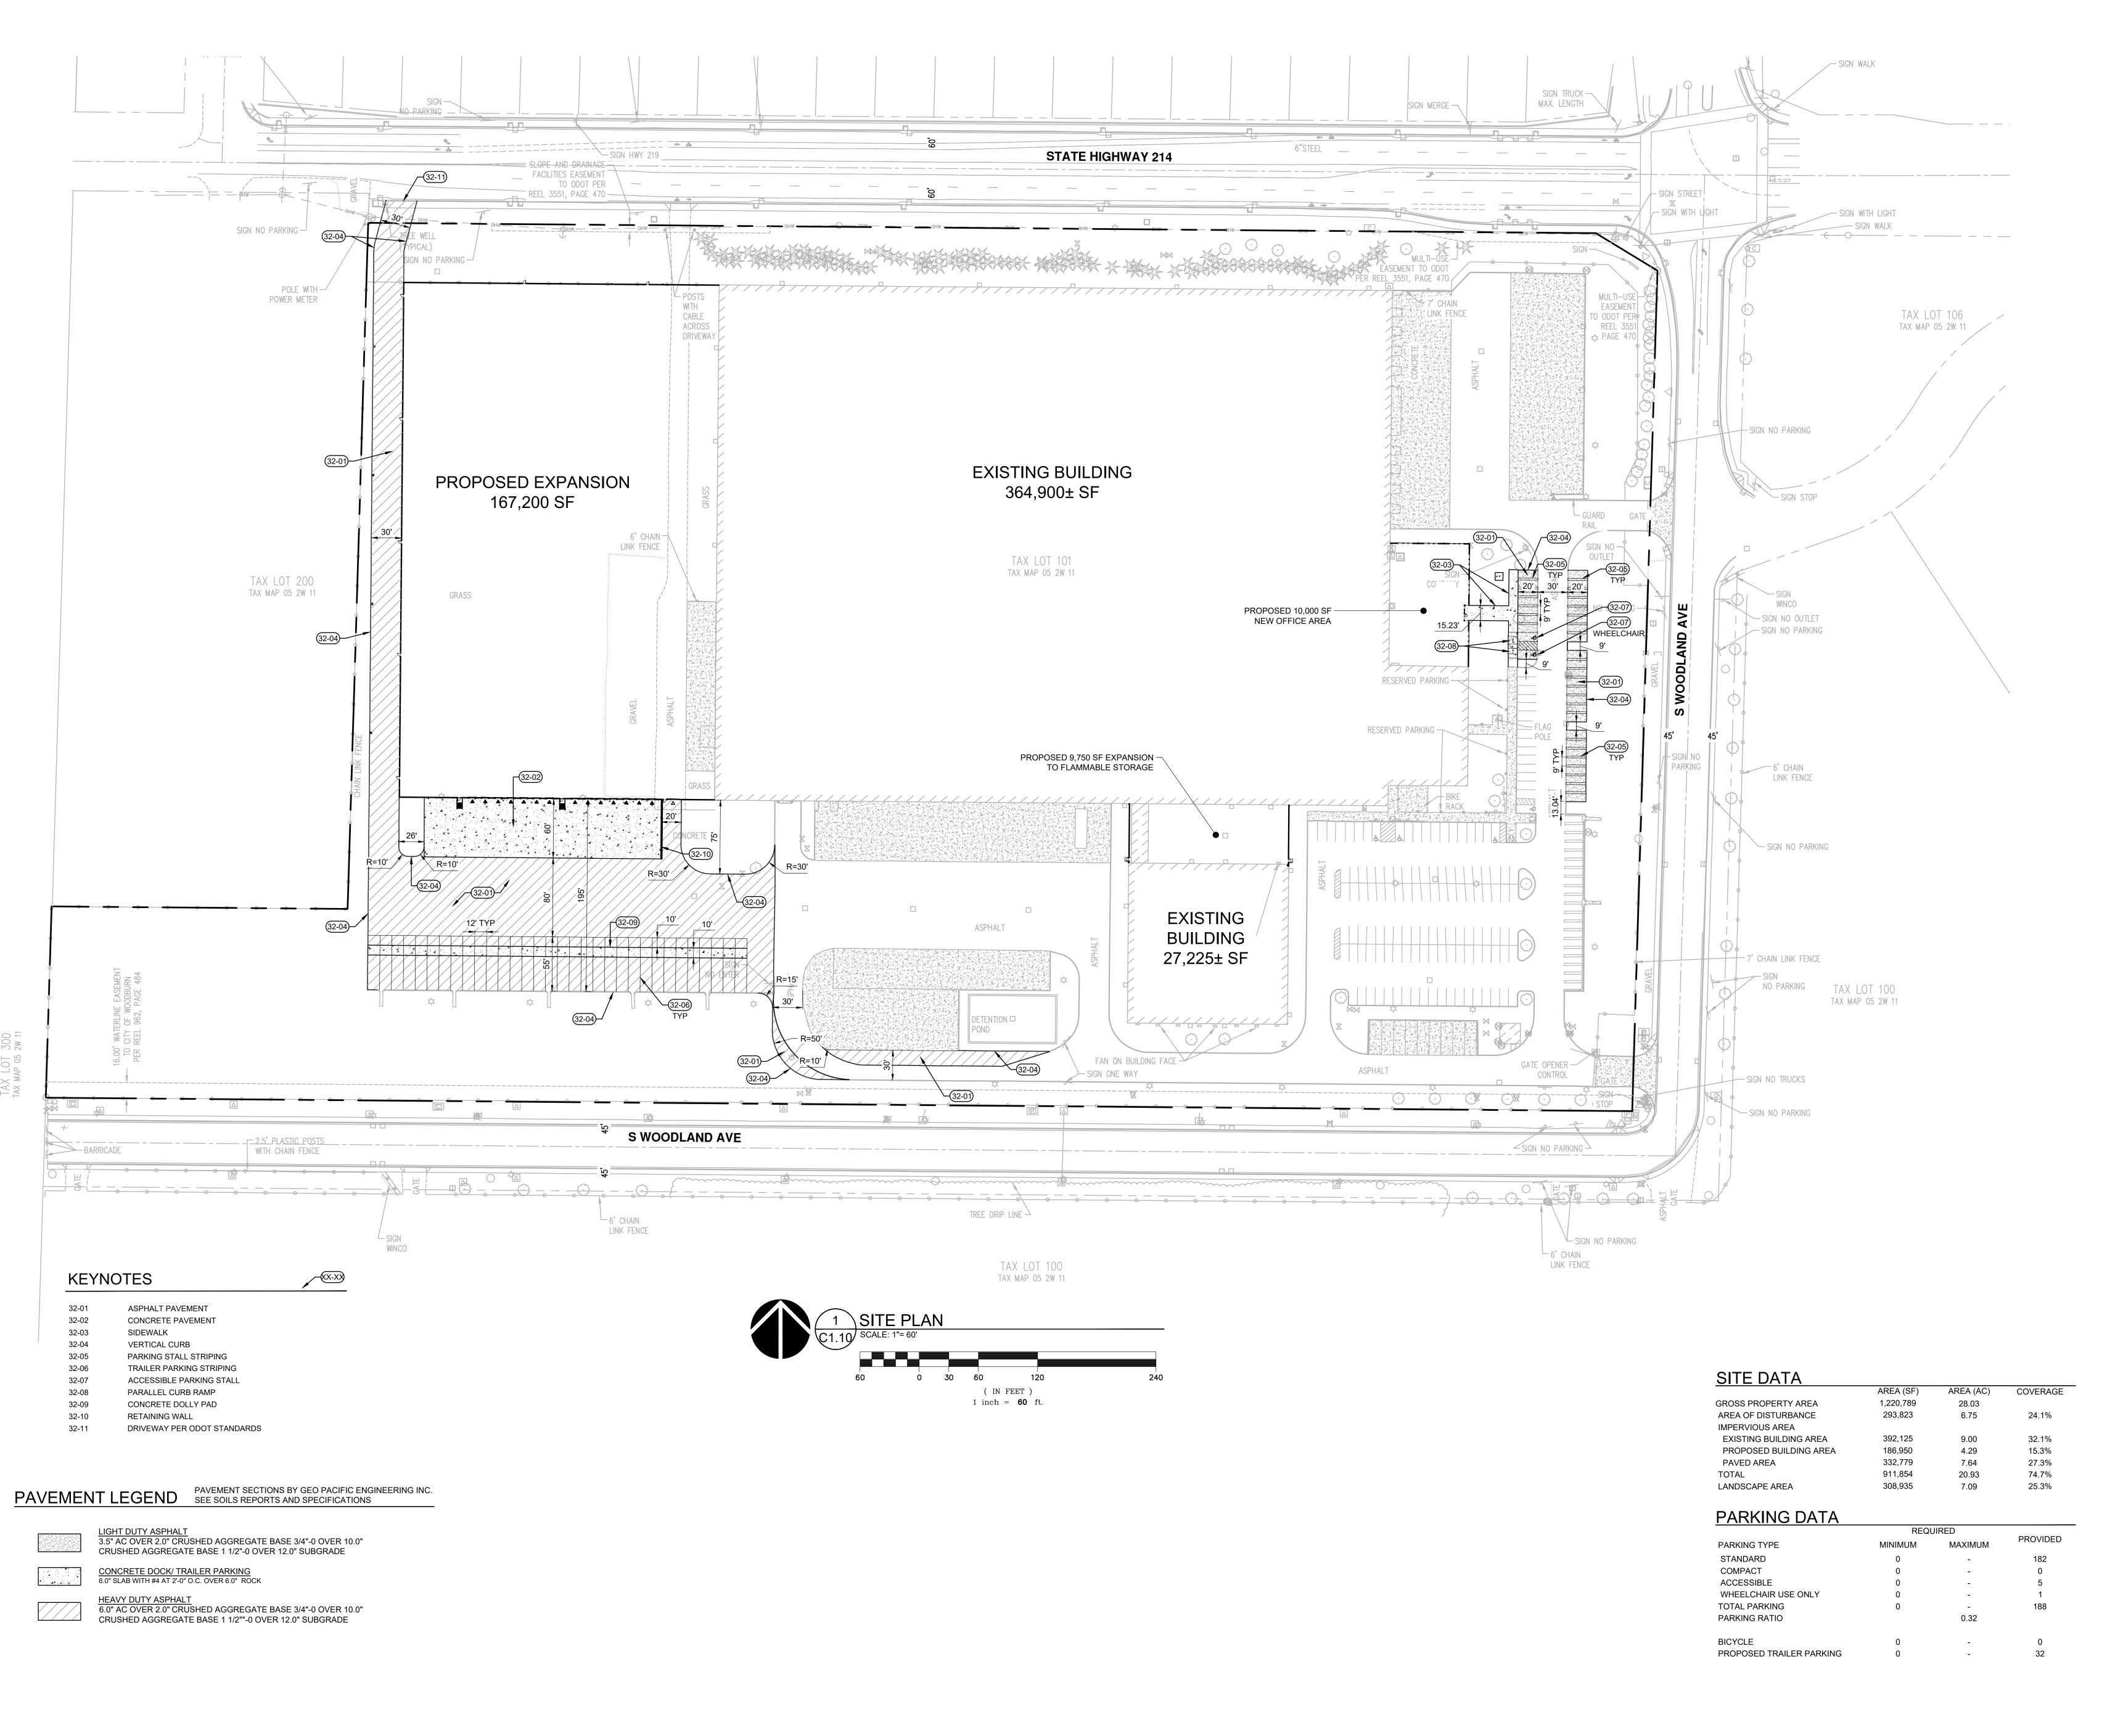
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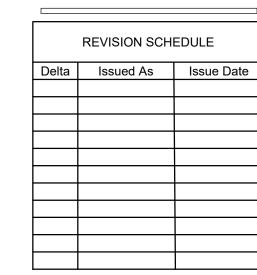
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OVERALL SITE


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CHECKED BY: NKB

SHEET

C1.10



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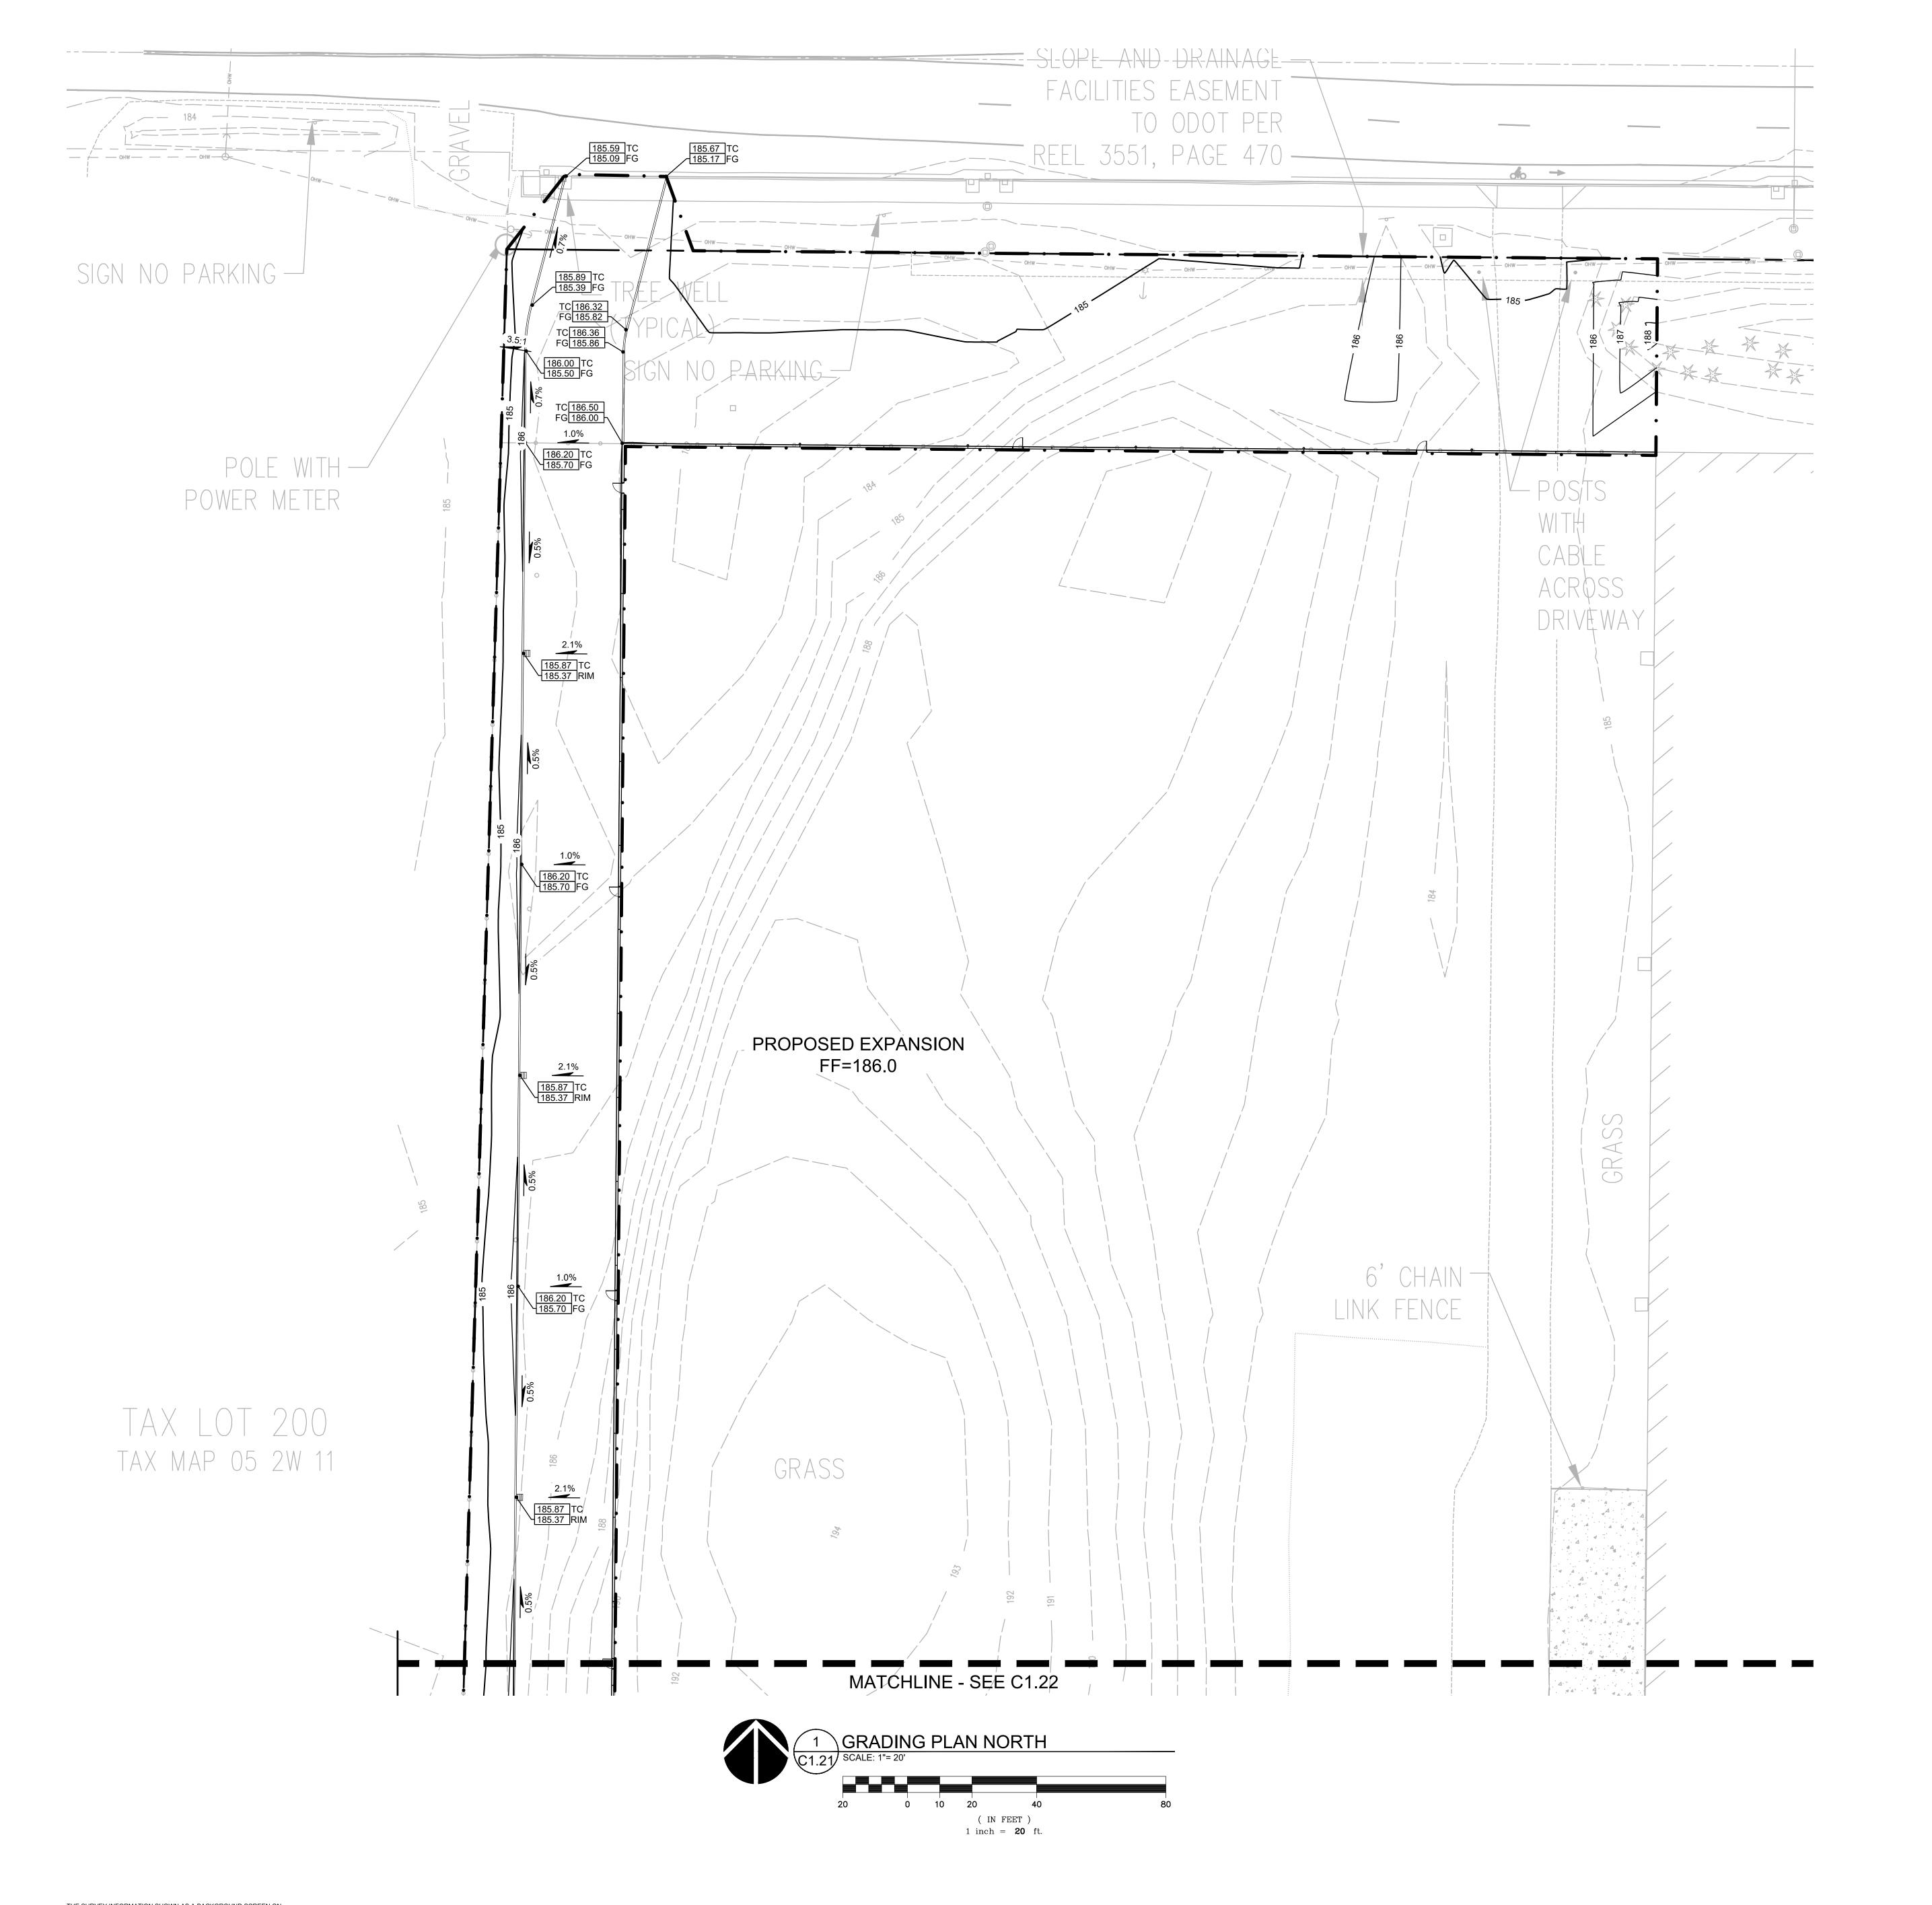
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SHEET TITLE:
OVERALL
GRADING PLAN

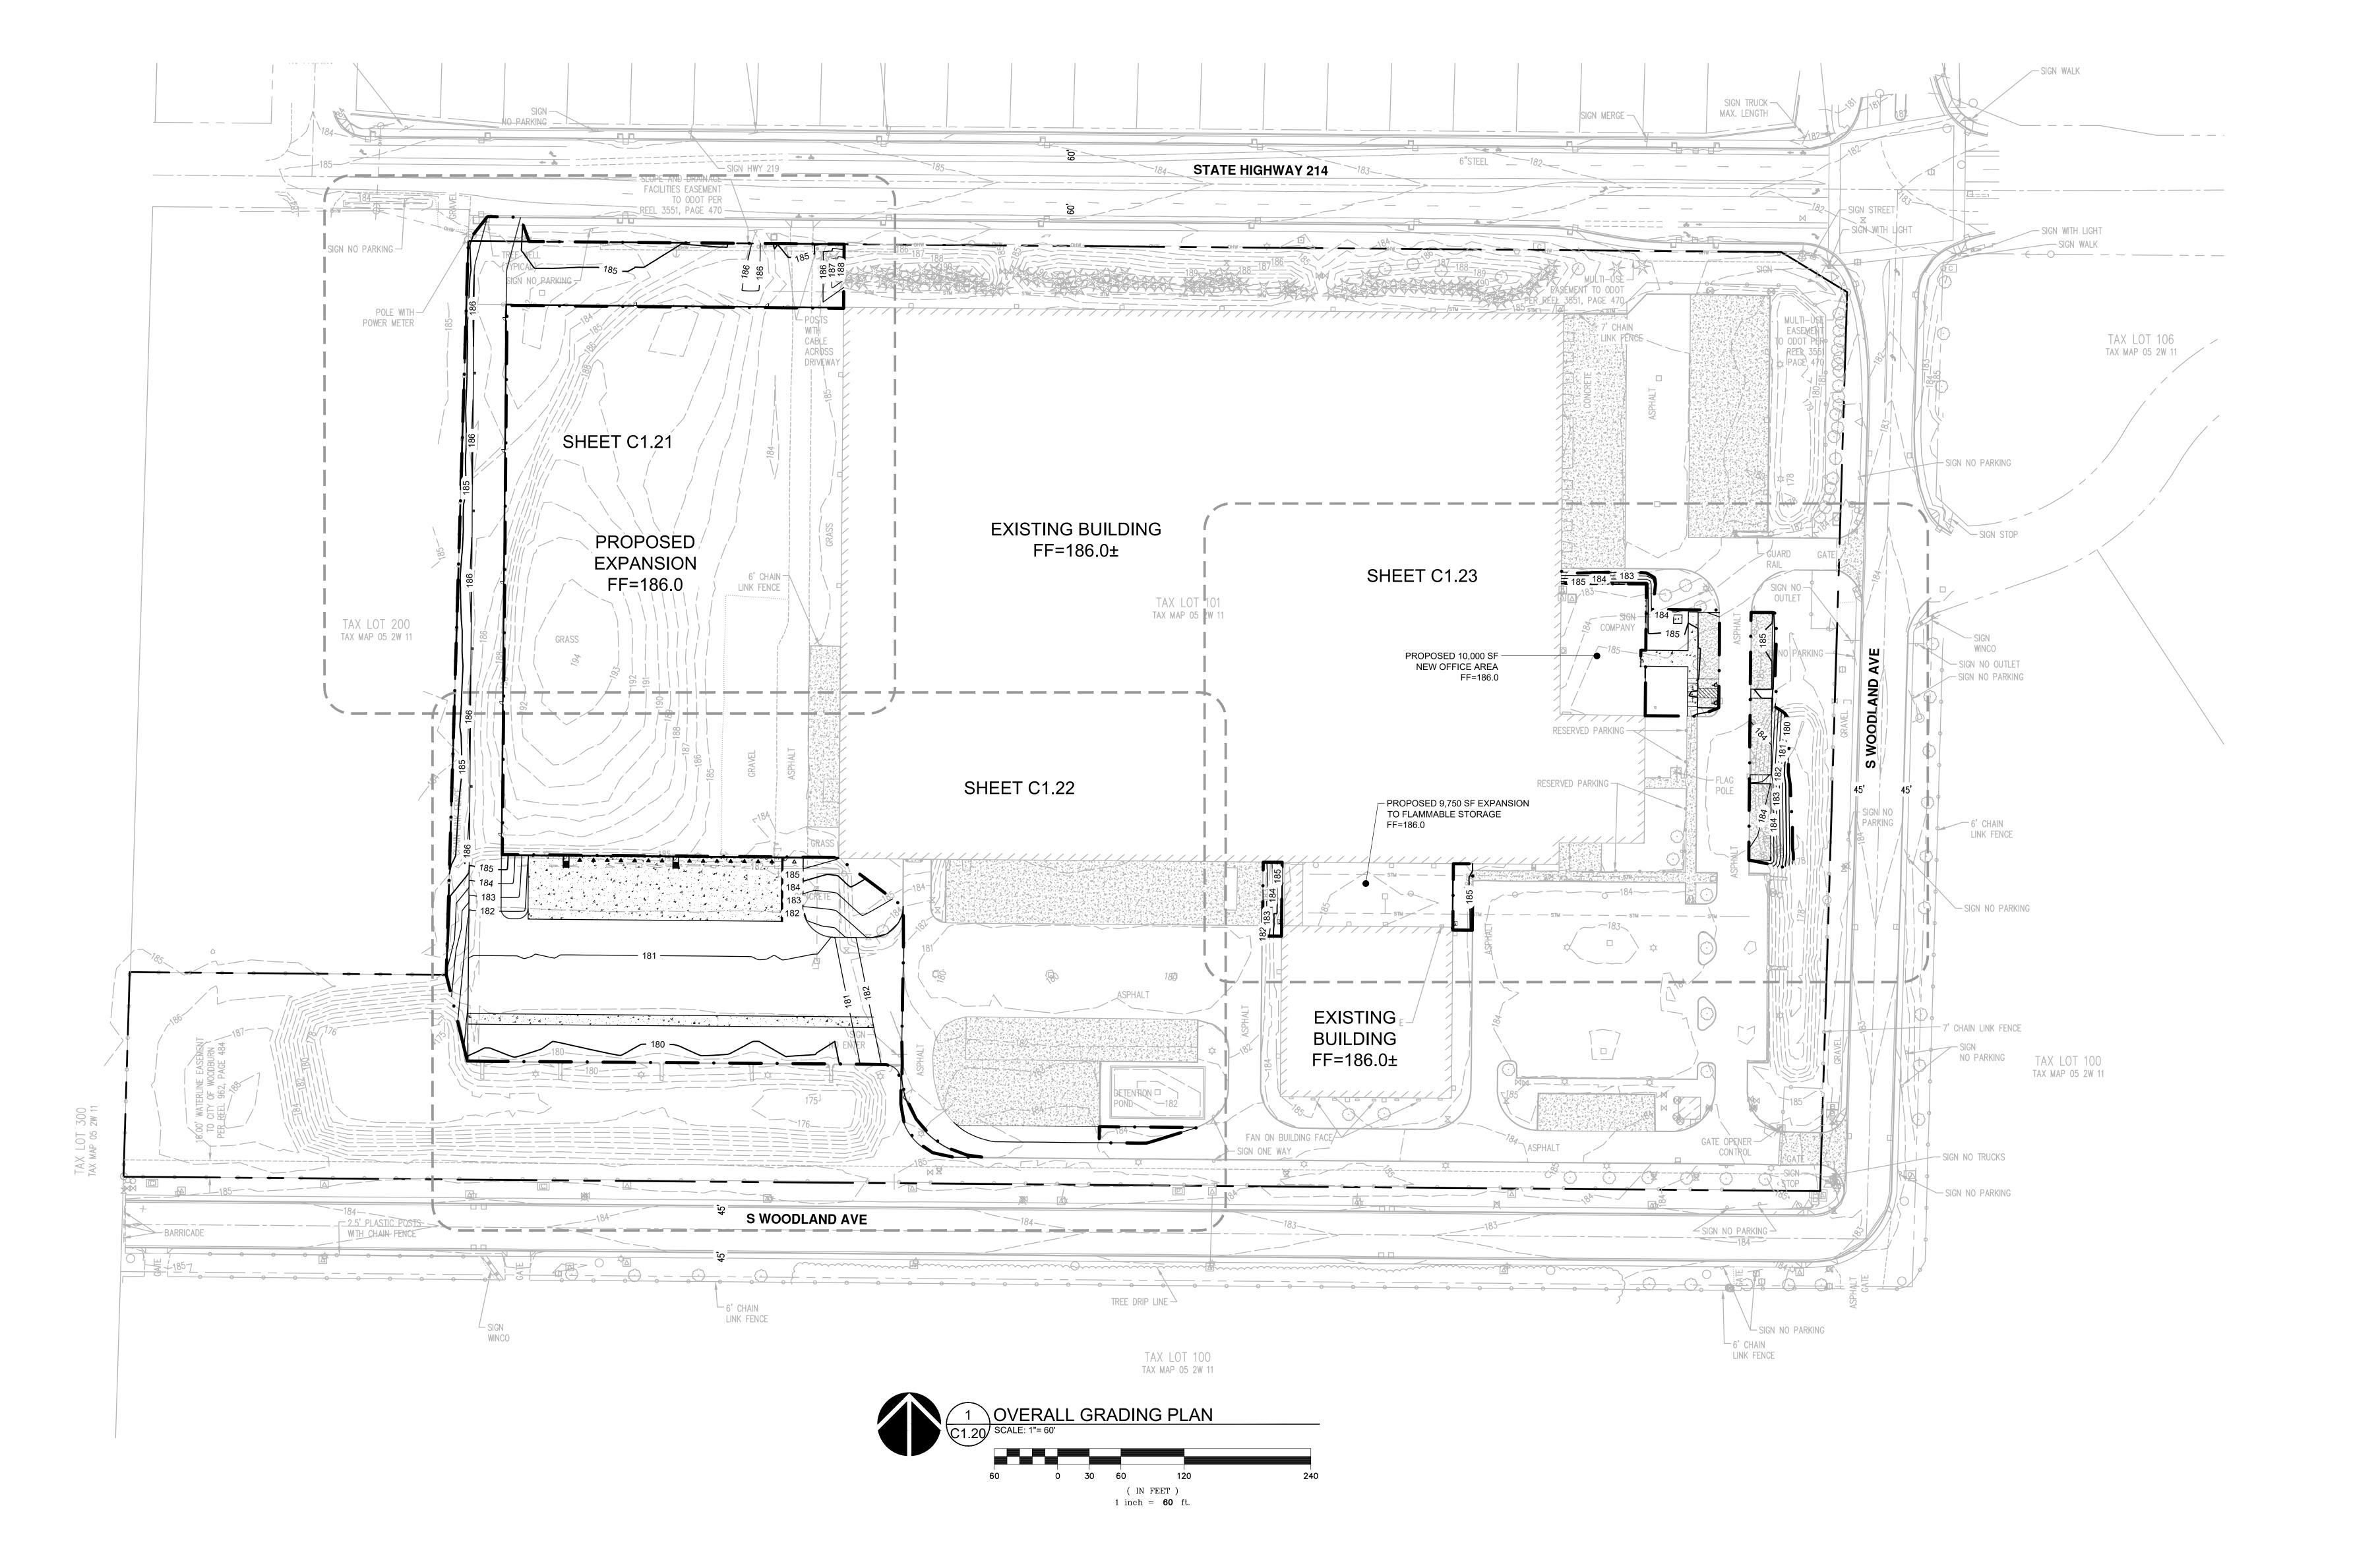DRAWN BY:

HEET

C1.20





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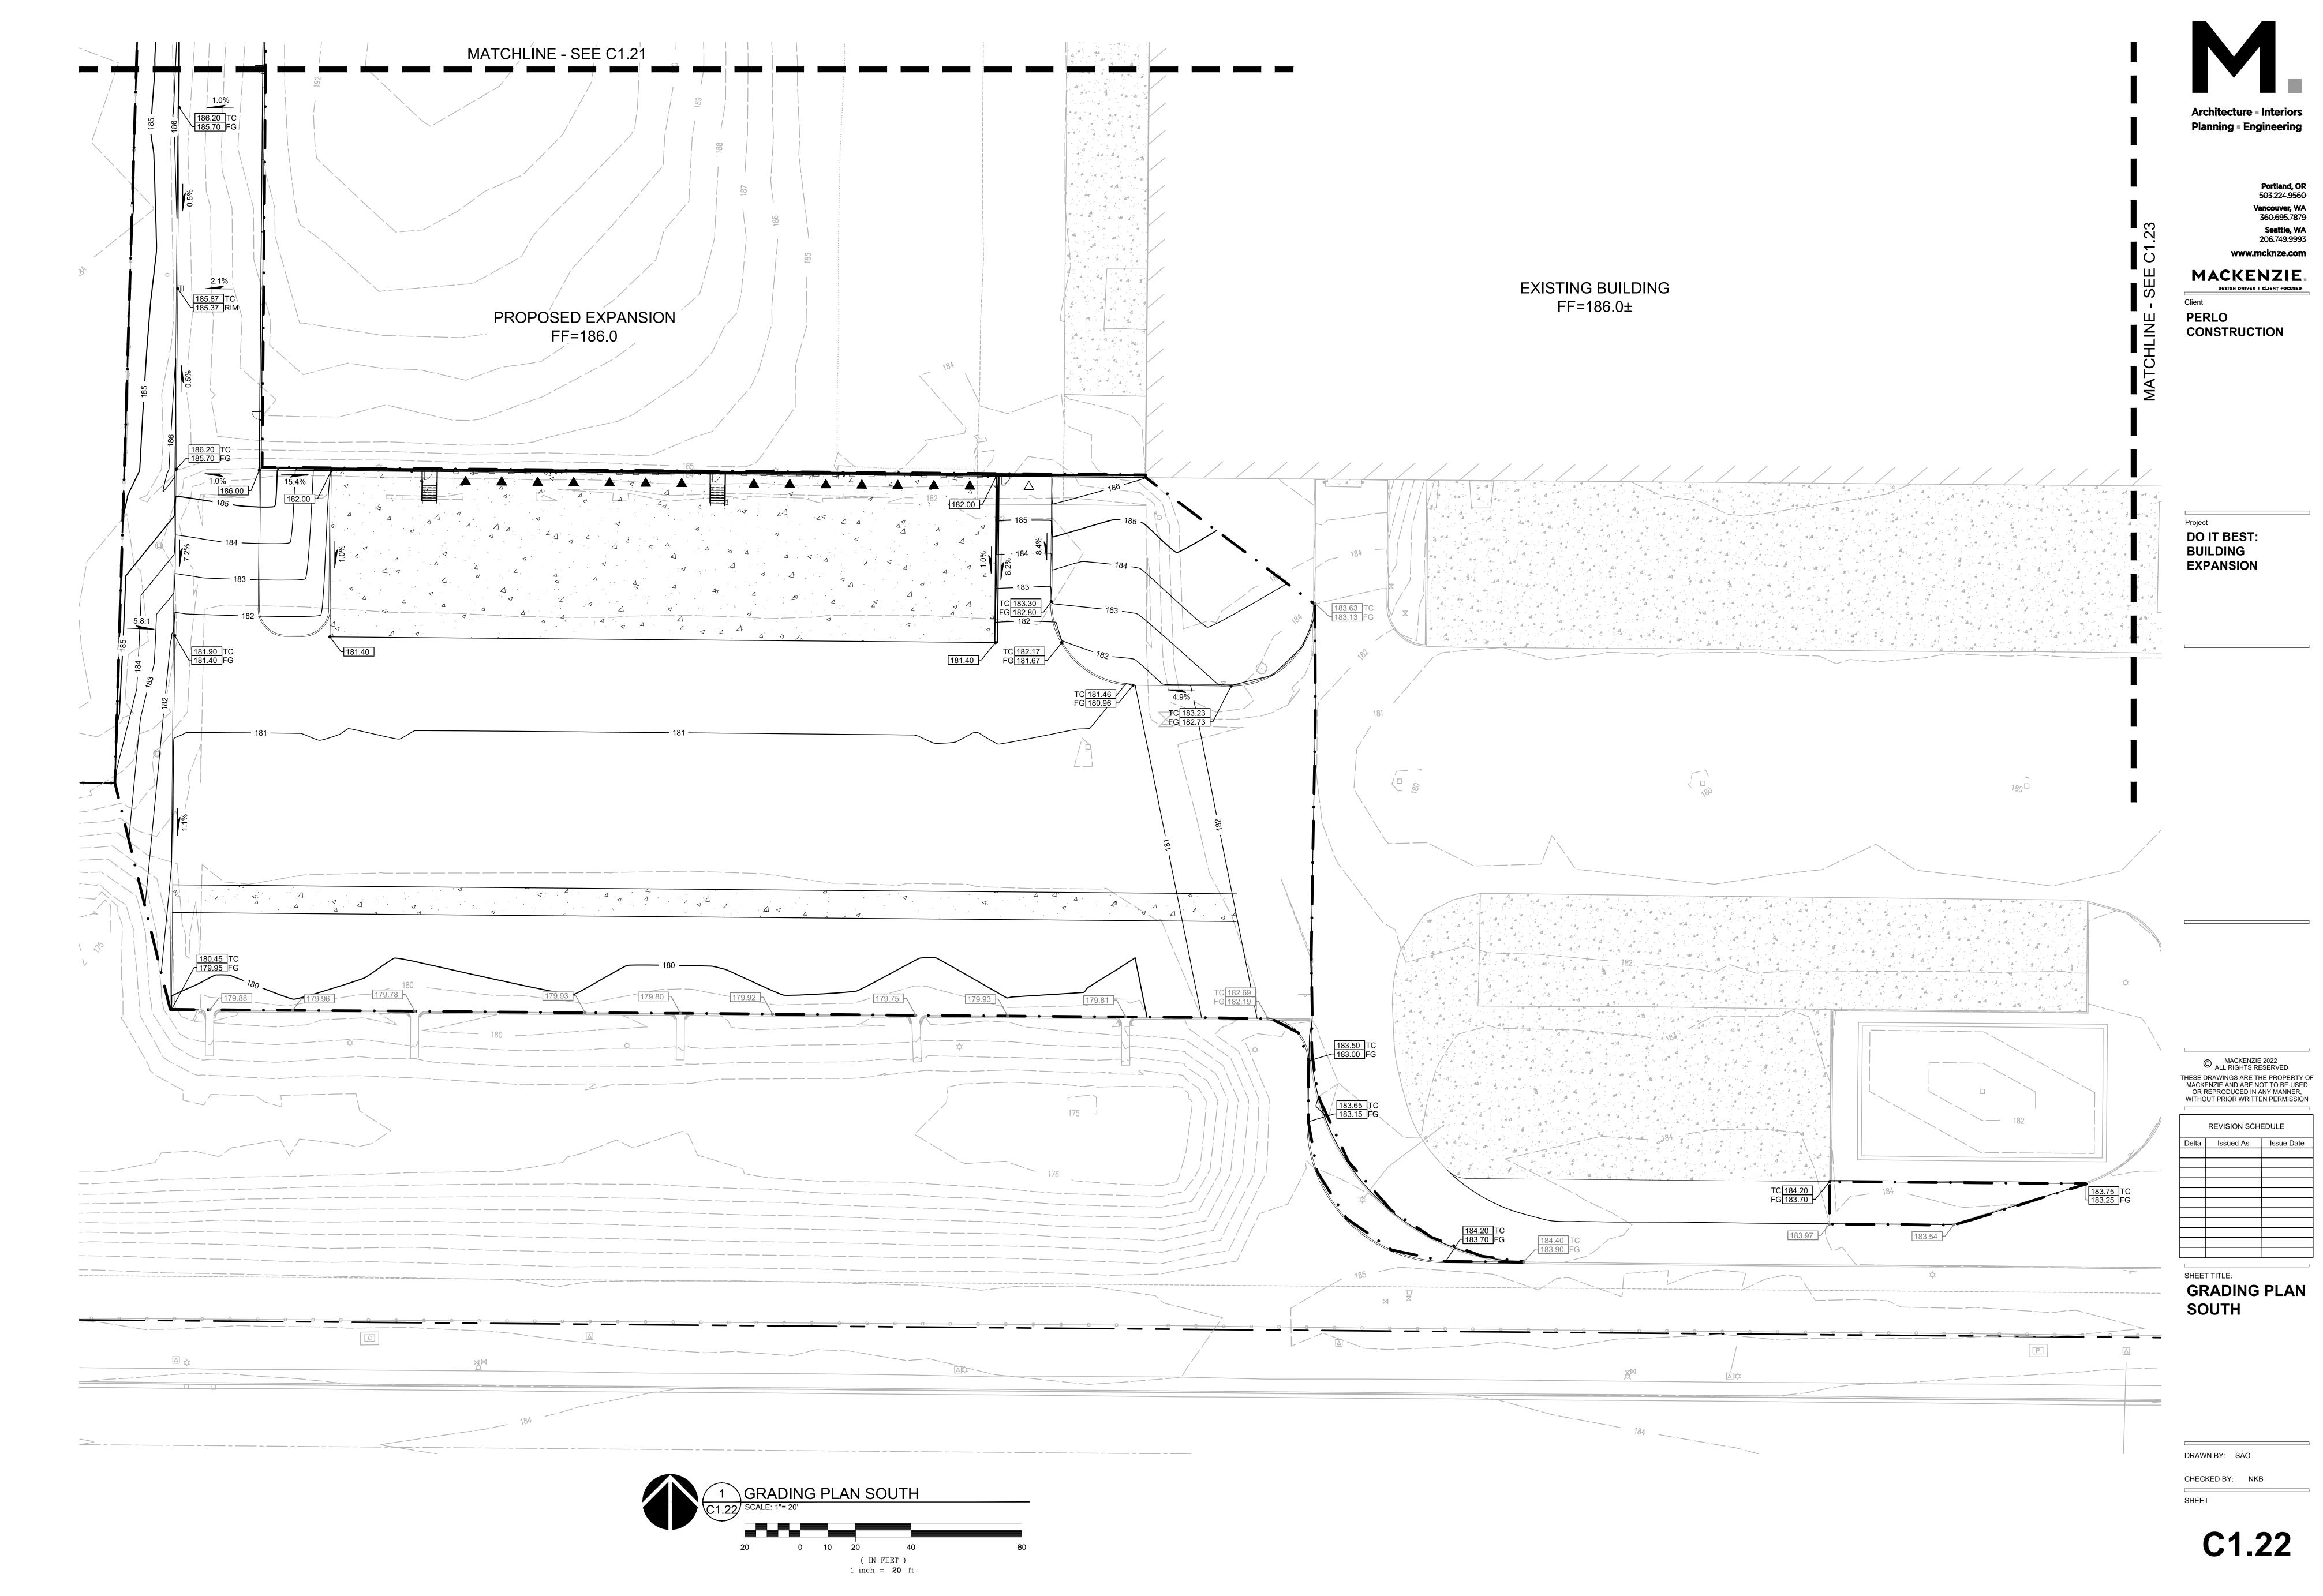
GRADING PLAN


NORTH

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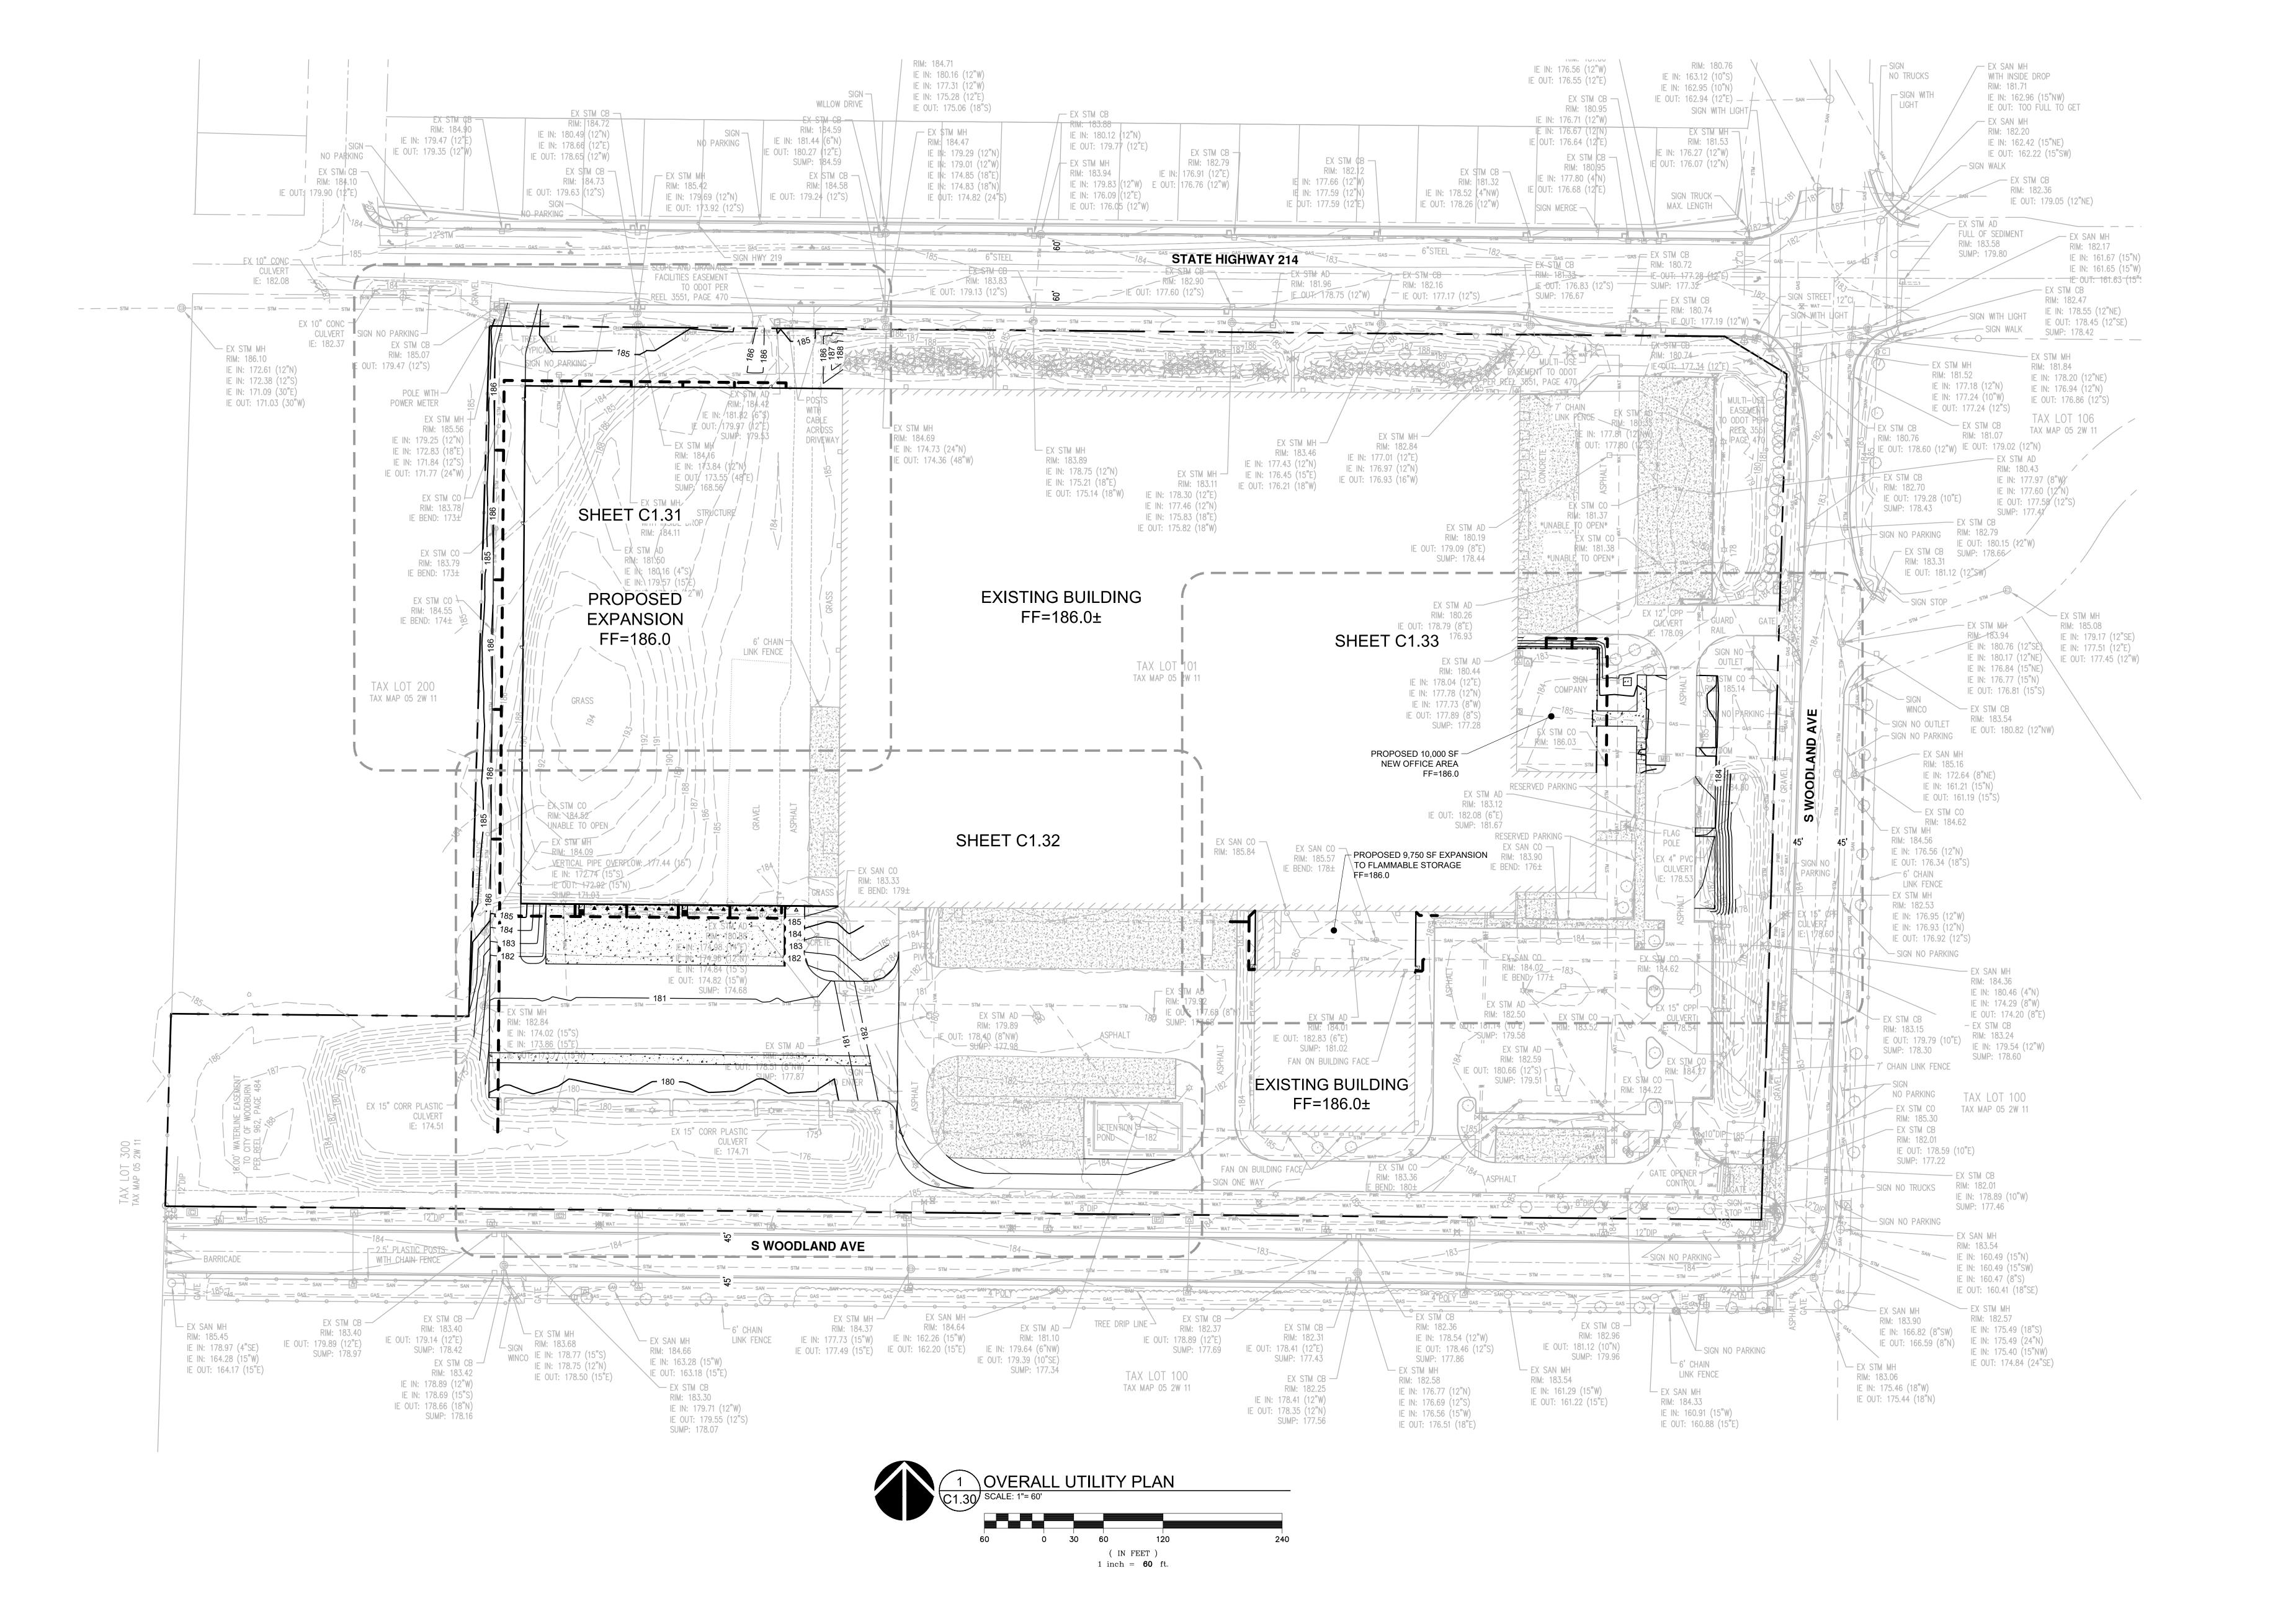
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GRADING PLAN EAST

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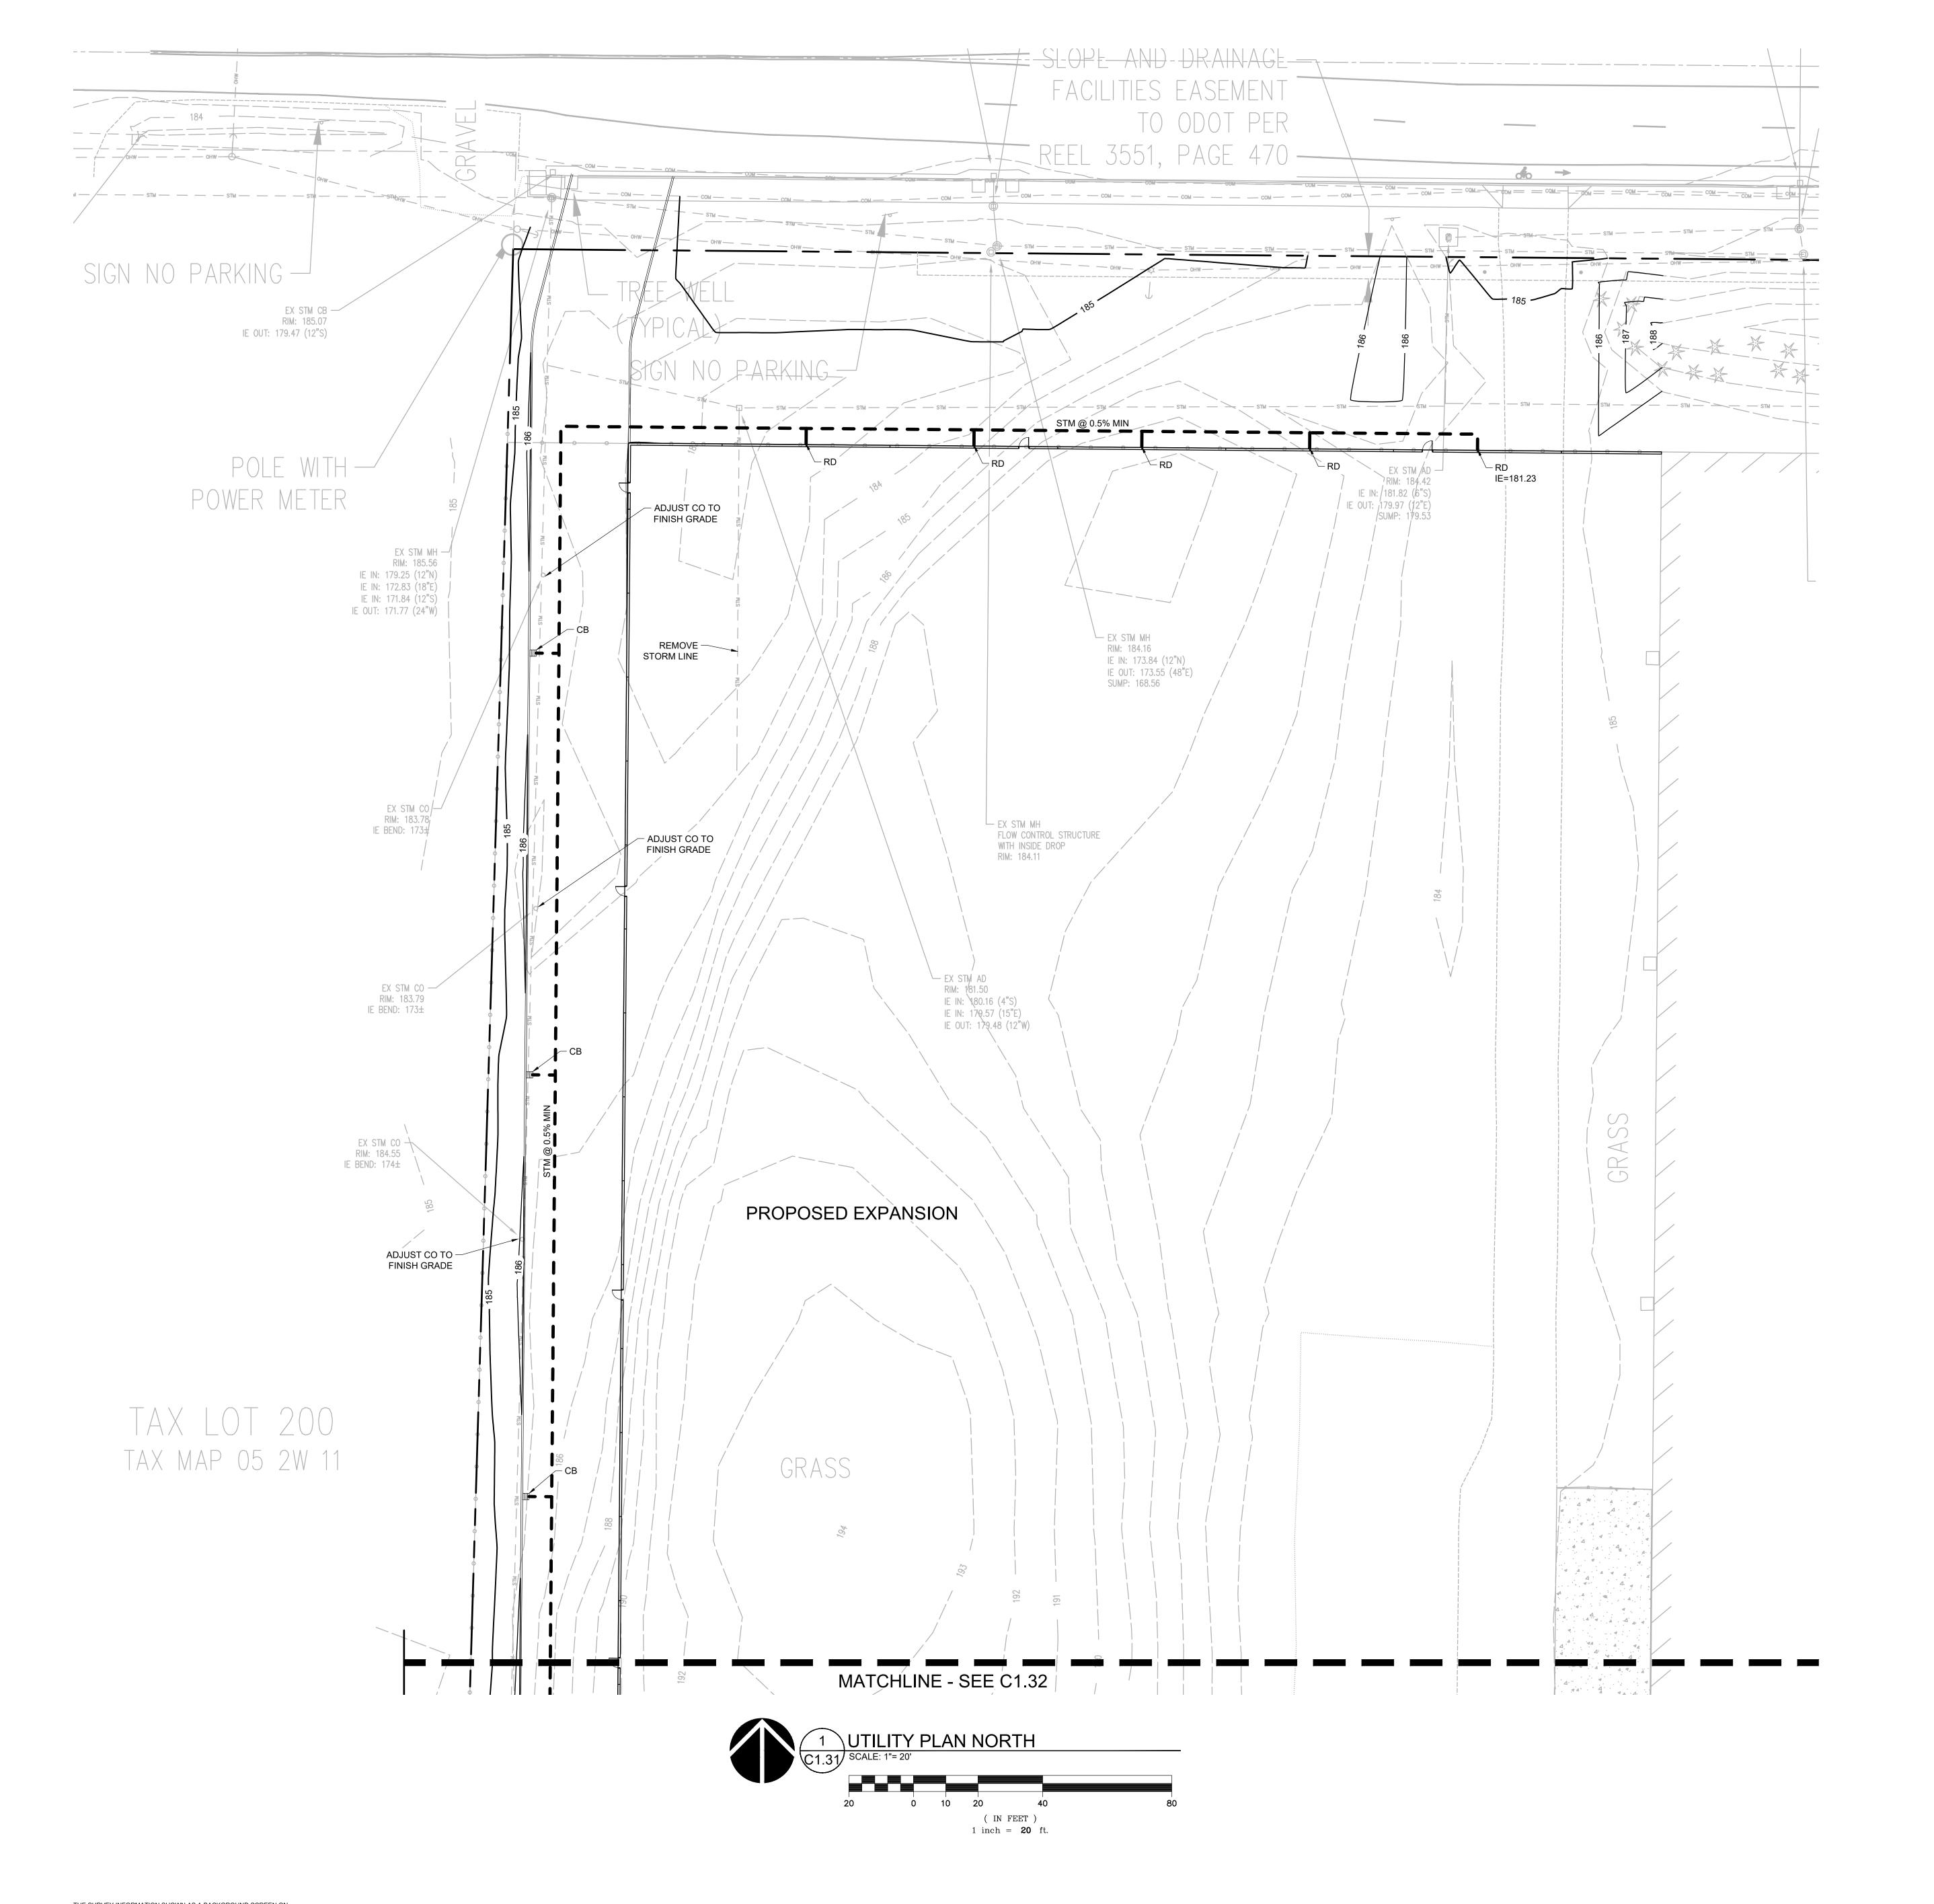
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OVERALL UTILITY PLAN

SHEET TITLE:

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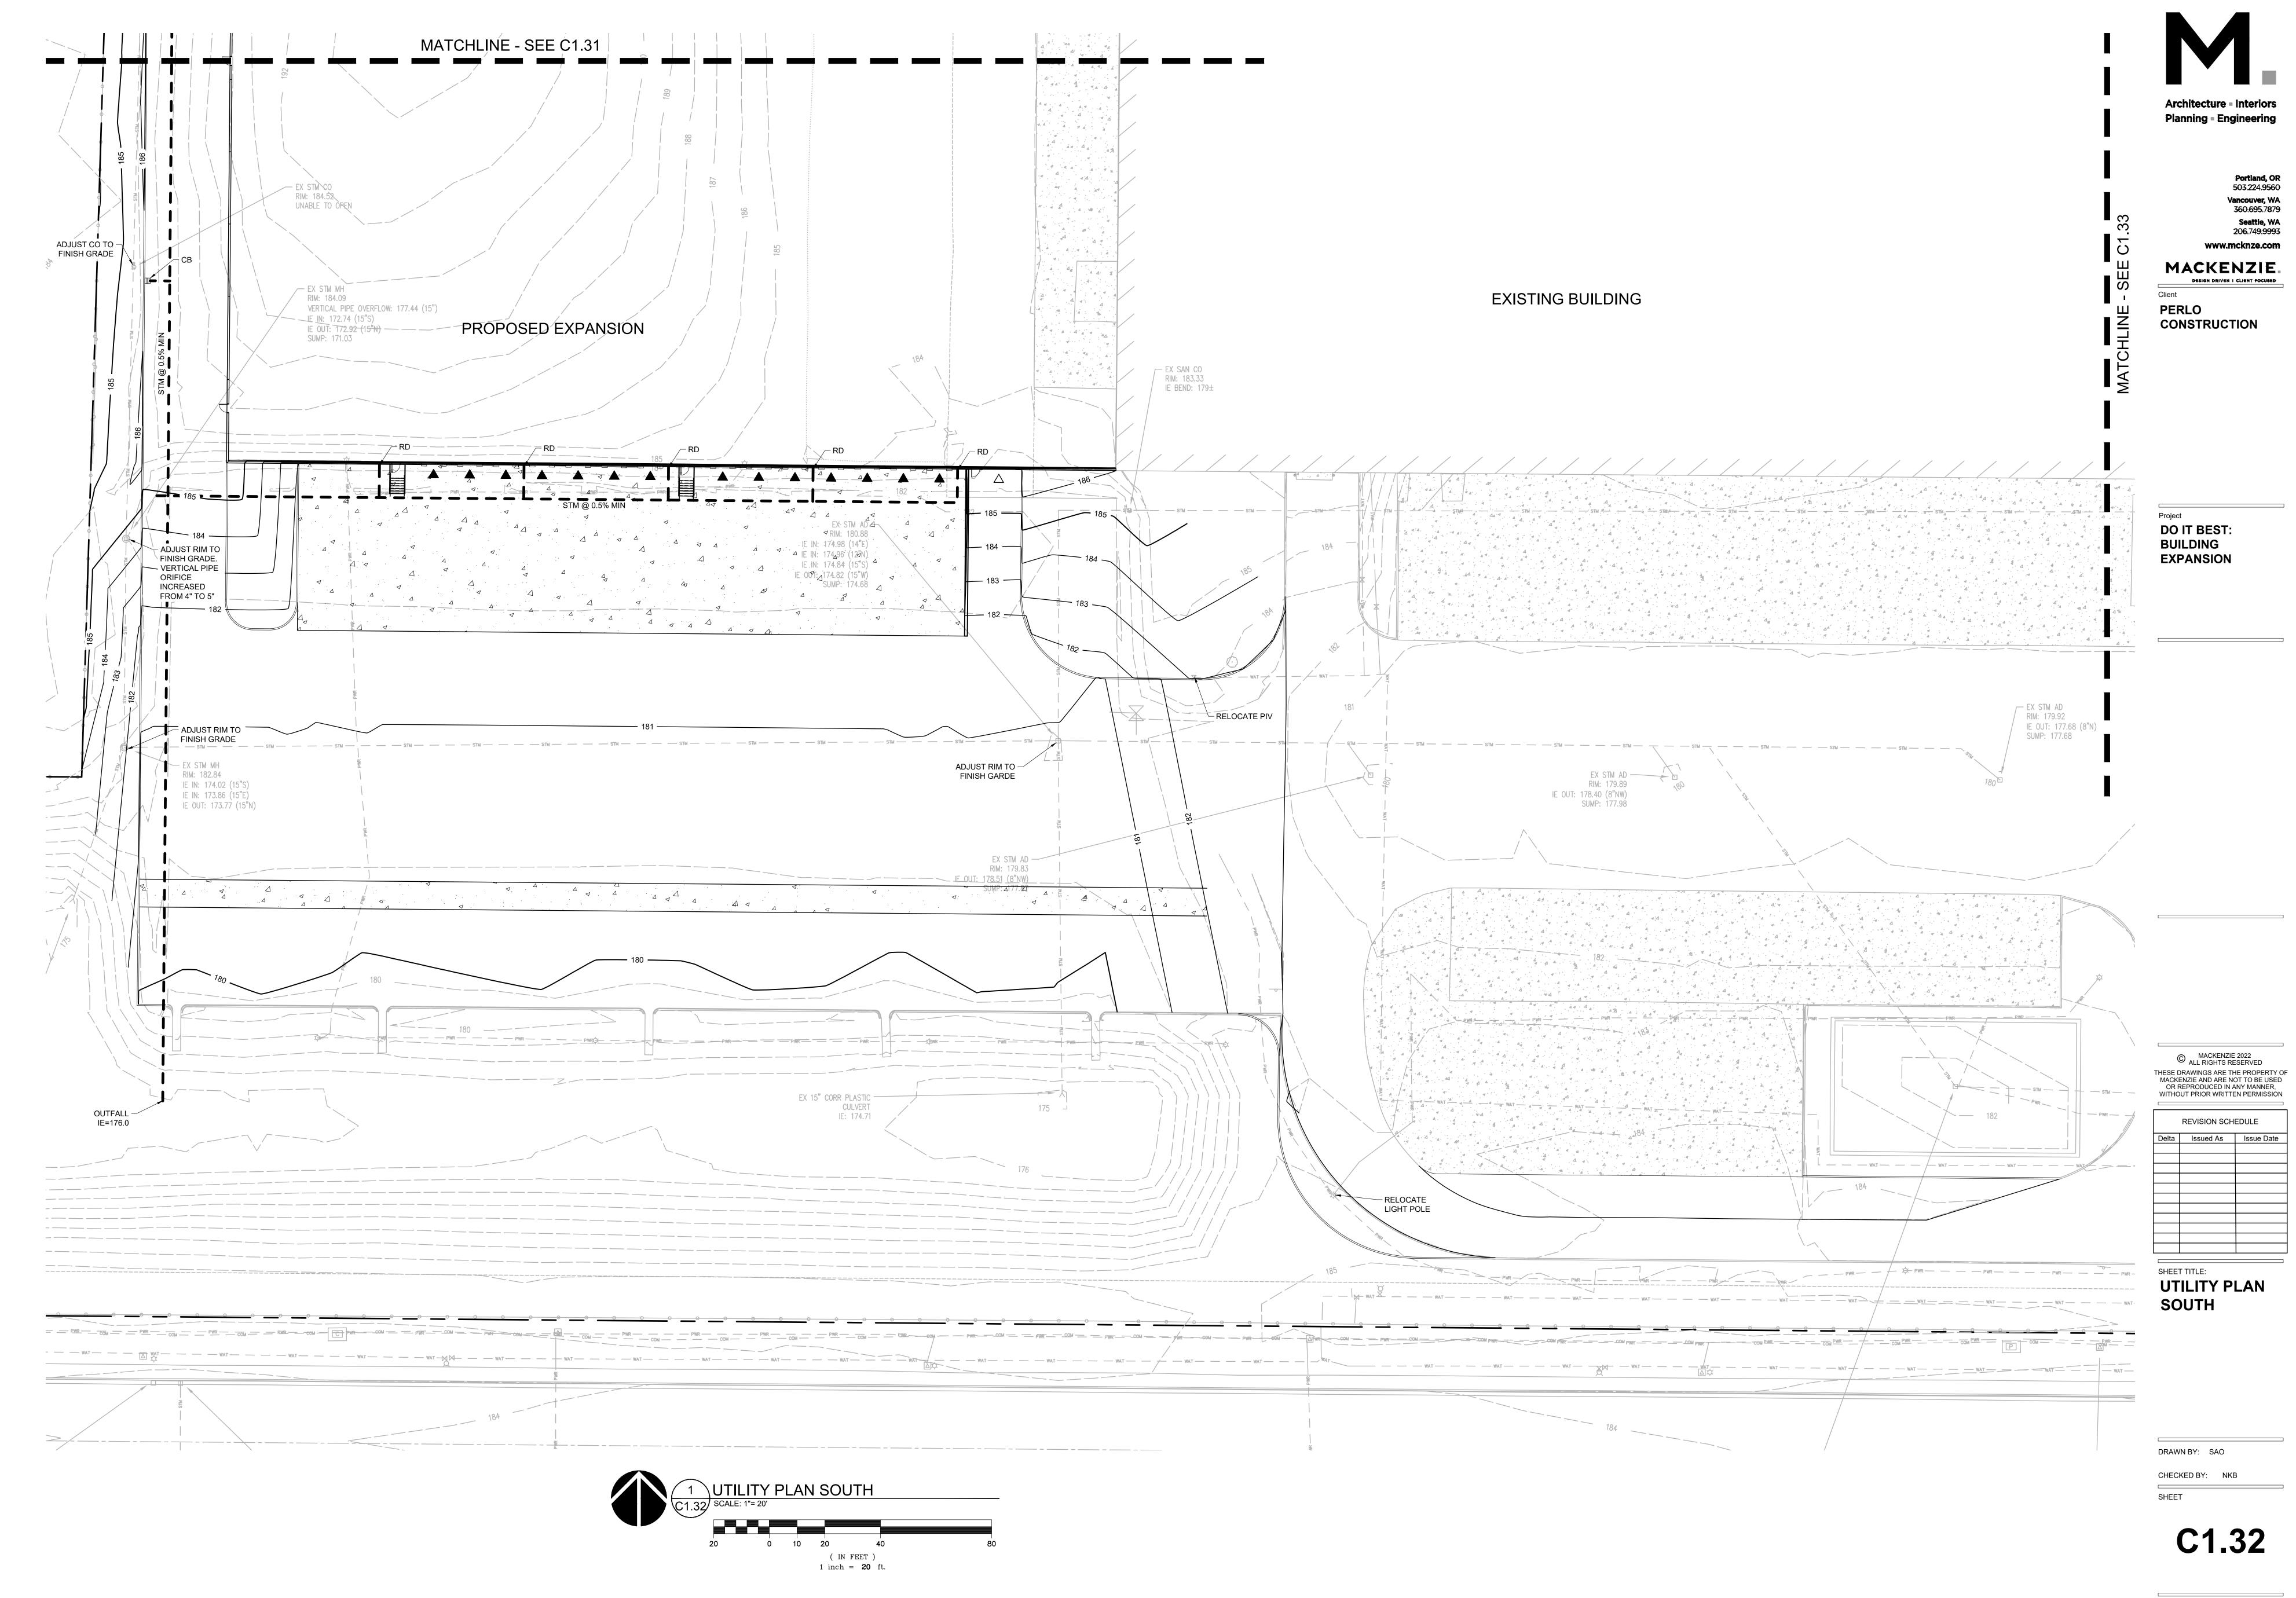
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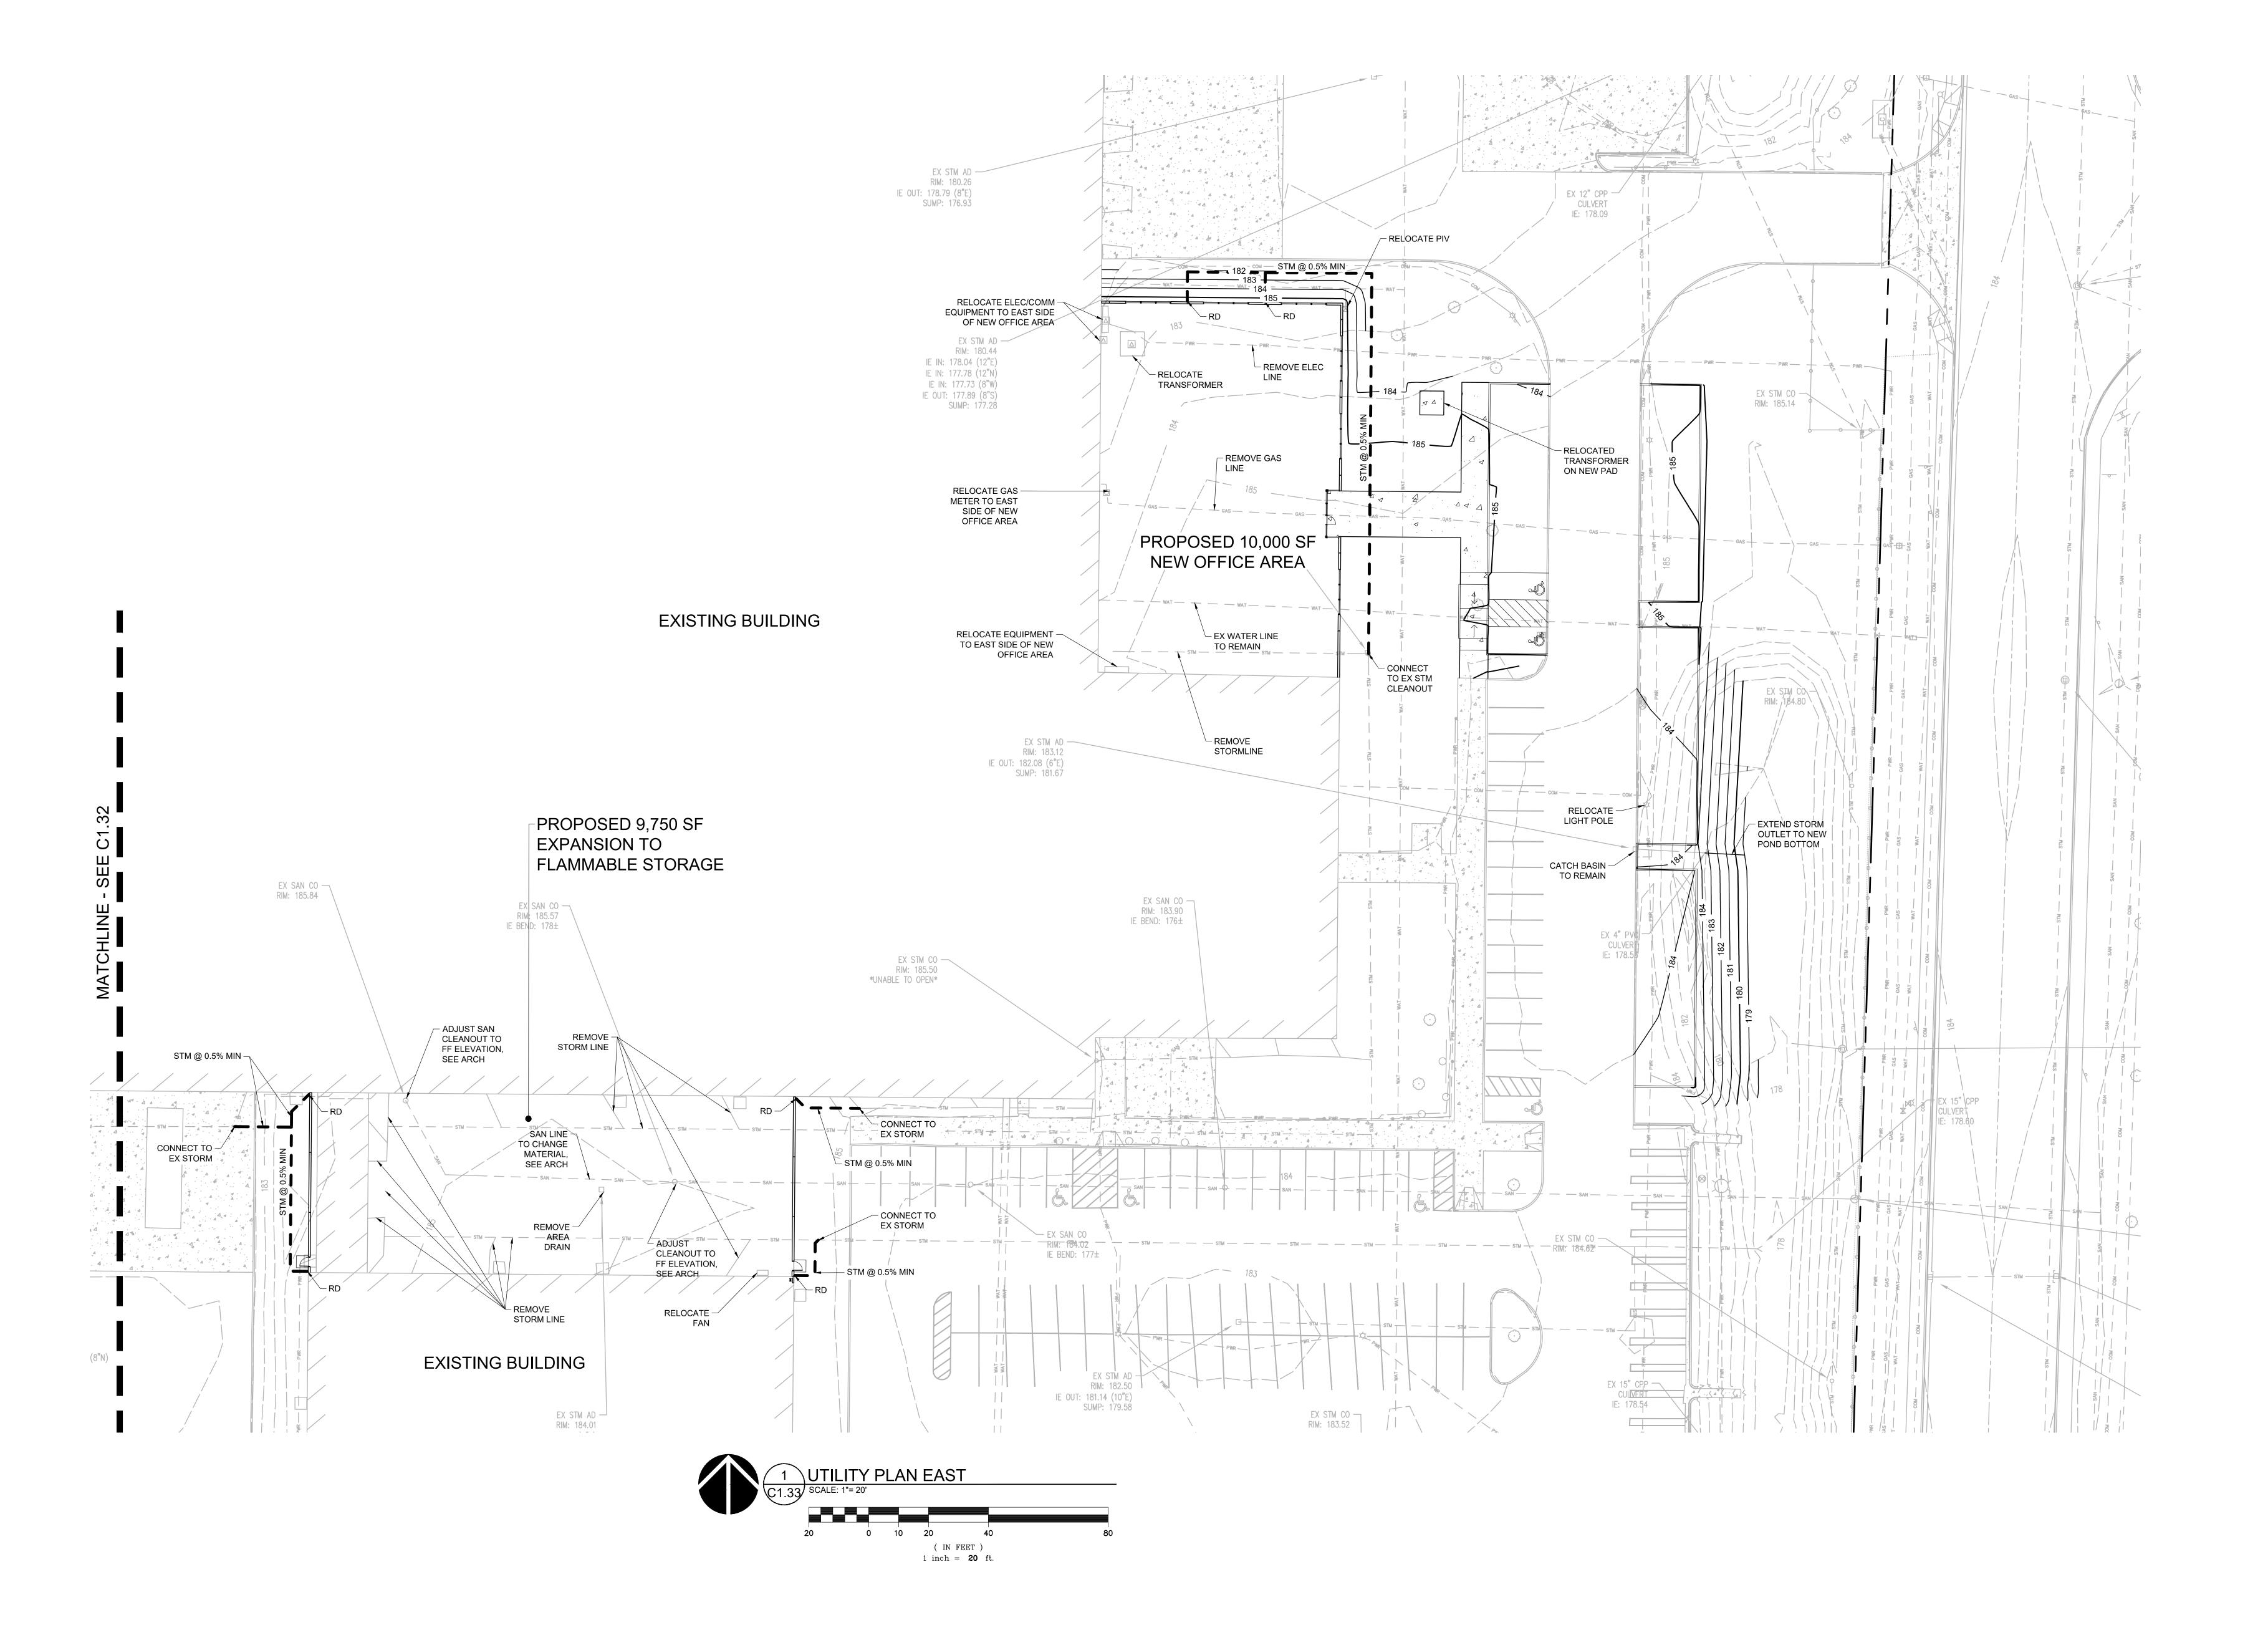
SHEET TITLE:
UTILITY PLAN
NORTH
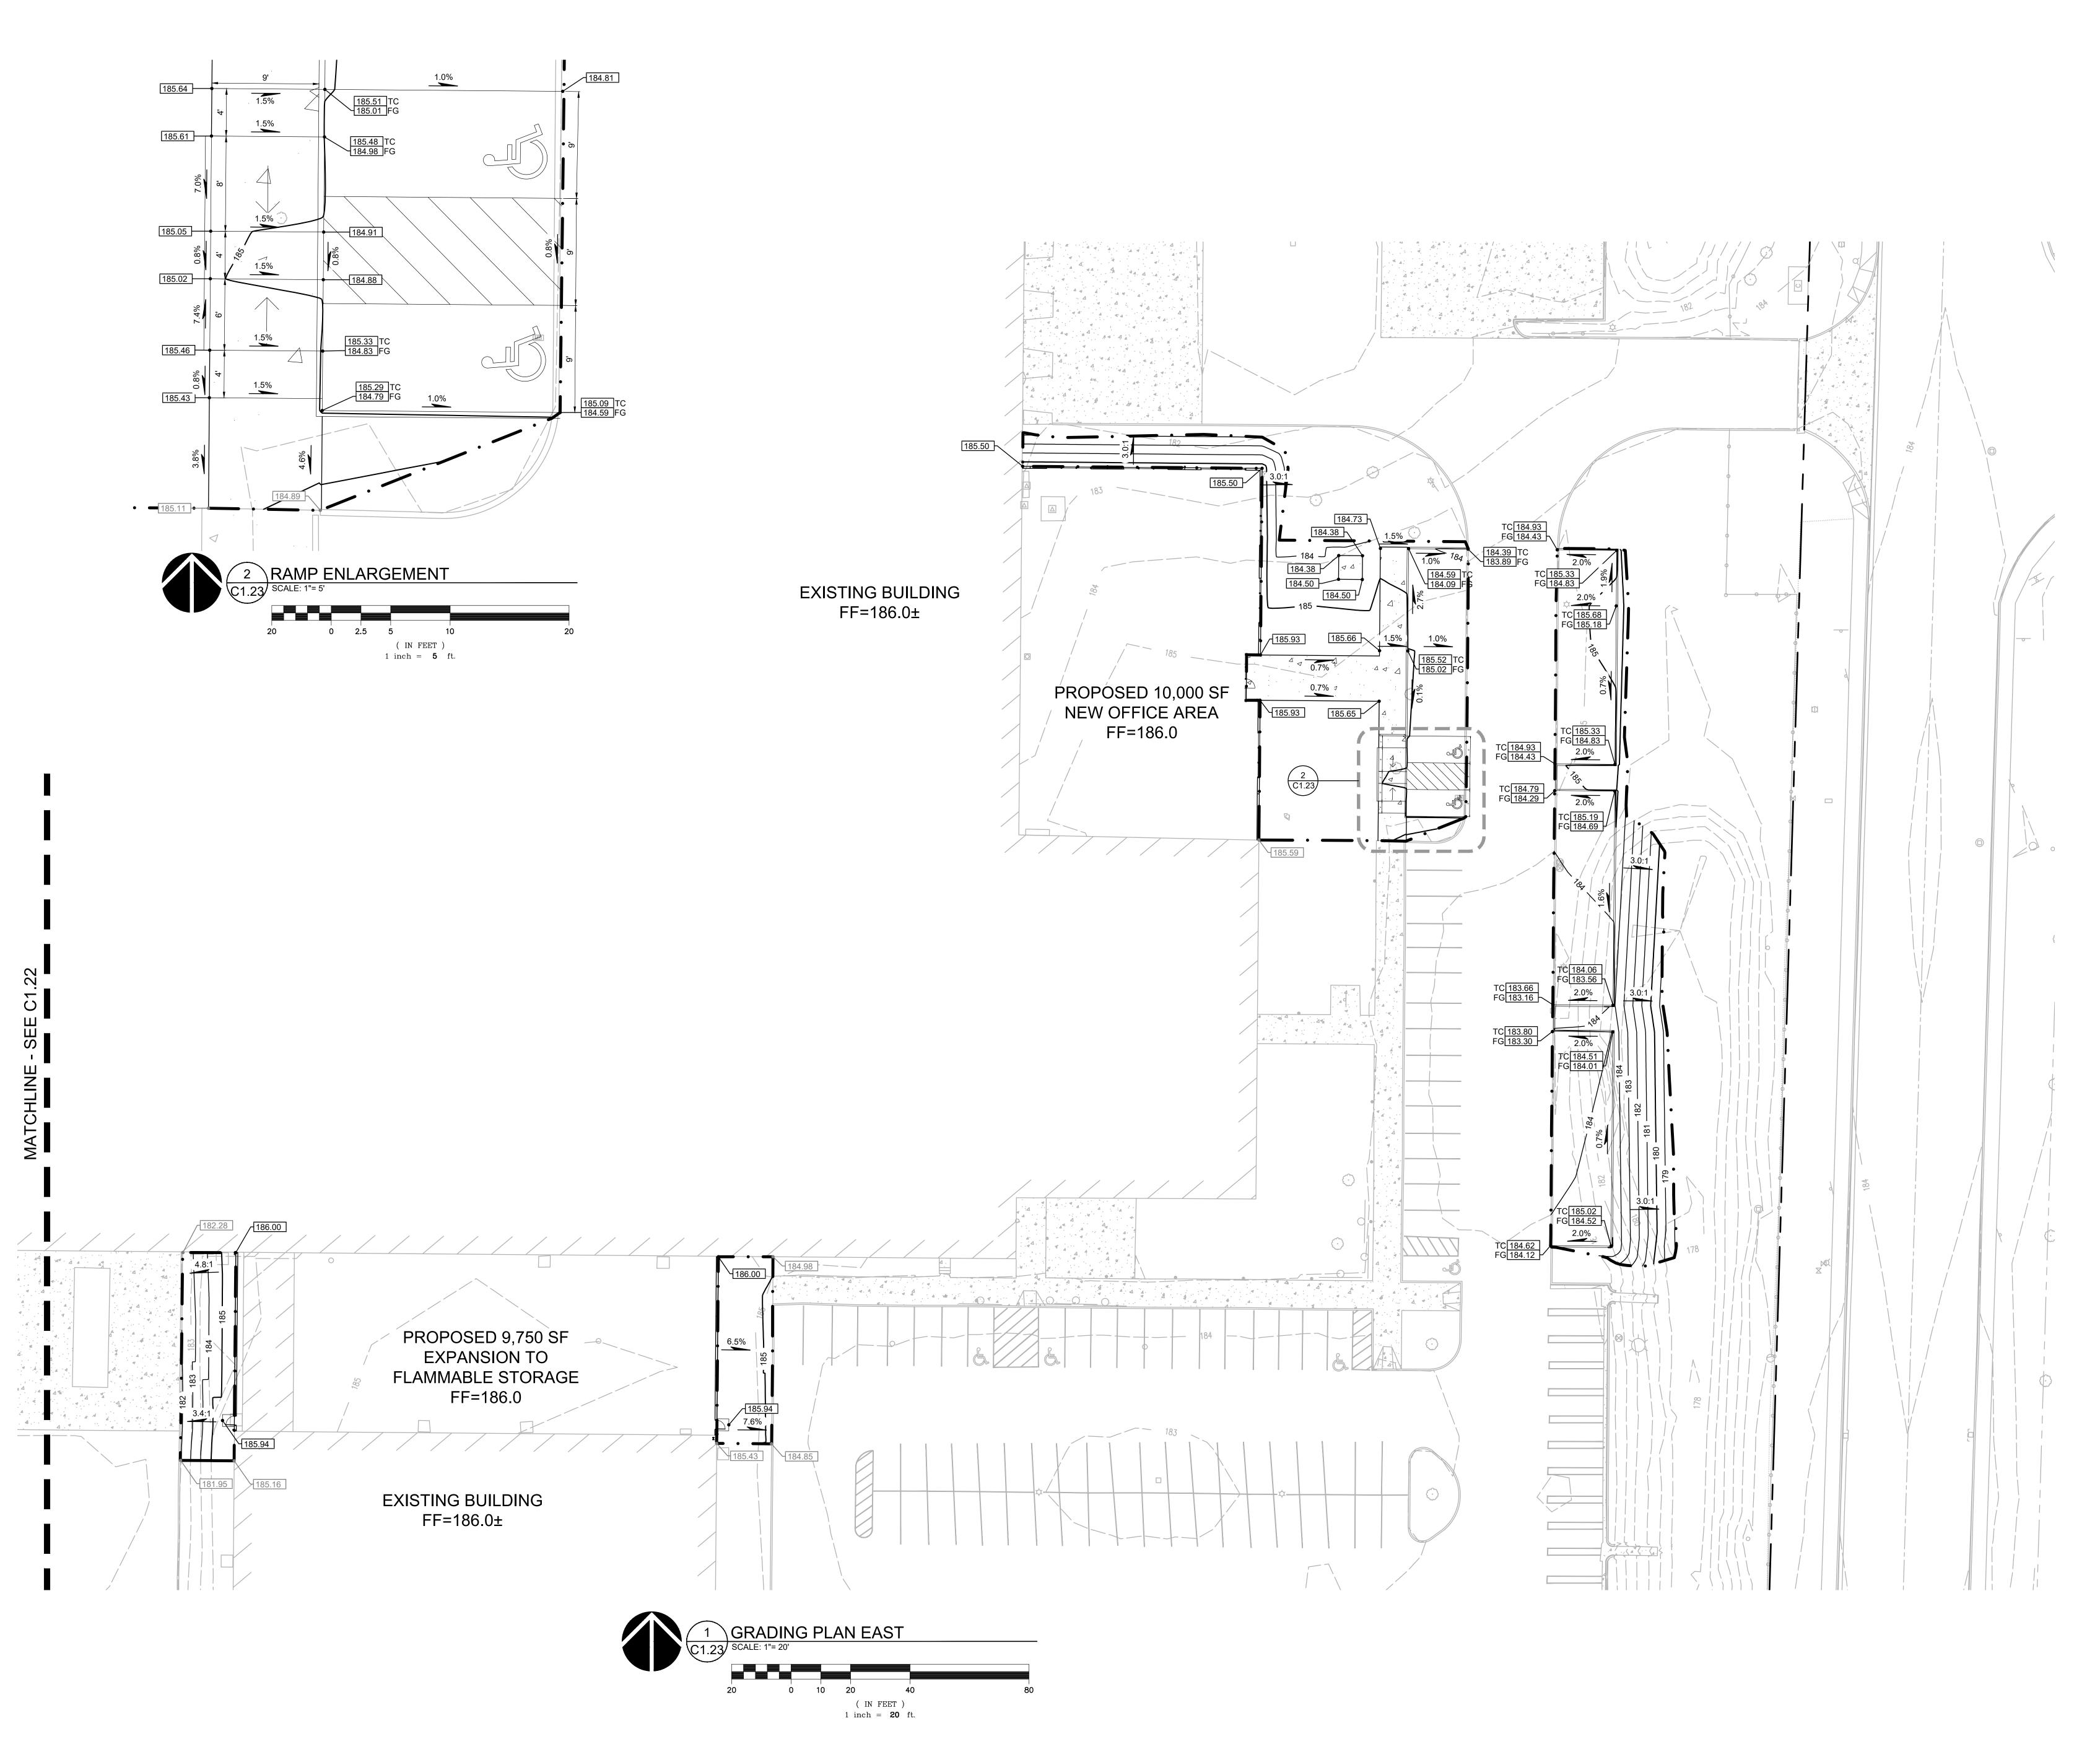
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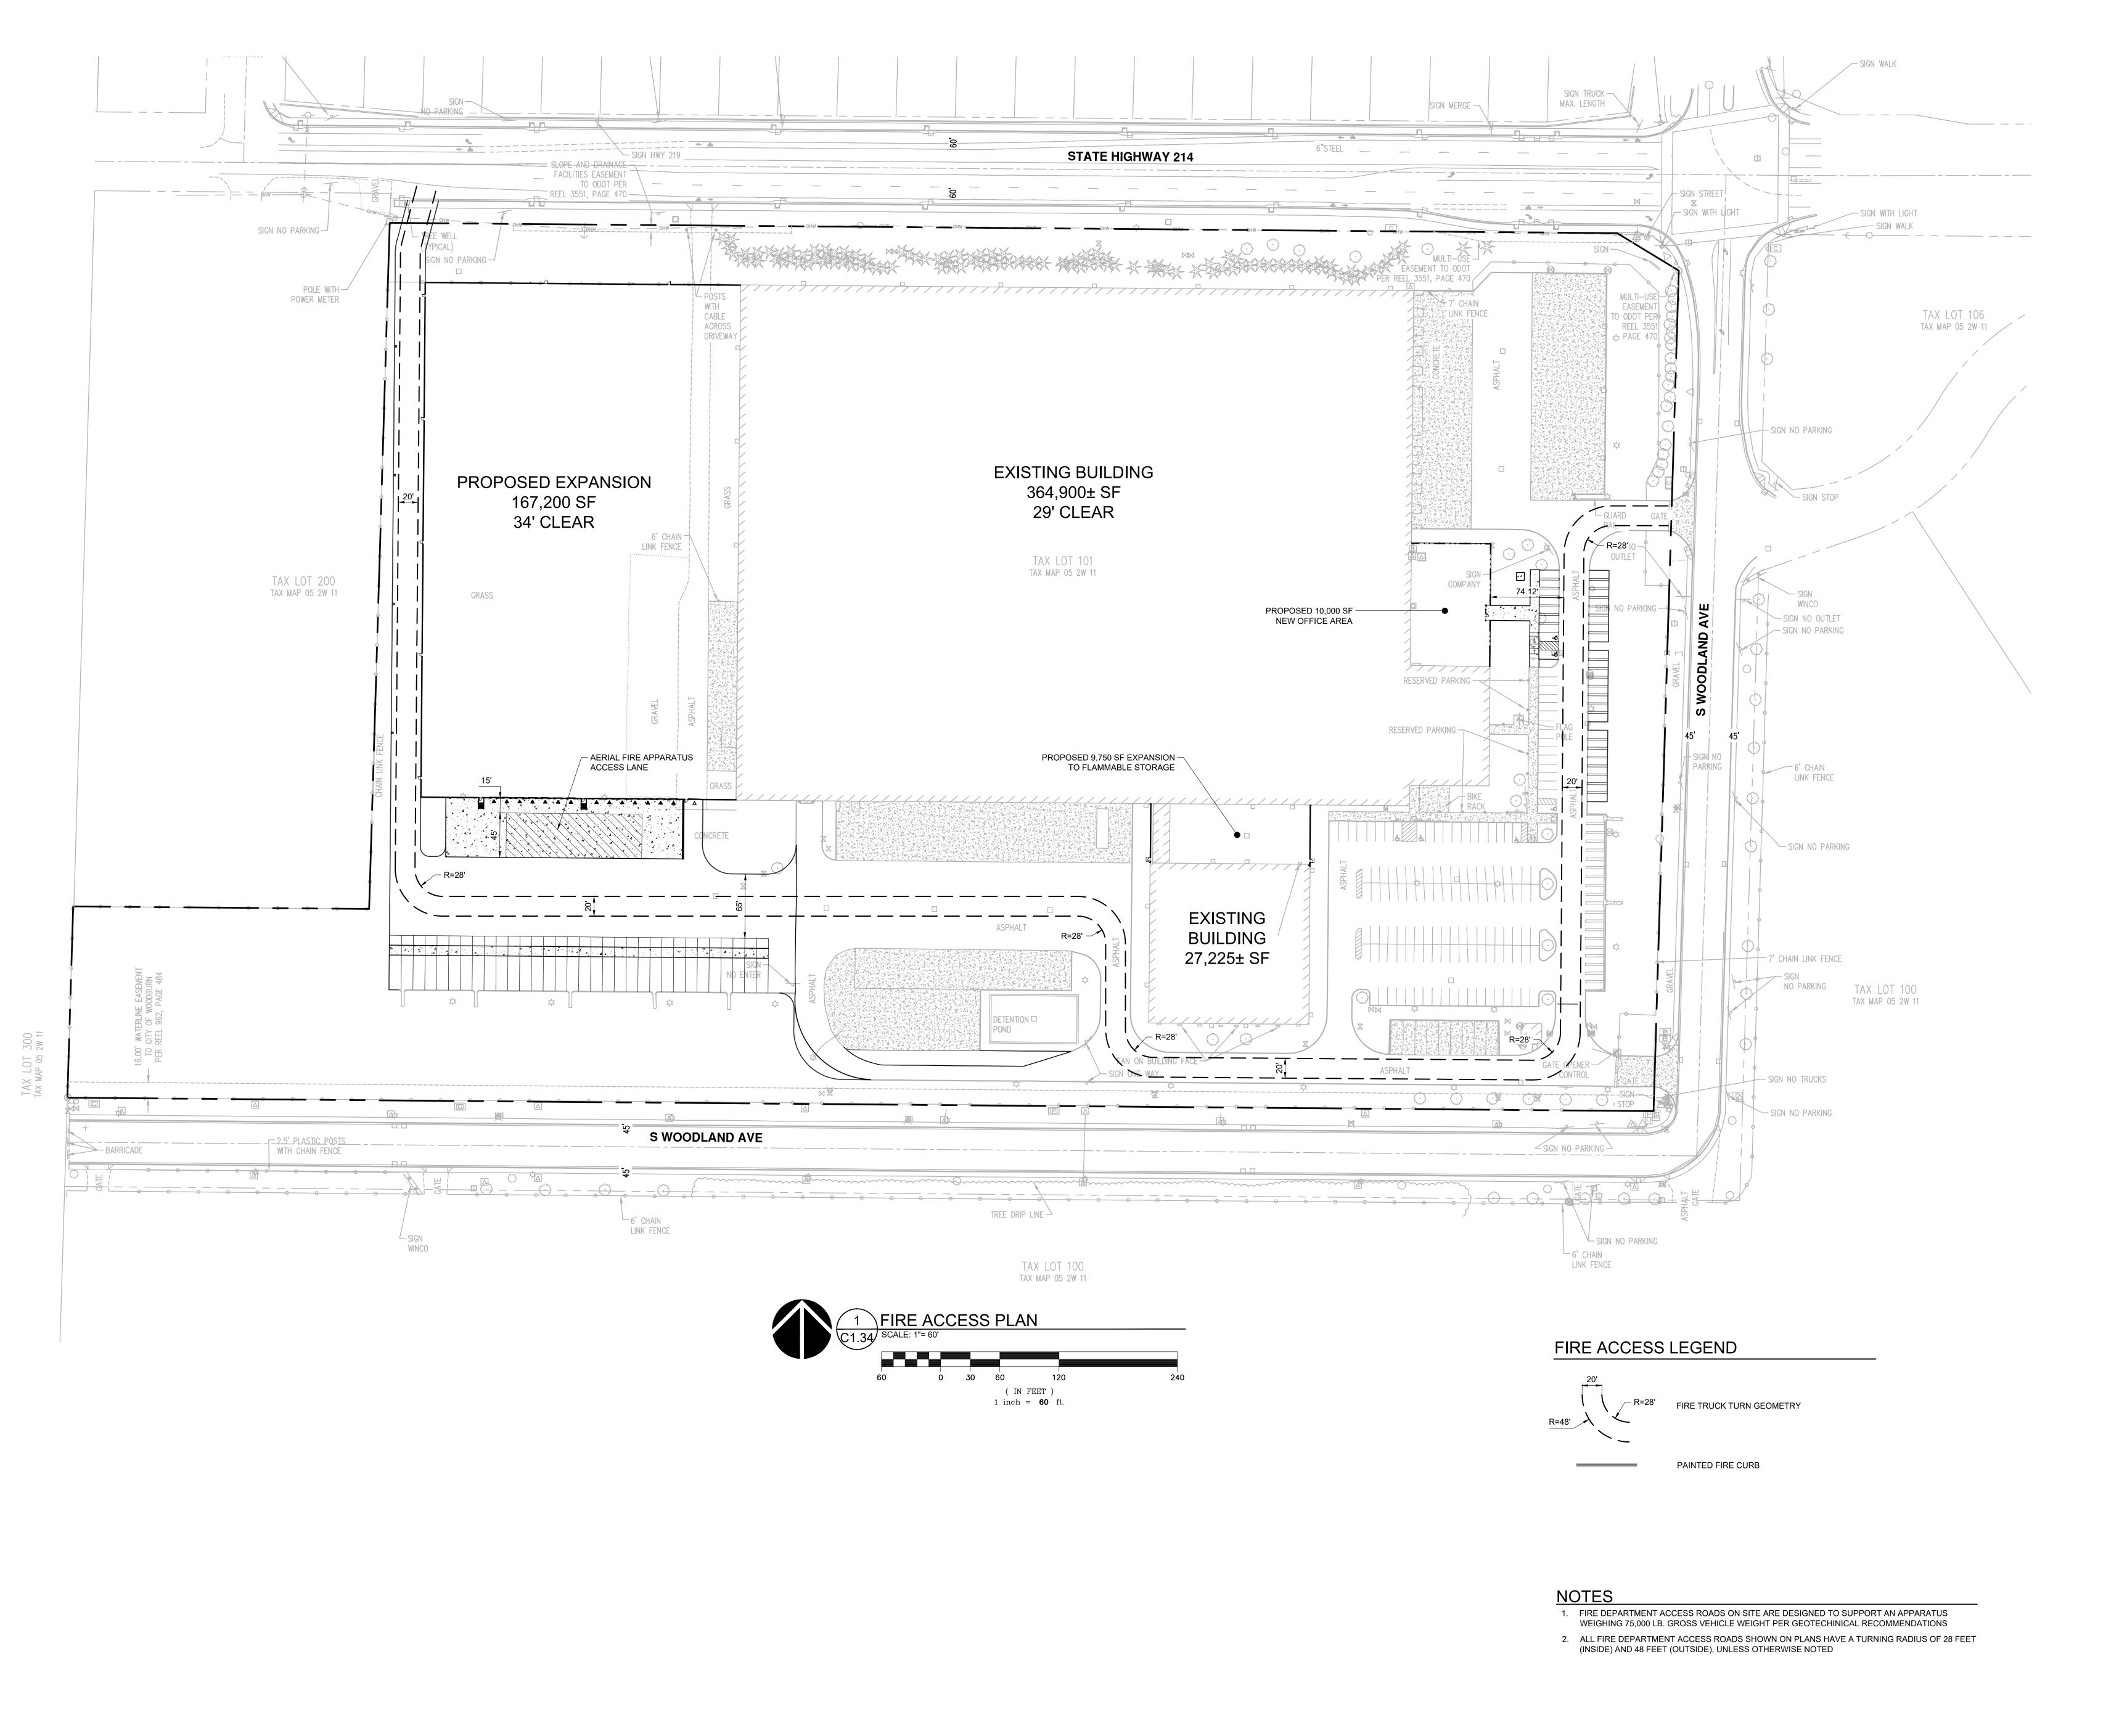
REVISION SCHEDULE

SHEET TITLE: **UTILITY PLAN EAST**

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SHEET

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FIRE ACCESS
PLAN

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C1.34

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L1.20 IRRIGATION PLAN (NOT INCLUDED) L5.10 PLANTING DETAILS (NOT INCLUDED) L5.11 IRRIGATION DETAILS (NOT INCLUDED)

TABLE OF ABBREVIATIONS

<u>I ABL</u>	E OF ABBKE
ANSI	AMERICAN NATIONAL
	STANDARDS INSTITUTE
3&B	BALL AND BURLAP
CAL	CALIPER
CONC	CONCRETE
DEG	DEGREE
DIA/Ø	DIAMETER
OWGS	DRAWING
ELL	ELBOW
EQ	EQUAL
-T	FEET/FOOT
GAL	GALLON
GALV	GALVANIZED
H/HT	HEIGHT
ИAX	MAXIMUM
ΛIN	MINIMUM
ΛIX	MIXTURE
NTS	NOT TO SCALE
OC	ON CENTER
POC	POINT OF CONNECTION
PVC	POLY VINYL CHLORIDE
SCH	SCHEDULE
SF	SQUARE FOOT
SPEC	SPECIFICATION

TYPICAL TIMES

SITE INFORMATION

JURISDICTION	WOODBURN, OR
STORMWATER	CITY OF WOODBURN
ZONING	IL - LIGHT INDUSTRIAL
SITE AREA	1,220,766 SF (28.0 AC)
LANDSCAPE AREA	308,849 SF
PARKING STALLS - NEW	33 STALLS
PARKING STALLS - EXISTING	155
DI ANT HAUT (DII) OA	LOUI ATIONS
PLANT UNIT (PU) CA	LCULATIONS

OFF-STREET PARKING AND LOADING	
NEW PAVED PARKING AREA	6183 SF
LANDSCAPE AREA (10% OF PAVED AREA)	618.3 SF (10%)
TREES	
LARGE (1 PER 25 STALLS)	0 TREES (0 STALLS)
MEDIUM (1 PER 15 STALLS)	4 TREES (60 STALLS)
SMALL (1 PER 10 STALLS)	0 TREES (0 STALLS)
SHRUBS (1 PU PER 20 SF)	618.3 SF (30.9 PU REQ)
LARGE (2 PU)	0 SHRUBS (0 PU)
SMALL (1 PU)	35 SHRUBS (35 PU)
GROUNDCOVER OR LAWN (1 PER 50 SF)	421 SF (8.4 PU)
STREET SETBACK (1 PU PER 15 SF)	3194 SF (212.9 PU REQ)

STREET SETBACK (1 PU PER 15 SF) TREES	3194 SF (212.9 PU REQ)
LARGE (10 PU)	12 TREES (120 PU)
MEDIUM (8 PÚ)	0 TREES (Ô PU)
SMALL (4 PU)	0 TREES (0 PU)
SHRUBS (1 PU PER 20 SF)	16 SHRUBS (32 PU)
LARGE (2 PU)	0 SHRUBS (0 PU)
SMALL (1 PU)	0 SHRUBS (0 PU
GROUNDCOVER OR LAWN (1 PER 50 SF)	3194 SF (63.9 PU)

OTHER YARDS (1 PU PER 50 SF) 26972.2 SF (539.4 PU REQ) TOTAL LANDSCAPE AREA 26972.2 SF 26972.2 SF (539.4 PU) GROUNDCOVER OR LAWN (1 PER 50 SF)

BUILDING

EXPANSION

PROVIDED PLANT UNIT QUANTITIES ARE ESTIMATED WITH A MARGIN OF ERROR OF APPROX. +/-10%. FINAL PLANT UNIT QUANTITIES ARE TO BE PROVIDED WITH FINAL PERMIT DRAWINGS.

LANDSCAPE NOTES

<u>GENERAL</u>

- COMMENCING WORK.
- 1. CONTRACTOR SHALL CONFIRM ALL EXISTING CONDITIONS PRIOR TO
- 2. CALL BEFORE YOU DIG. CONTRACTOR SHALL VERIFY INVERT ELEVATIONS OF ALL UNDERGROUND UTILITIES AND NOTIFY LANDSCAPE ARCHITECT IF THERE ARE ANY DISCREPANCIES WITH PLANTING ROOT ZONES. TO REQUEST LOCATES FOR PROPOSED EXCAVATION CALL 1-800-332-2344 (OR 811) IN OREGON.
- NOTIFY THE OWNER OR OWNER'S REPRESENTATIVE OF ANY DISCREPANCIES OR CONFLICTS WITH EXISTING CONDITIONS PRIOR TO COMMENCEMENT OF ANY
- CONTRACTOR PRIOR TO COMMENCEMENT OF WORK. DAMAGE TO EXISTING CONCRETE CURB, ASPHALT PAVING, OR OTHER STRUCTURE SHALL BE REPAIRED OR REPLACED TO PRE CONSTRUCTION
- CONDITIONS. 6. CONTRACTOR SHALL COORDINATE WITH THE OWNER ANY DISRUPTION TO VEHICULAR CIRCULATION PRIOR TO COMMENCEMENT OF ANY WORK.

4. LOCATION OF EXISTING TREES SHALL BE VERIFIED IN THE FIELD BY THE

<u>PLANTING</u>

- 1. ALL EXISTING TREES, PLANTS, AND ROOTS SHALL BE PROTECTED FROM DAMAGE FROM ANY CONSTRUCTION PREPARATION, REMOVAL OR
- INSTALLATION ACTIVITIES WITHIN AND ADJACENT TO PROJECT LIMITS. SHRUBS ADJACENT TO PARKING AREAS SHALL BE PLANTED 2 FT MINIMUM AWAY FROM THE BACK OF CURB. SHRUBS AND GROUNDCOVER ALONG OTHER PAVEMENT EDGES SHALL BE PLANTED A MINIMUM OF ONE HALF THEIR ON CENTER SPACING AWAY FROM PAVEMENT EDGE.
- ALL PLANT MATERIAL SHALL BE HEALTHY NURSERY STOCK, WELL BRANCHED AND ROOTED, FULL FOLIAGE, FREE FROM INSECTS, DISEASES, WEEDS, WEED ROT, INJURIES AND DEFECTS WITH NO LESS THAN MINIMUMS SPECIFIED IN
- AMERICAN STANDARDS FOR NURSERY STOCK, ANSI Z60.1-2004. TREES IN THE RIGHT OF WAY SHALL BE TALL ENOUGH TO BE LIMBED UP TO AT LEAST 8 FT ABOVE DRIVE SURFACE GRADE WHILE MAINTAINING ENOUGH
- BRANCHES TO SUPPORT HEALTHY GROWTH. 5. DO NOT PLANT TREES ABOVE WATERLINES, UTILITIES, OR OTHER UNDERGROUND PIPING.
- 6. IF DISTURBANCE IS NECESSARY AROUND EXISTING TREES, CONTRACTOR SHALL PROTECT THE CROWN AND ALL WORK WITHIN THE TREE DRIPZONE
- SHALL BE LIMITED TO THE USE OF HAND TOOLS AND MANUAL EQUIPMENT ONLY. 7. REPLACE, REPAIR AND RESTORE DISTURBED LANDSCAPE AREAS DUE TO GRADING, TRENCHING OR OTHER REASONS TO PRE-CONSTRUCTION CONDITION AND PROVIDE MATERIAL APPROVED BY THE OWNER AND OWNER'S REPRESENTATIVE.
- 8. EXISTING AREAS PROPOSED FOR NEW PLANT MATERIAL SHALL BE CLEARED AND LEGALLY DISPOSED UNLESS SO NOTED.
- 9. A SOILS ANALYSIS, BY AN INDEPENDENT SOILS TESTING LABORATORY RECOGNIZED BY THE STATE DEPARTMENT OF AGRICULTURE, SHALL BE USED TO RECOMMEND AN APPROPRIATE PLANTING SOIL AND/OR SPECIFIED SOIL AMENDMENTS.
- 10. TOPSOIL SHALL BE AMENDED AS RECOMMENDED BY AN INDEPENDENT SOILS TESTING LABORATORY AND AS OUTLINED IN THE SPECIFICATION.

BUILDING

EXISTING

WOODLAND AVE

SAN S SAN S

EXPANSION

11. ALL LANDSCAPED AREAS SHALL BE COVERED BY A LAYER OF ORGANIC MULCH TO A MINIMUM DEPTH OF 2-INCHES.

- 1. ALL NEW LANDSCAPE AREAS TO BE IRRIGATED WITH A FULLY AUTOMATIC UNDERGROUND IRRIGATION SYSTEM.
- 2. ASSESS EXISTING IRRIGATION SYSTEM FOR CAPACITY TO ACCOMMODATE PROPOSED LANDSCAPE AREAS.
- CONTRACTOR TO DETERMINE STATIC WATER PRESSURE AT THE P.O.C. PRIOR TO PREPARING SHOP DRAWINGS.
- CONTRACTOR SHALL ESTABLISH MINIMUM PRESSURE AND MAXIMUM DEMAND REQUIREMENTS FOR IRRIGATION SYSTEM DESIGN, AND PROVIDE INFORMATION
- IN AN IRRIGATION SCHEDULE.
- IRRIGATION SYSTEM AS DESIGNED AND INSTALLED SHALL PERFORM WITHIN THE TOLERANCES AND SPECIFICATIONS OF THE SPECIFIED MANUFACTURERS.
- SYSTEM SHALL BE DESIGNED TO SUPPLY MANUFACTURER'S SPECIFIED
- MINIMUM OPERATING PRESSURE TO FARTHEST EMITTER FROM WATER METER. 7. SYSTEM SHALL PROVIDE HEAD TO HEAD COVERAGE WITHOUT OVERSPRAY
- ONTO BUILDING, FENCES, SIDEWALKS, PARKING AREAS, OR OTHER NON-VEGETATED SURFACES. 8. STOCKPILE ANY IRRIGATION COMPONENTS IN GOOD CONDITION THAT COULD
- BE REUSED, EITHER IN THE NEW LANDSCAPE AREAS OR ELSEWHERE ON SITE CLEAN COMPONENTS AND PROVIDE TO OWNER'S MAINTENANCE REPRESENTATIVE.
- 9. ALL IRRIGATION PIPE MATERIAL AND INSTALLATION SHALL CONFORM TO APPLICABLE CODE FOR PIPING AND COMPONENT REQUIREMENTS.
- 10. PROVIDE SLEEVING AT ALL AREAS WHERE PIPE TRAVELS UNDER CONCRETE OR HARD SURFACING.
- VALVES SHALL BE WIRED AND INSTALLED PER MANUFACTURER'S RECOMMENDED INSTALLATION PROCEDURES AND CONNECTED TO THE IRRIGATION CONTROLLER.
- 12. QUICK COUPLER TO BE PLACED IN A DISCRETE AND ACCESSIBLE LOCATION.
- IRRIGATION SHALL BE WINTERIZED THROUGH LOW PRESSURE, HIGH VOLUME AIR BLOWOUT CONNECTION THROUGH QUICK COUPLER. CONTRACTOR TO VERIFY LOCATION AND FUNCTIONALITY OF QUICK COUPLERS.
- 14. THE SYSTEM SHALL BE GRAVITY DRAINED. THE CONTRACTOR SHALL VERIFY PRESENCE OF APPROPRIATE MANUAL DRAINS AT LOW POINTS.
- 15. REVIEW OPERATION OF IRRIGATION SYSTEM WITH OWNER'S REPRESENTATIVE. PROVIDE AS BUILT PLAN SHOWING THE MODIFICATIONS AND HOW THEY CONNECT TO THE EXISTING SYSTEM. PLAN TO BE LAMINATED AND STORED IN THE CONTROLLER HOUSING WITH INSTRUCTIONS FOR SEASONAL MAINTENANCE, INCLUDING WINTERIZATION AND SPRING START UP.

WOODLAND

PLANT SCHEDULE

TREES	BOTANICAL / COMMON NAME	SIZE	
80000000000000000000000000000000000000	ABIES GRANDIS GRAND FIR MATURE (150' H X 40' W) MEDIUM TREE	10° HT. MIN. B&B	
Se o Se out of the second of t	THUJA PLICATA WESTERN RED CEDAR MATURE (100' H X 30' W) LARGE TREE	10° HT. MIN. B&B	
	ZELKOVA SERRATA 'GREEN VASE' SAWLEAF ZELKOVA MATURE (85' H X 75' W) LARGE TREE	2" CAL., B&B	
SHRUBS	BOTANICAL / COMMON NAME	SIZE	SPACING
0	BERBERIS THUNBERGII 'ATROPURPUREA NANA' DWARF RED LEAF JAPANESE BARBERRY (3' H X 3' W) SMALL SHRUB	3 GAL.	30" o.c.
(SPIRAEA BETULIFOLIA BIRCH LEAF SPIREA (3' H X 3' W) SMALL SHRUB	3 GAL.	30" o.c.
\bigcirc	VIBURNUM TINUS LAURUSTINUS VIBURNUM (6-7' H X 5' W) LARGE SHRUB	3 GAL.	48" o.c.
GROUND COVERS	BOTANICAL / COMMON NAME	SIZE	SPACING
	EUONYMUS FORTUNEI 'COLORATUS' COLORATUS PURPLE WINTERCREEPER 24" HEIGHT	1 GAL.	24" o.c.
	MAHONIA REPENS CREEPING MAHONIA 18" HEIGHT, NATIVE NW	1 GAL.	16" o.c.
· · · · ·	SEED MIX TYPE A		
	SEED MIX TYPE B		

LEGEND - LANDSCAPE USE AREAS

PARKING LANDSCAPE

STREET SETBACK

NEW PARKING AREA

OTHER YARDS

REQUIRED PU

1 PU/50 SF

PER WOODBURN DEVELOPMENT ORDINACE TABLE 3.06A

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Delta	Issued As	Issue Dat
	Delta	

SHEET TITLE: LANDSCAPE **GENERAL INFORMATION**

L0.01

STATE HIGHWAY 214 w— — — oнw— -SEED TO LIMITS OF DISTURBANCE -**MATCHLINE - SEE L1.11**

(IN FEET) 1 inch = 20 ft.

PLANT KEY LEGEND


<u>TREES</u> <u>BOTANICAL / COMMON NAME</u>



ABIES GRANDIS



GRAND FIR MATURE (150° H X 40° W) MEDIUM TREE THUJA PLICATA

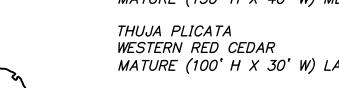

MATURE (100° H X 30° W) LARGE TREE ZELKOVA SERRATA 'GREEN VASE'

SAWLEAF ZELKOVA MATURE (85' H X 75' W) LARGE TREE

> <u>BOTANICAL / COMMON NAME</u> BERBERIS THUNBERGII 'ATROPURPUREA NANA' DWARF RED LEAF JAPANESE BARBERRY

(3' H X 3' W) SMALL SHRUB SPIRAEA BETULIFOLIA BIRCH LEAF SPIREA (3' H X 3' W) SMALL SHRUB

> **VIBURNUM TINUS** LAURUSTINUS VIBURNUM (6-7' H X 5' W) LARGE SHRUB

GROUND COVERS BOTANICAL / COMMON NAME



EUONYMUS FORTUNEI 'COLORATUS' COLORATUS PURPLE WINTERCREEPER 24" HEIGHT



MAHONIA REPENS CREEPING MAHONIA 18" HEIGHT, NATIVE NW



SEED MIX TYPE A



SEED MIX TYPE B

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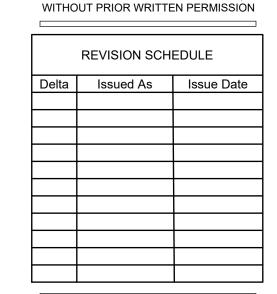
REFERENCE NOTES

KEY MAP


SCALE: NTS

- 1. PLANT SIZE, SPACING, AND QUANTITY, SEE PLANT SCHEDULE L0.01. 2. EXISTING TREE TO REMAIN. DO NOT DISTURB. PROTECT IN PLACE. 3. CAREFULLY EXCAVATE SHRUB PITS IN VICINITY OF EXISTING TREES, WITHOUT DISTURBING TREE ROOTS.
- 4. COORDINATE SHRUB LAYOUT WITH EXISTING UTILITIES, REPORT CONFLICTS TO LANDSCAPE ARCHITECT.
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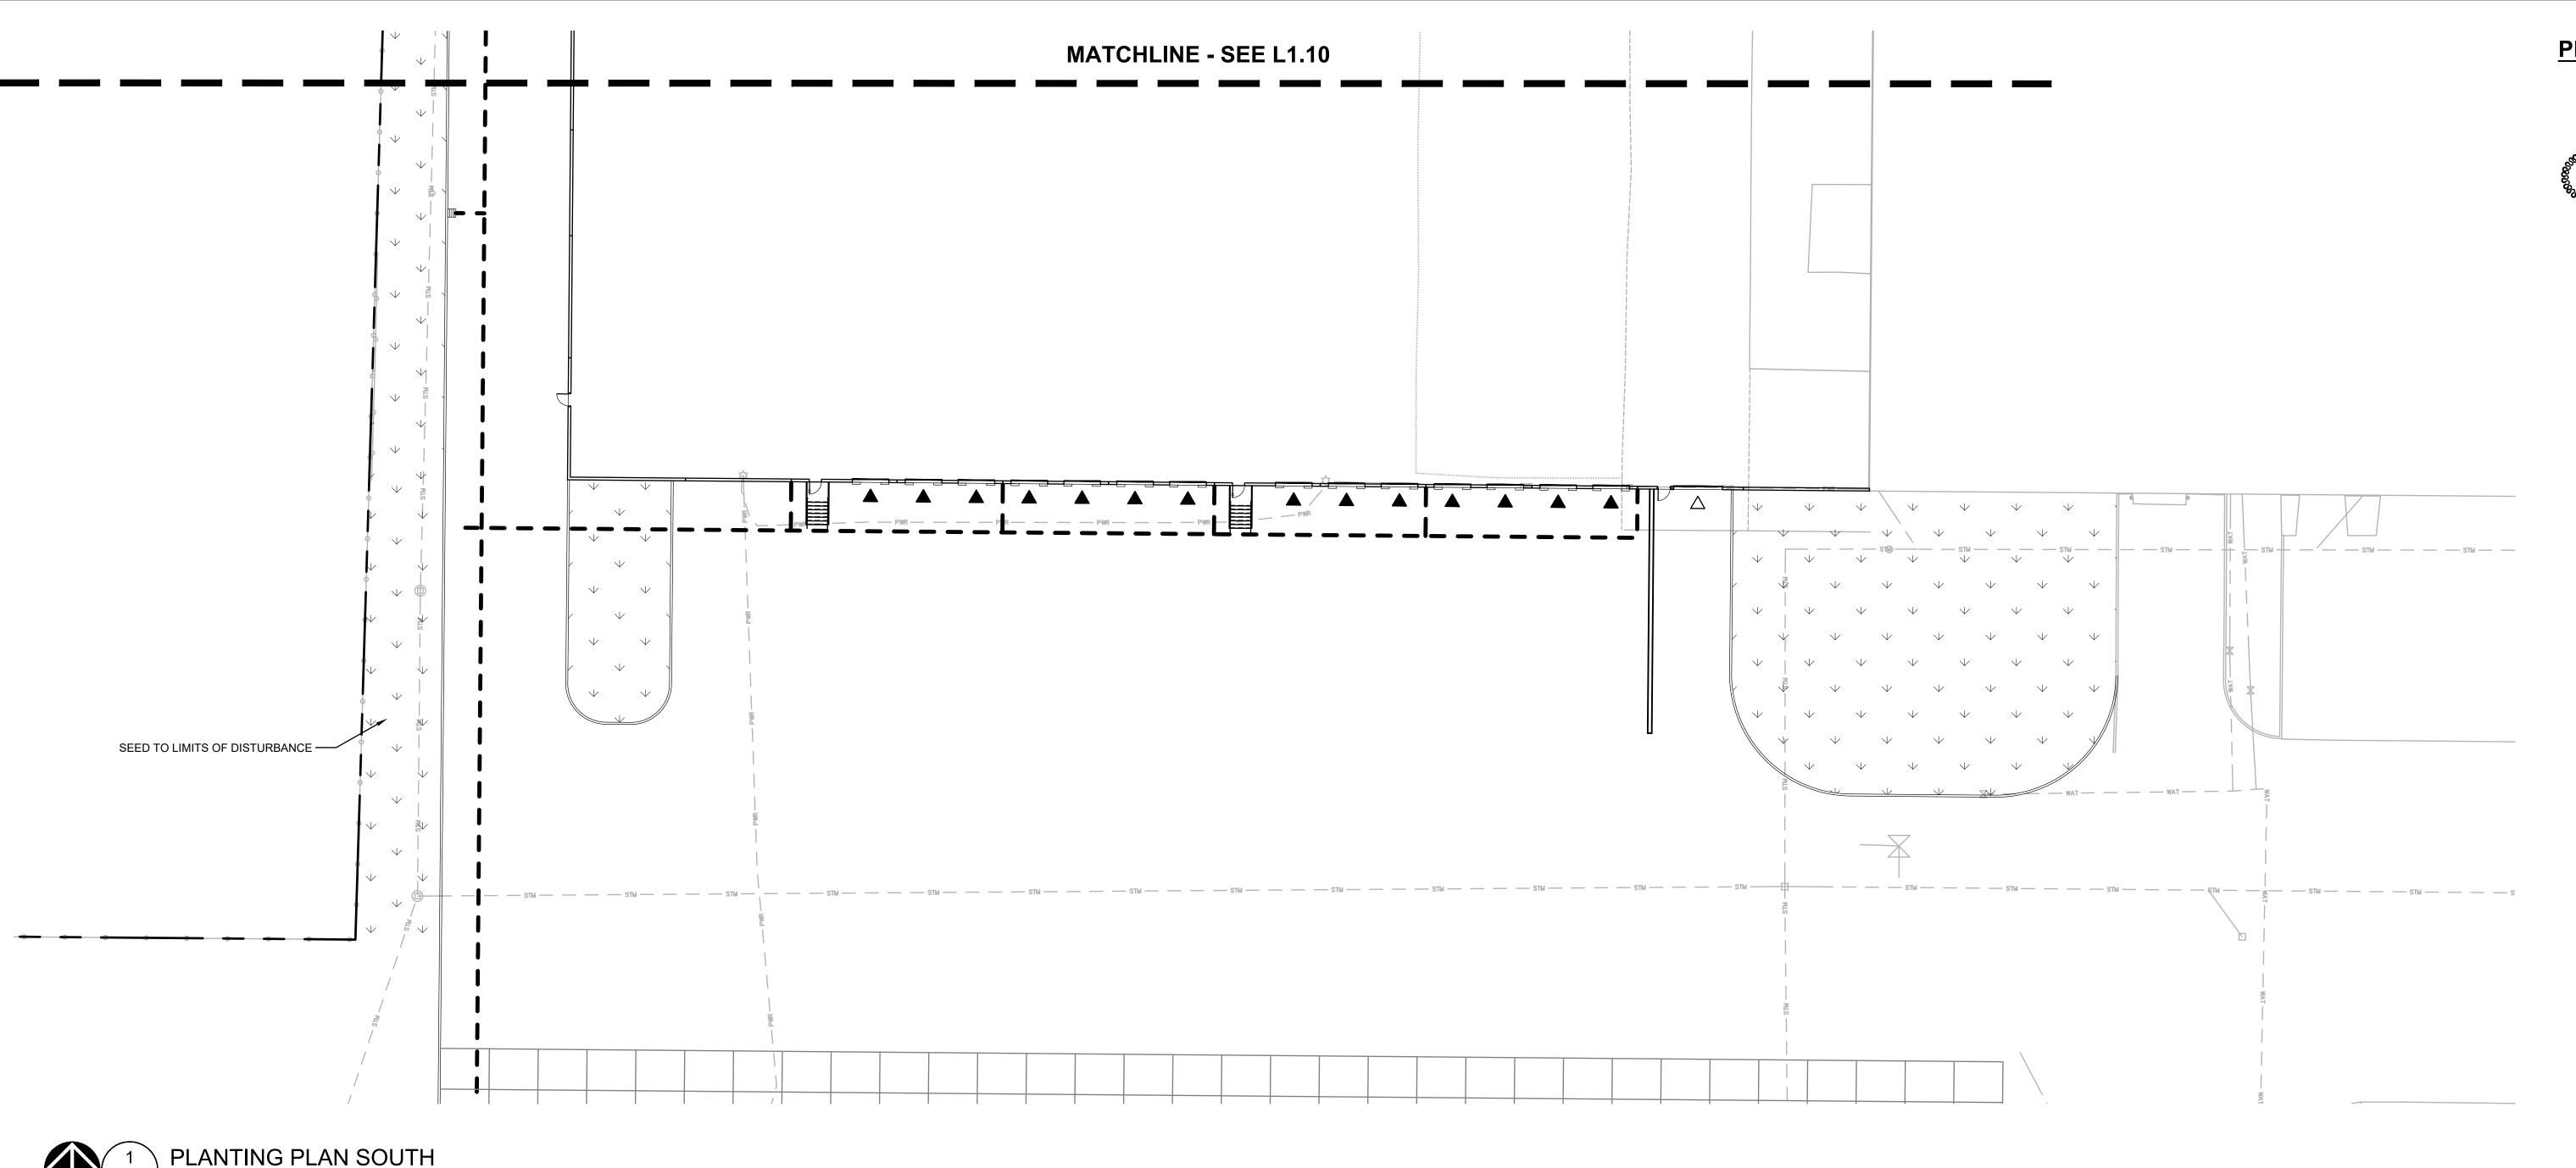


PLANTING PLAN NORTH



DRAWN BY: AB

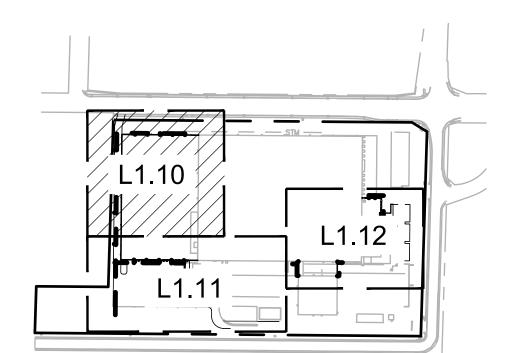L1.10



SEED TO LIMITS OF DISTURBANCE

PLANT KEY LEGEND

<u>BOTANICAL / COMMON NAME</u> ABIES GRANDIS

GRAND FIR

MATURE (150' H X 40' W) MEDIUM TREE THUJA PLICATA

WESTERN RED CEDAR MATURE (100' H X 30' W) LARGE TREE ZELKOVA SERRATA 'GREEN VASE'

SAWLEAF ZELKOVA

MATURE (85' H X 75' W) LARGE TREE <u>SHRUBS</u> BOTANICAL / COMMON NAME

BERBERIS THUNBERGII 'ATROPURPUREA NANA' DWARF RED LEAF JAPANESE BARBERRY (3' H X 3' W) SMALL SHRUB

> SPIRAEA BETULIFOLIA BIRCH LEAF SPIREA (3' H X 3' W) SMALL SHRUB

> > *VIBURNUM TINUS* LAURUSTINUS VIBURNUM (6-7' H X 5' W) LARGE SHRUB

GROUND COVERS BOTANICAL / COMMON NAME

EUONYMUS FORTUNEI 'COLORATUS'

COLORATUS PURPLE WINTERCREEPER 24" HEIGHT

18" HEIGHT, NATIVE NW SEED MIX TYPE A

MAHONIA REPENS CREEPING MAHONIA



SEED MIX TYPE B

Project DO IT BEST: **BUILDING EXPANSION**

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Seattle, WA

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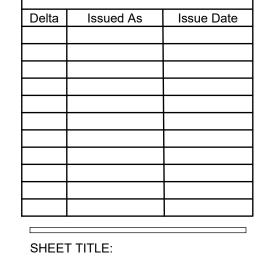
DESIGN DRIVEN I CLIENT FOCUSED

REFERENCE NOTES


- 1. PLANT SIZE, SPACING, AND QUANTITY, SEE PLANT SCHEDULE L0.01. 2. EXISTING TREE TO REMAIN. DO NOT DISTURB. PROTECT IN PLACE. 3. CAREFULLY EXCAVATE SHRUB PITS IN VICINITY OF EXISTING TREES, WITHOUT DISTURBING TREE ROOTS.
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PLANTING PLAN SOUTH




JOB NO. **2210471.00**

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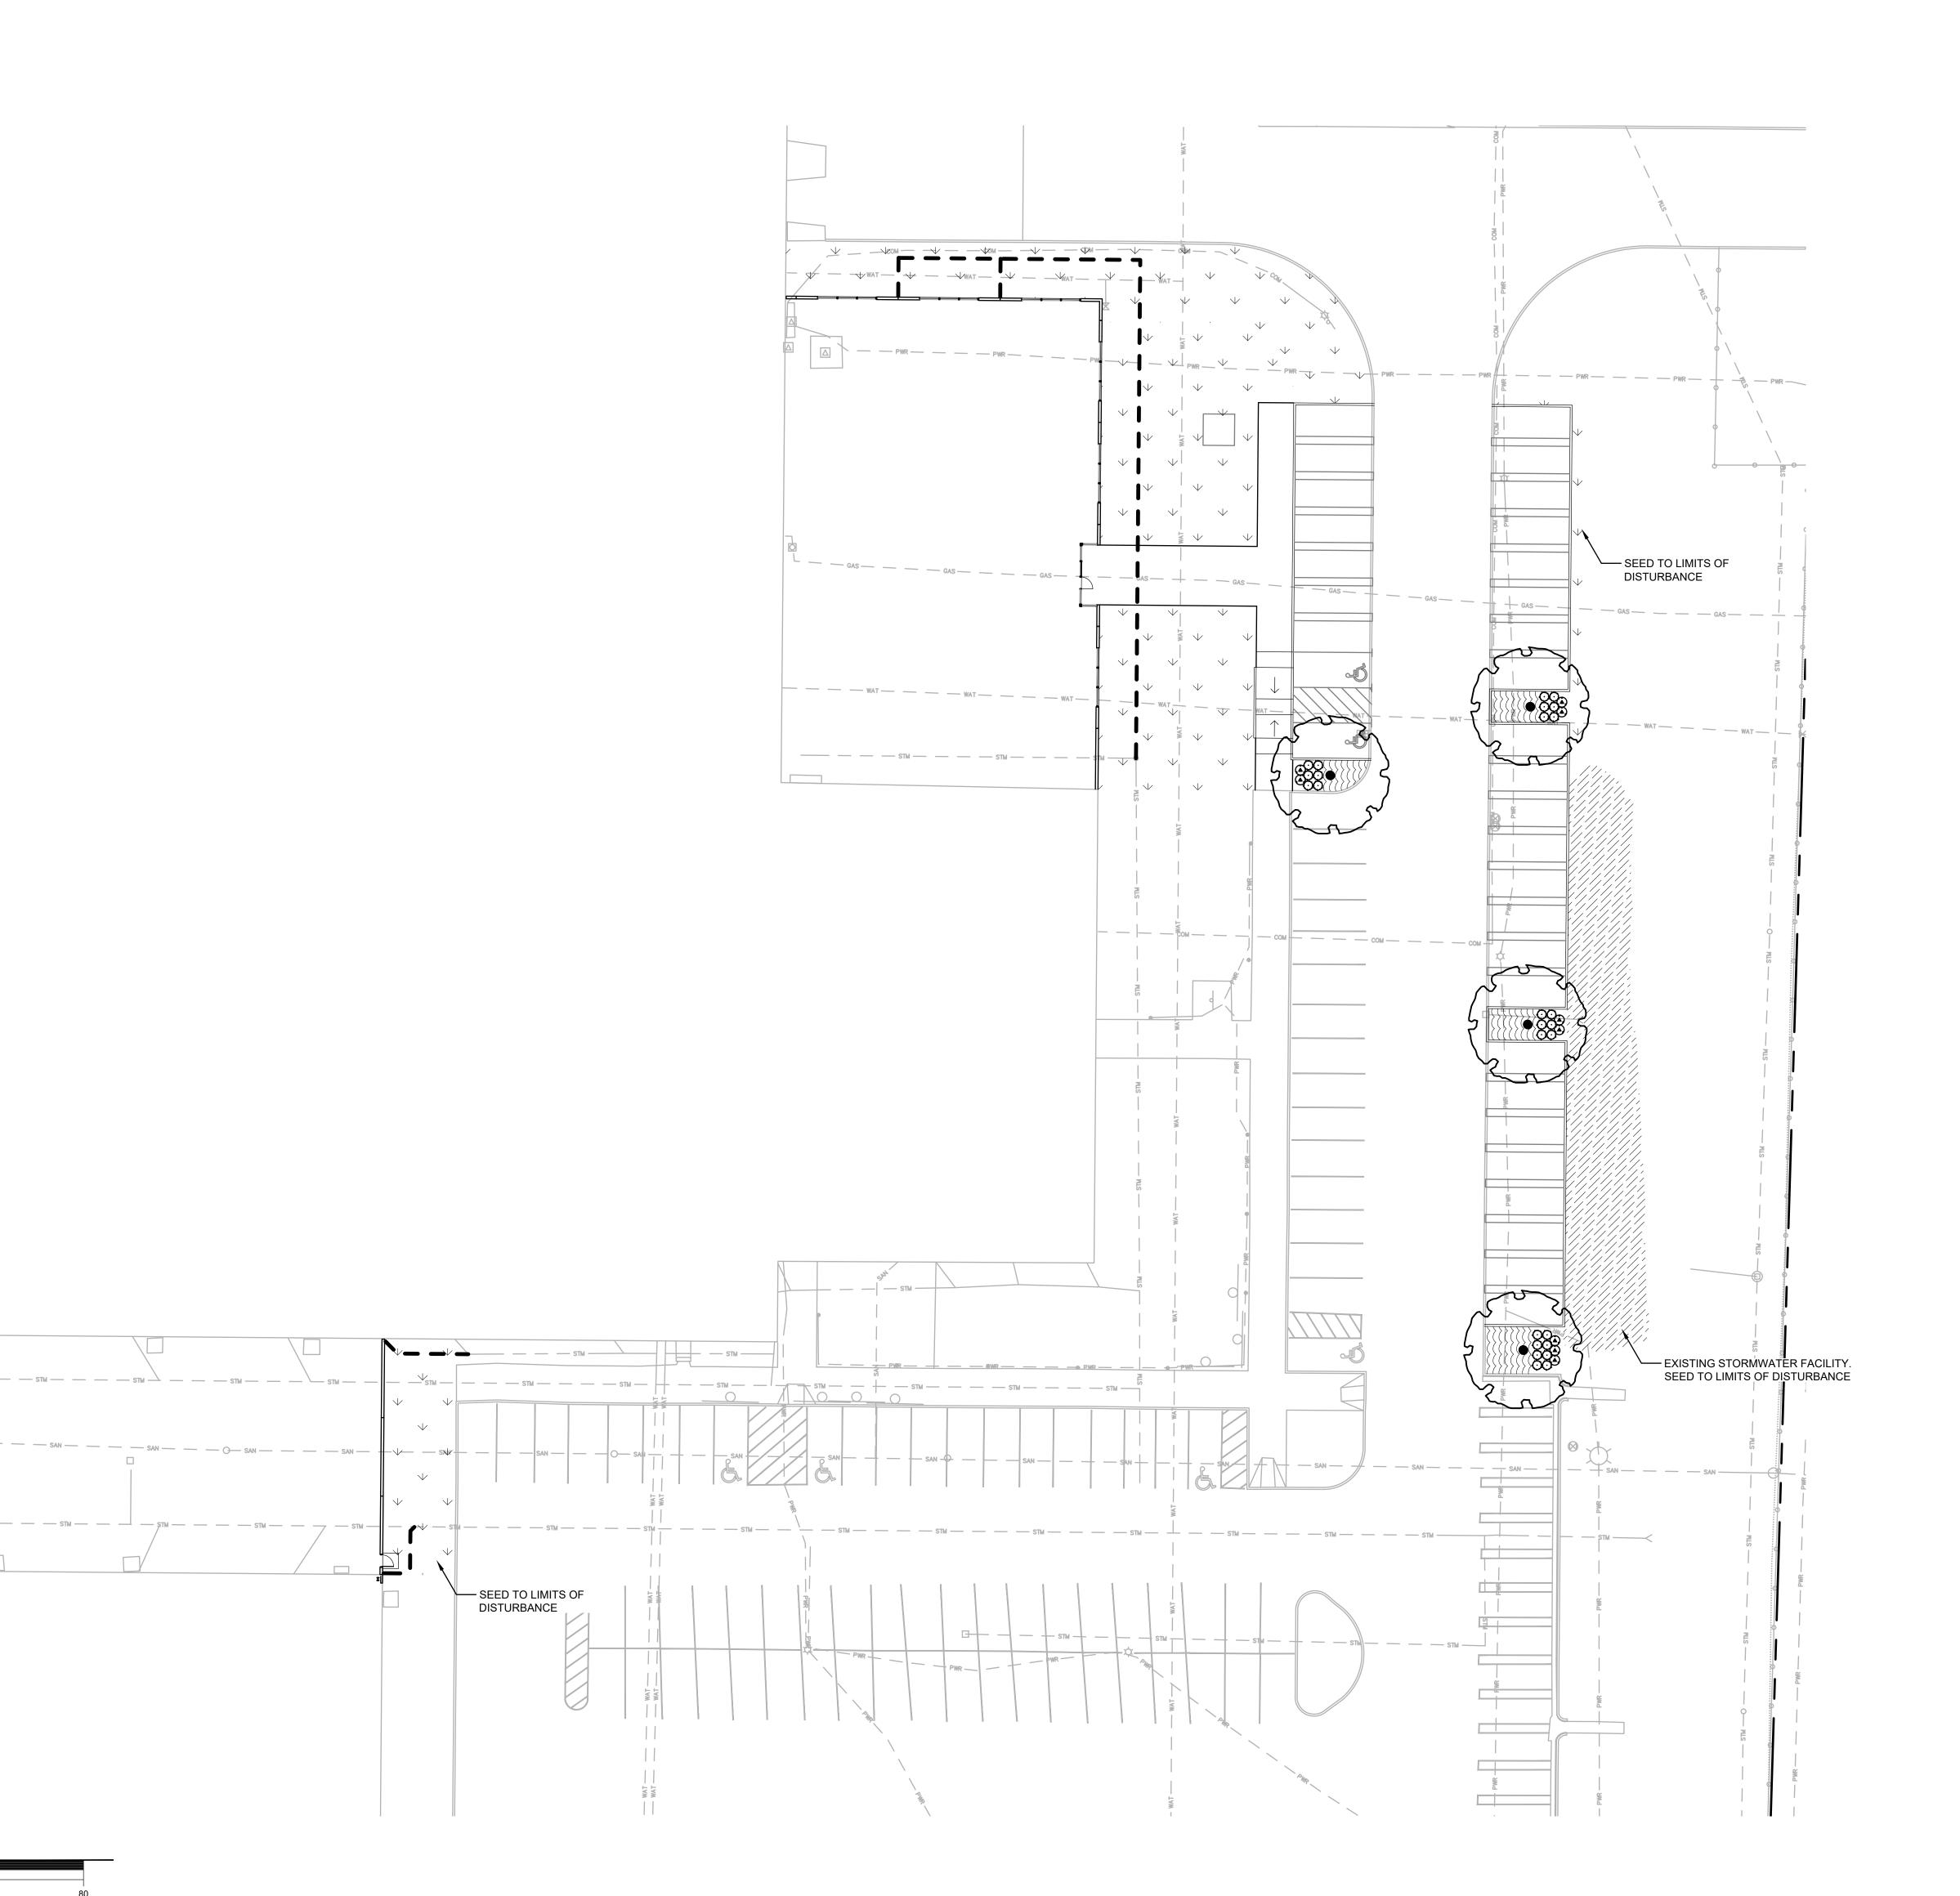
SEED TO LIMITS OF DISTURBANCE

LU SUBMITTAL - APRIL 14, 2022

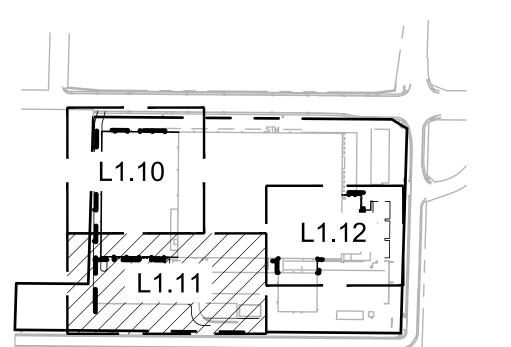221047100\DRAWINGS\LANDSCAPE\471_L0.01.DWG:L1.11 AB 04/01/22 12:16 1:0.08

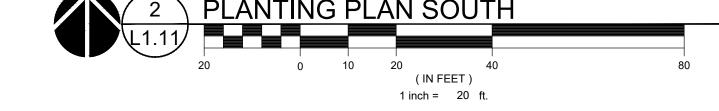

1 inch = 20 ft.



SEED TO LIMITS OF DISTURBANCE

(IN FEET)
1 inch = 20 ft.

PLANT KEY LEGEND

BOTANICAL / COMMON NAME



MATURE (150° H X 40° W) MEDIUM TREE



ZELKOVA SERRATA 'GREEN VASE' SAWLEAF ZELKOVA MATURE (85' H X 75' W) LARGE TREE

<u>SHRUBS</u> BOTANICAL / COMMON NAME BERBERIS THUNBERGII 'ATROPURPUREA NANA'

DWARF RED LEAF JAPANESE BARBERRY (3' H X 3' W) SMALL SHRUB SPIRAEA BETULIFOLIA BIRCH LEAF SPIREA

(3' H X 3' W) SMALL SHRUB

VIBURNUM TINUS LAURUSTINUS VIBURNUM (6-7' H X 5' W) LARGE SHRUB

GROUND COVERS BOTANICAL / COMMON NAME

EUONYMUS FORTUNEI 'COLORATUS' COLORATUS PURPLE WINTERCREEPER 24" HEIGHT



MAHONIA REPENS CREEPING MAHONIA 18" HEIGHT, NATIVE NW

SEED MIX TYPE A



SEED MIX TYPE B



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REFERENCE NOTES


KEY MAP

SCALE: NTS


- 1. PLANT SIZE, SPACING, AND QUANTITY, SEE PLANT SCHEDULE L0.01. 2. EXISTING TREE TO REMAIN. DO NOT DISTURB. PROTECT IN PLACE. 3. CAREFULLY EXCAVATE SHRUB PITS IN VICINITY OF EXISTING TREES, WITHOUT DISTURBING TREE ROOTS.
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PLANTING PLAN EAST




DRAWN BY: AB CHECKED BY:

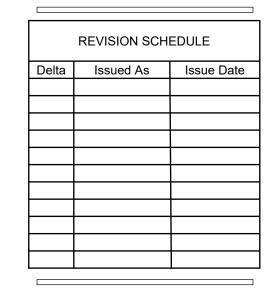L1.12

JOB NO. **2210471.00**

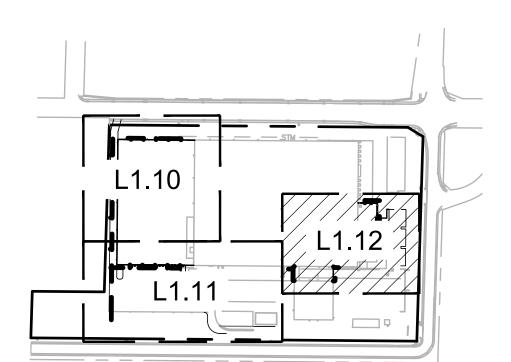LU SUBMITTAL - APRIL 14, 2022
221047100\DRAWINGS\LANDSCAPE\471_L0.01.DWG:L1.12 AB 04/01/22 11:41 1:0.08

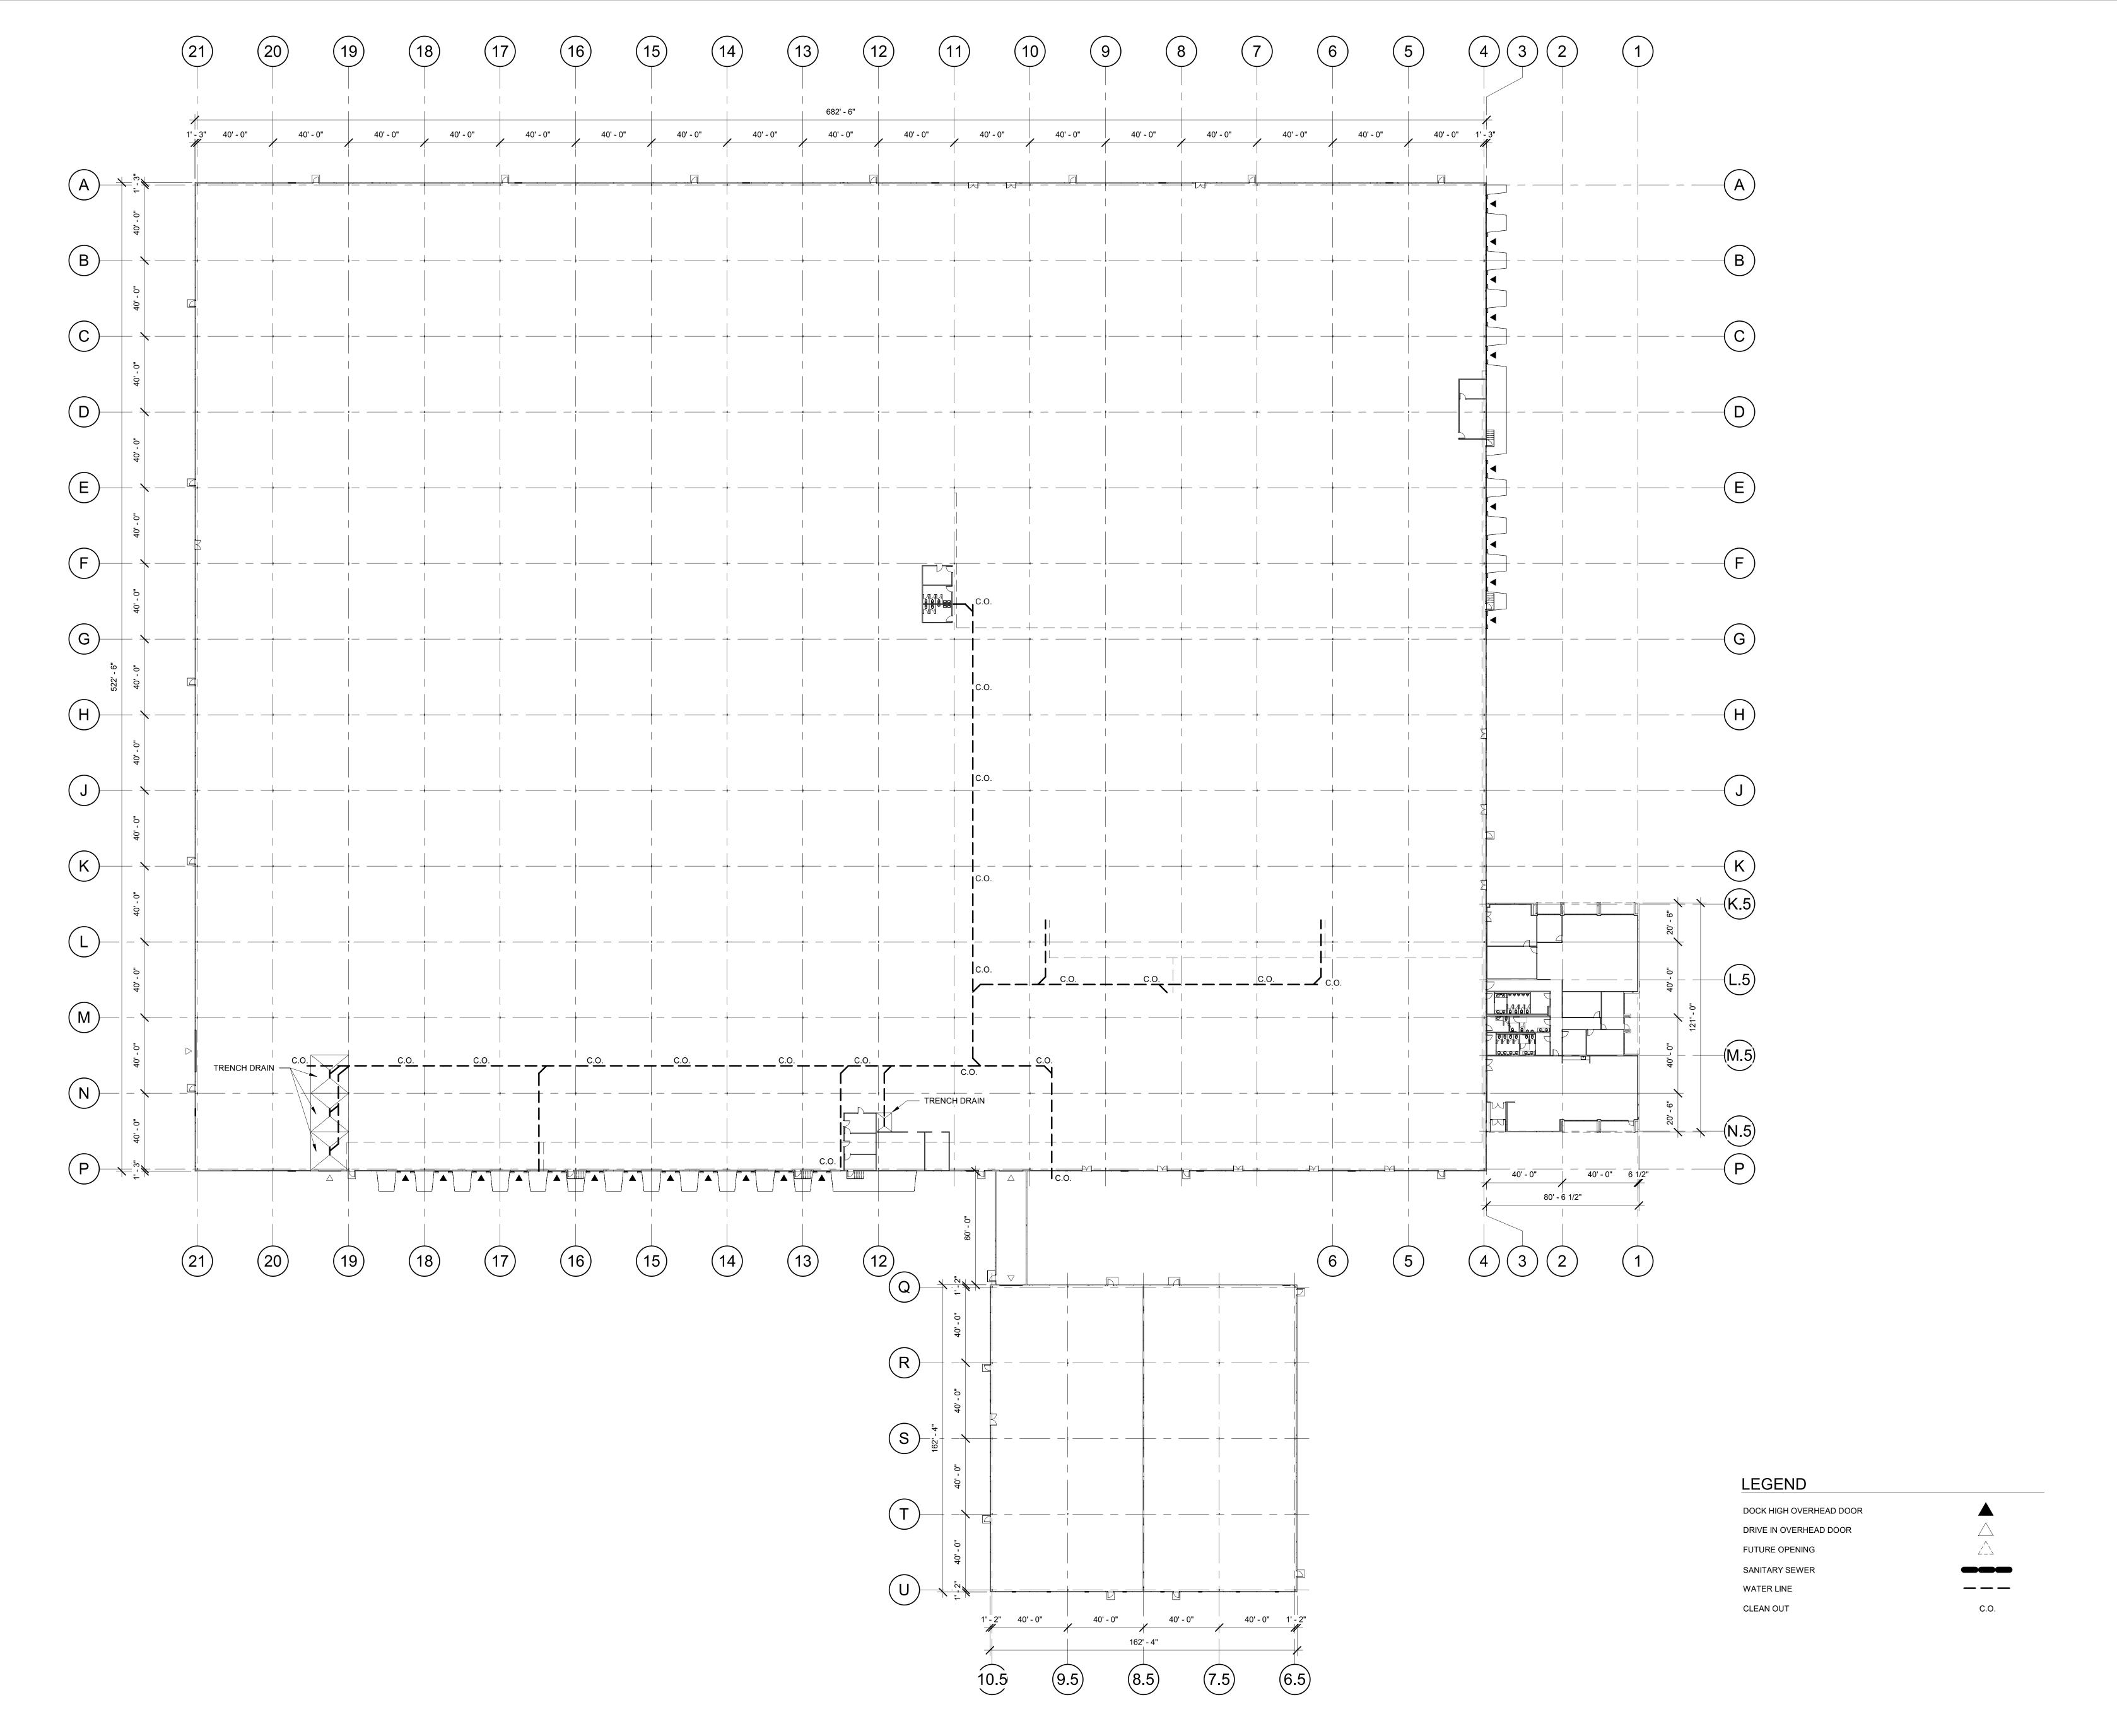

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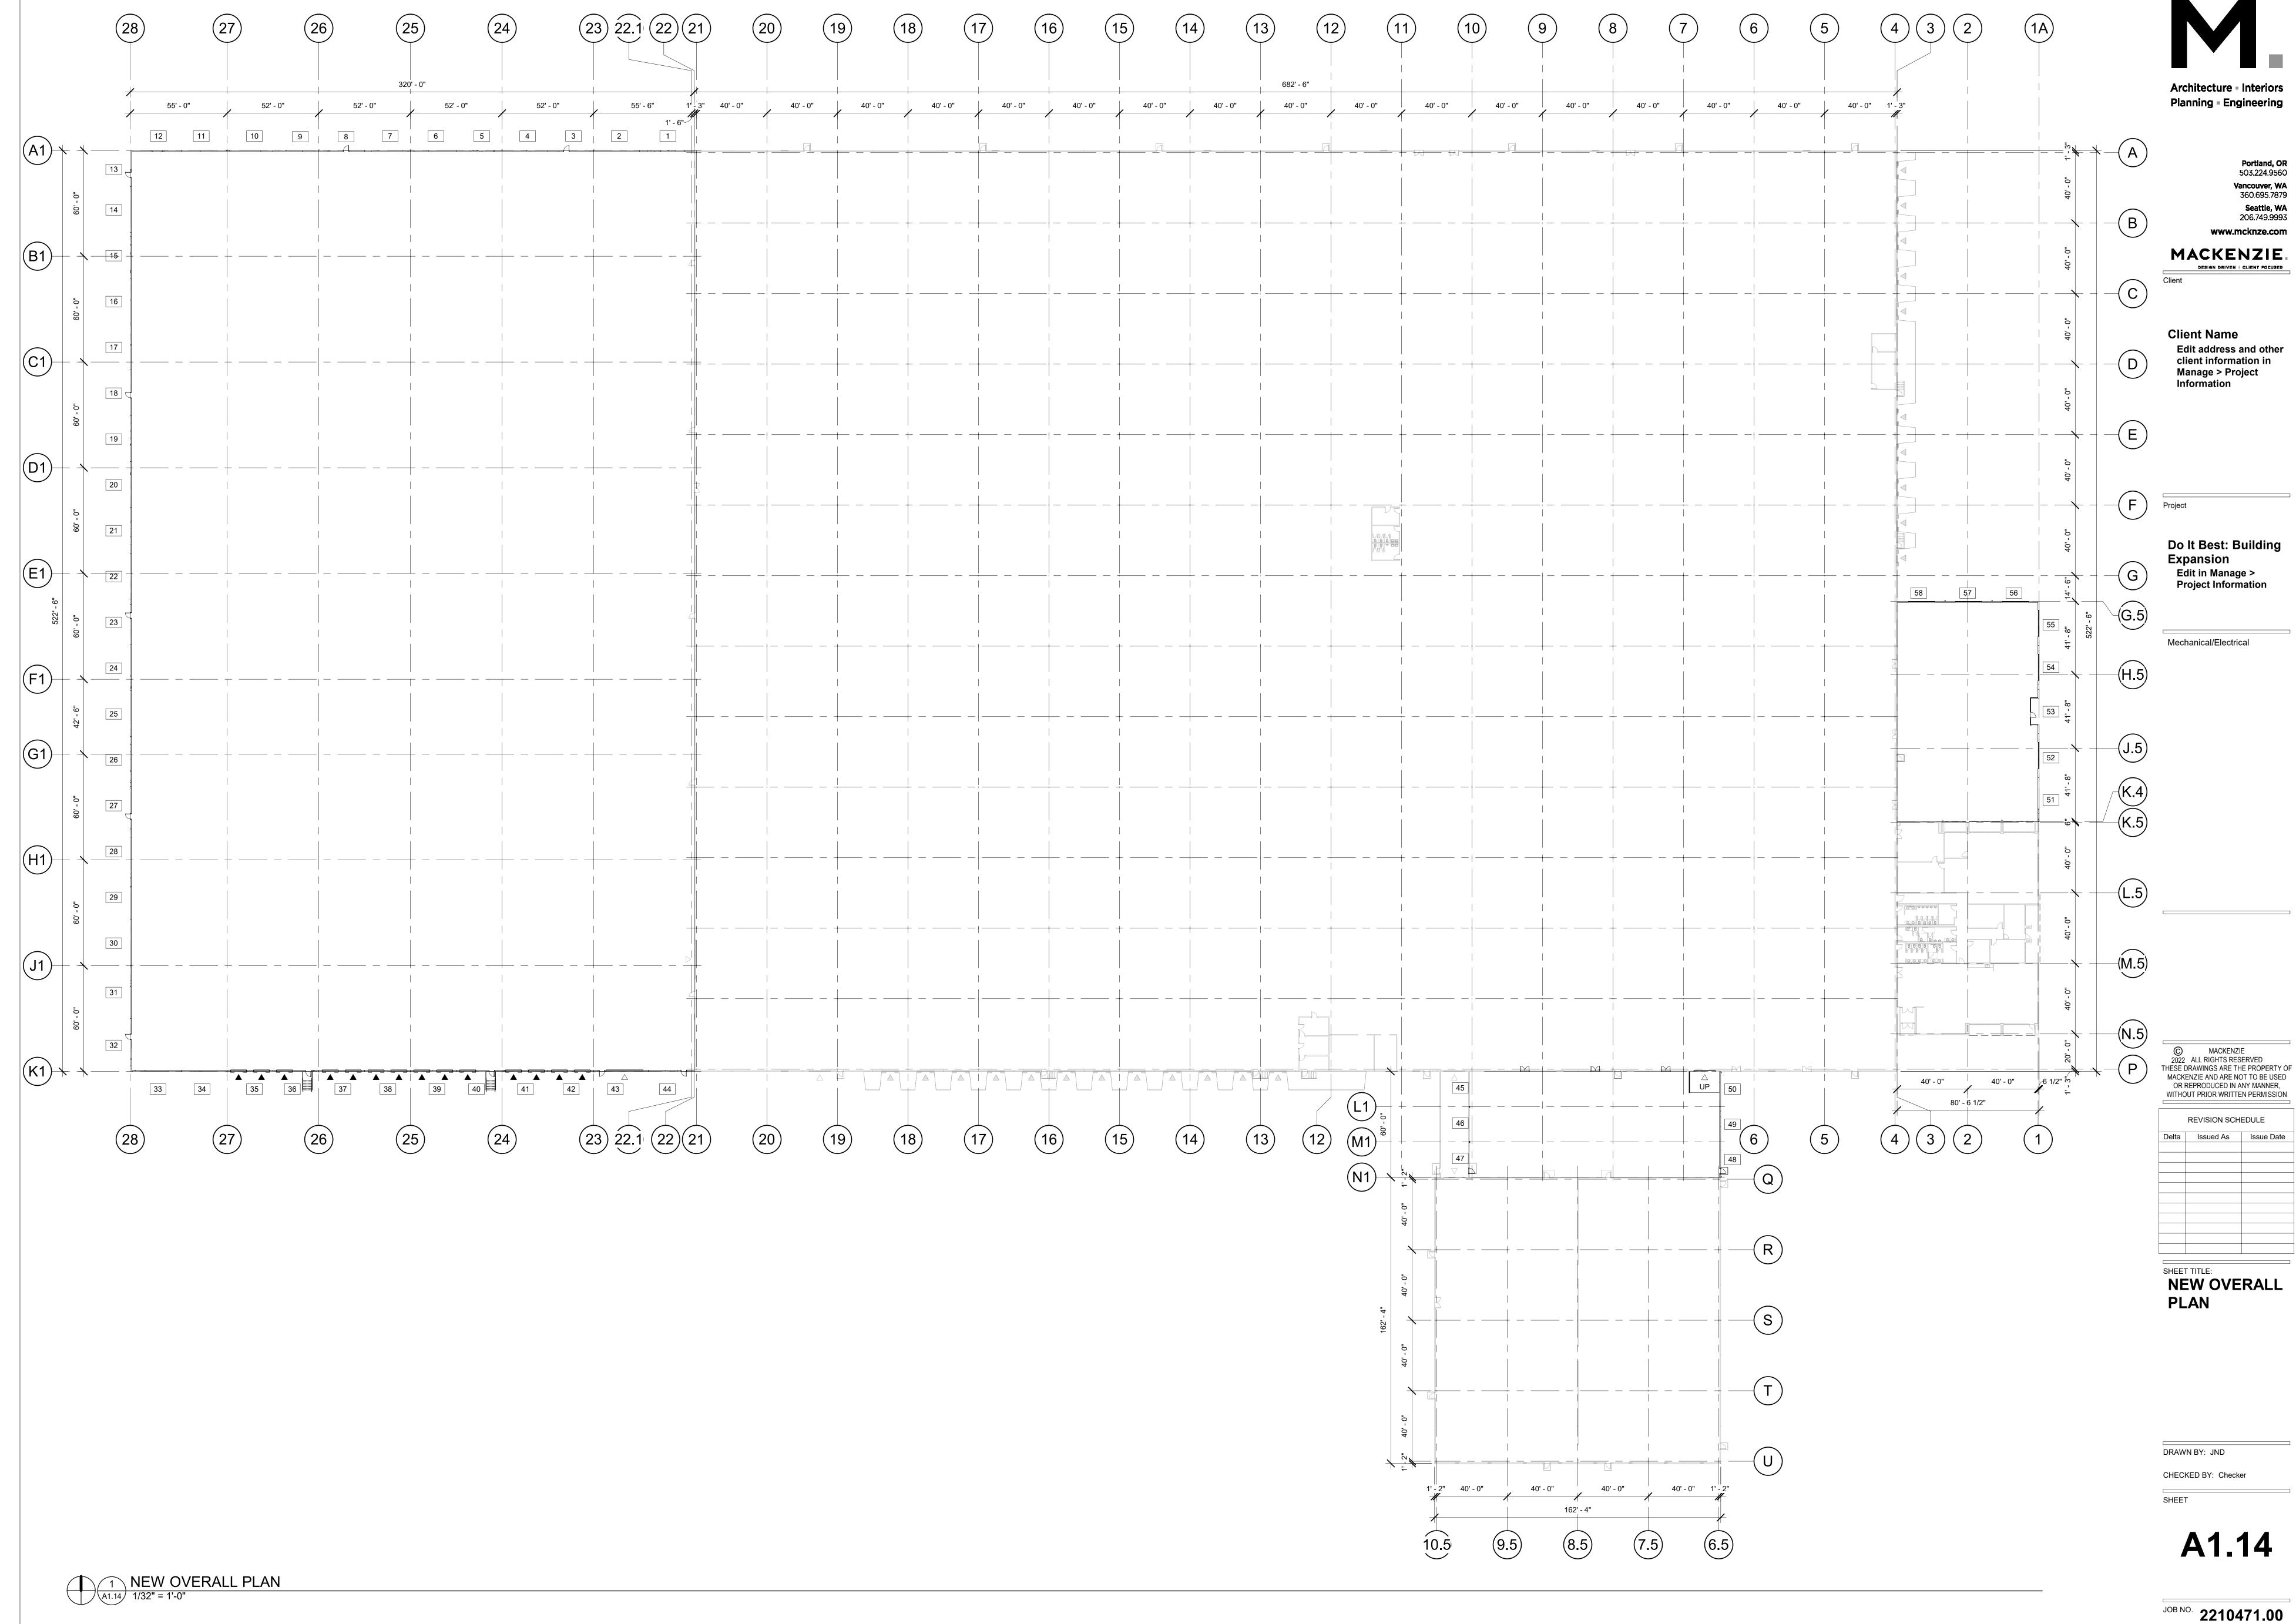
REVISION SCHEDULE

SHEET TITLE: **EXISTING OVERALL PLAN**

DRAWN BY: JND

CHECKED BY: REW

A1.10



2210471.00

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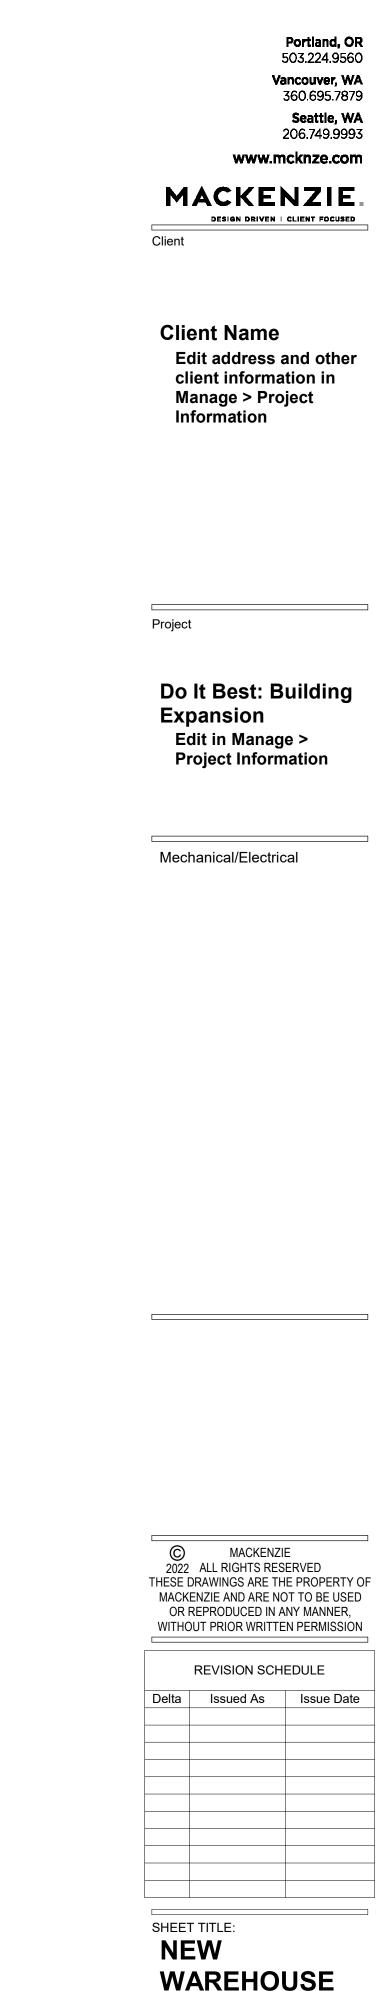
C:\Users\jnd\Documents\Revit Projects\2210471.00_DIB\471-DIB-V22-L.rvt 4/5/2022 12:59:39 PM 1/32" = 1'-0"

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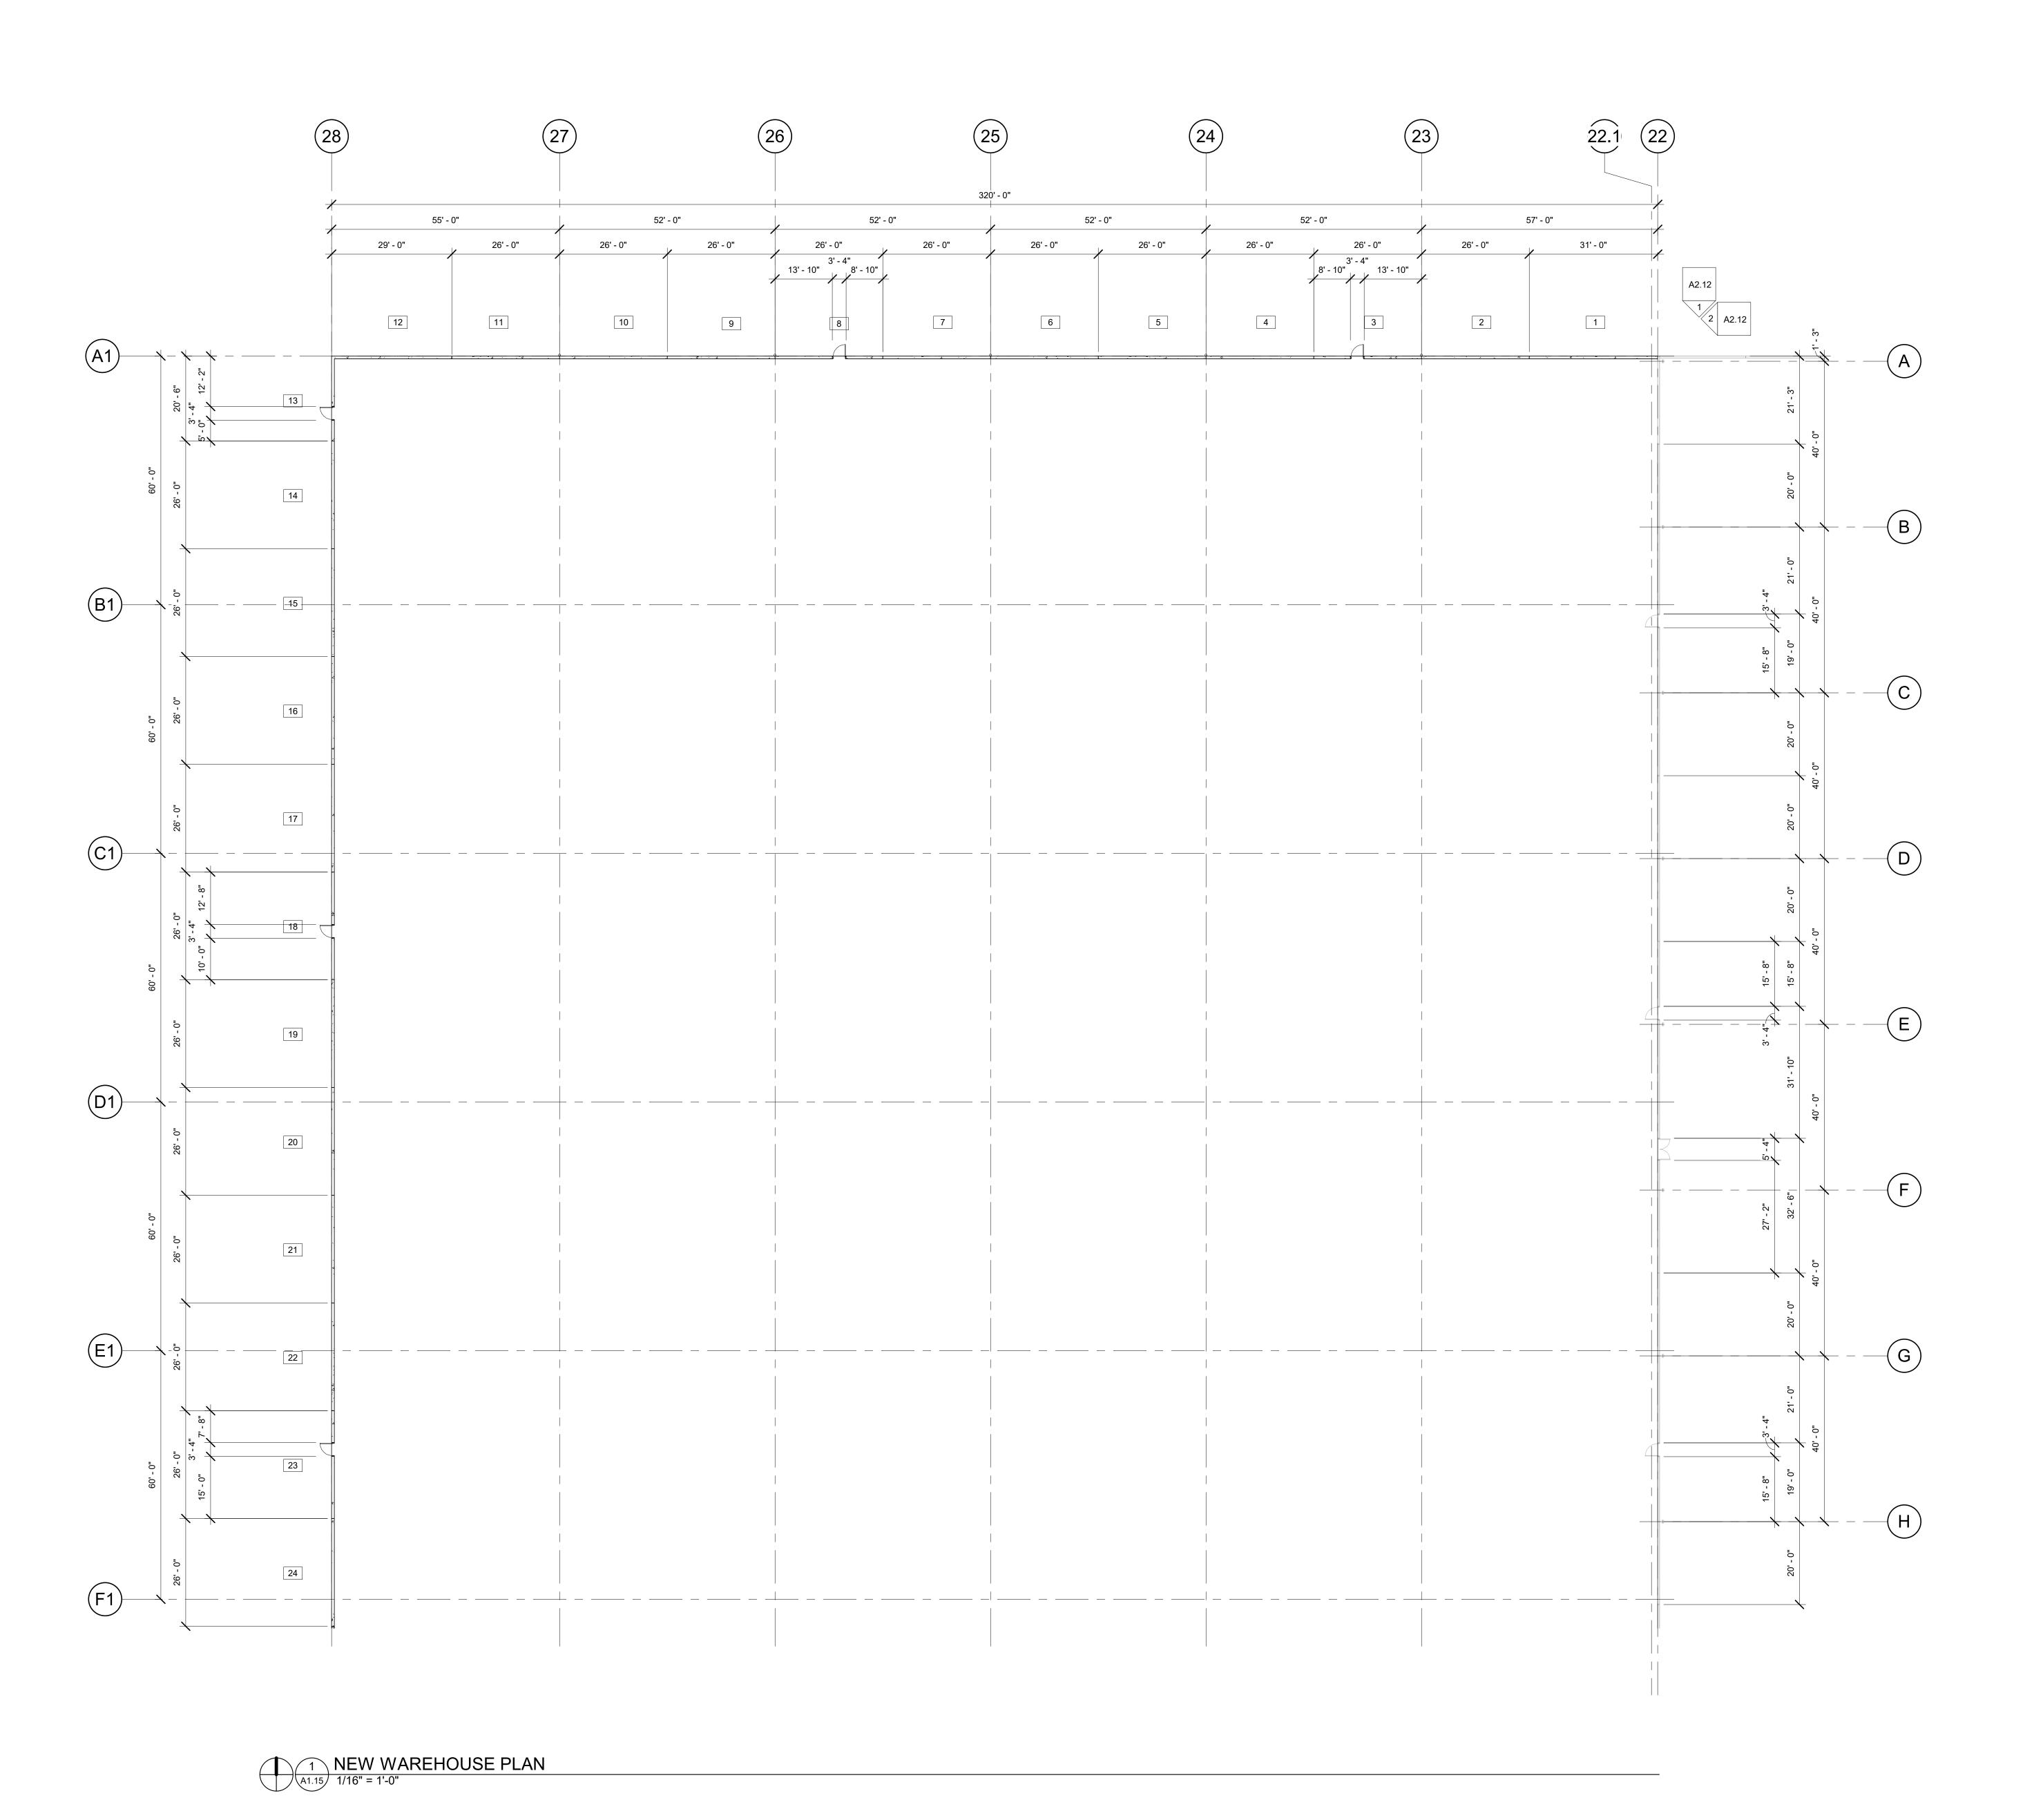
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SHEET TITLE:
NEW
WAREHOUSE
PLAN - NORTH

DRAWN BY: JND

A1.15





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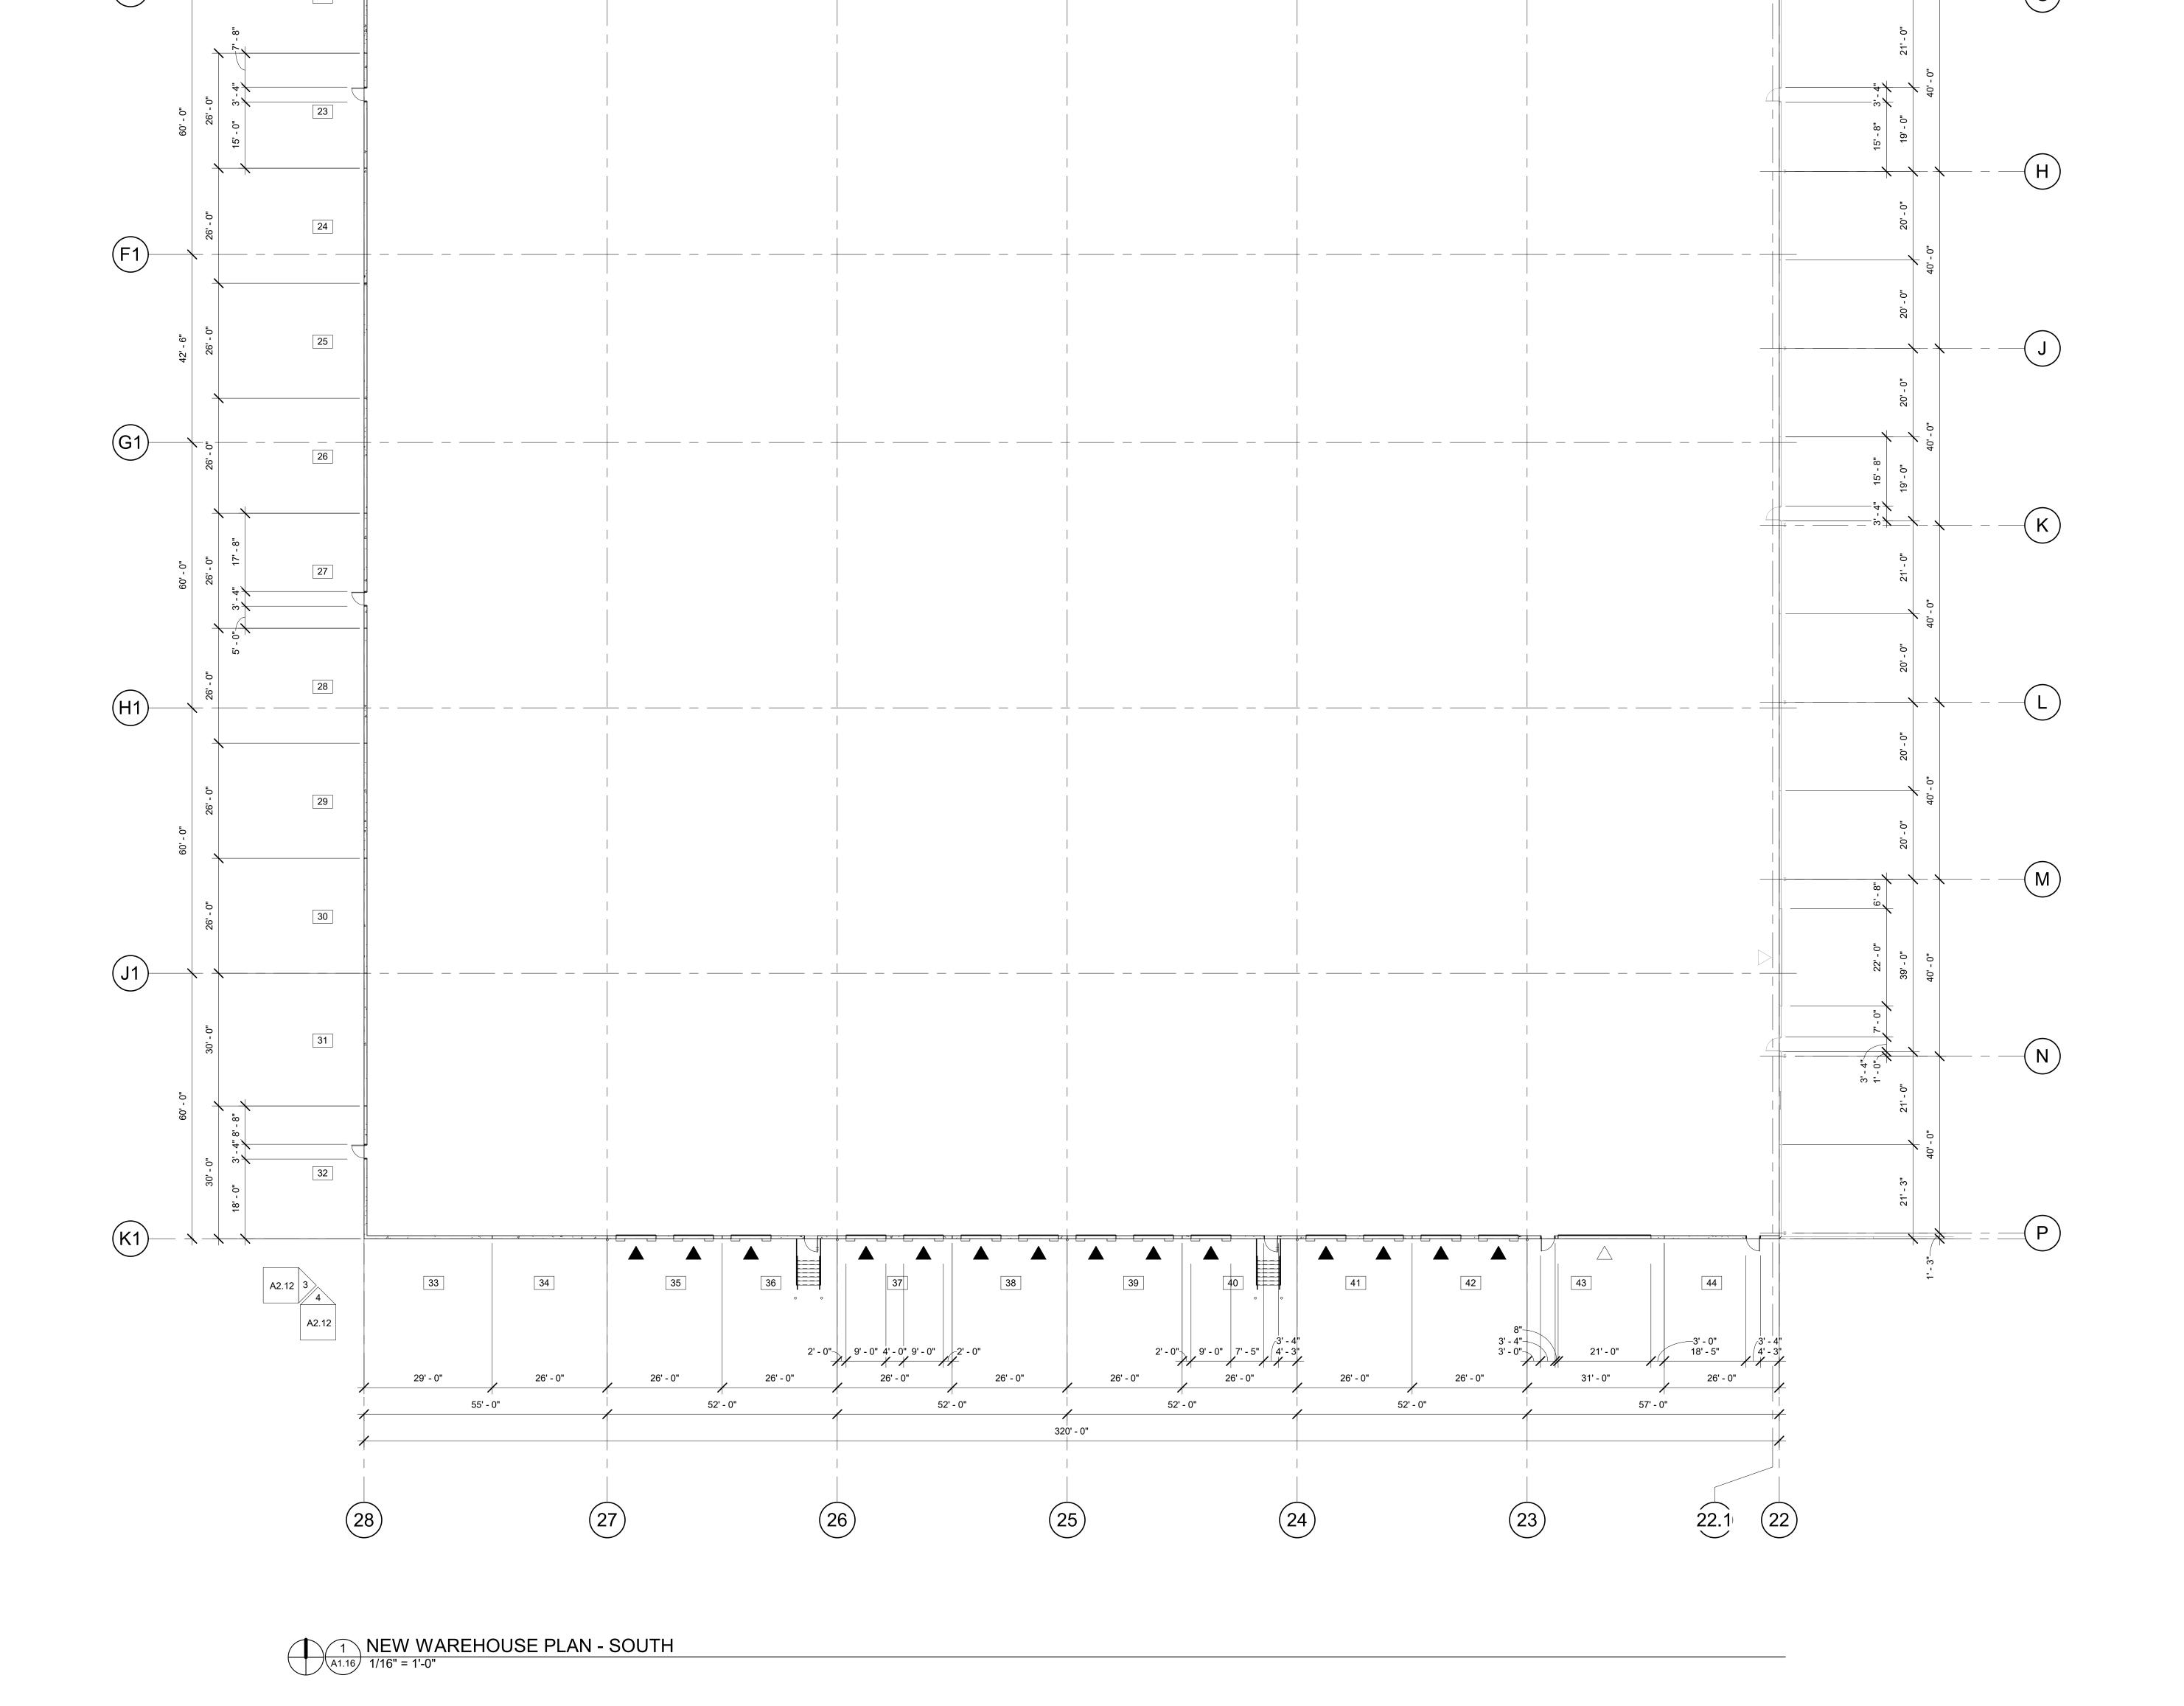
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WAREHOUSE PLAN - SOUTH

DRAWN BY: JND CHECKED BY: Checker

A1.16





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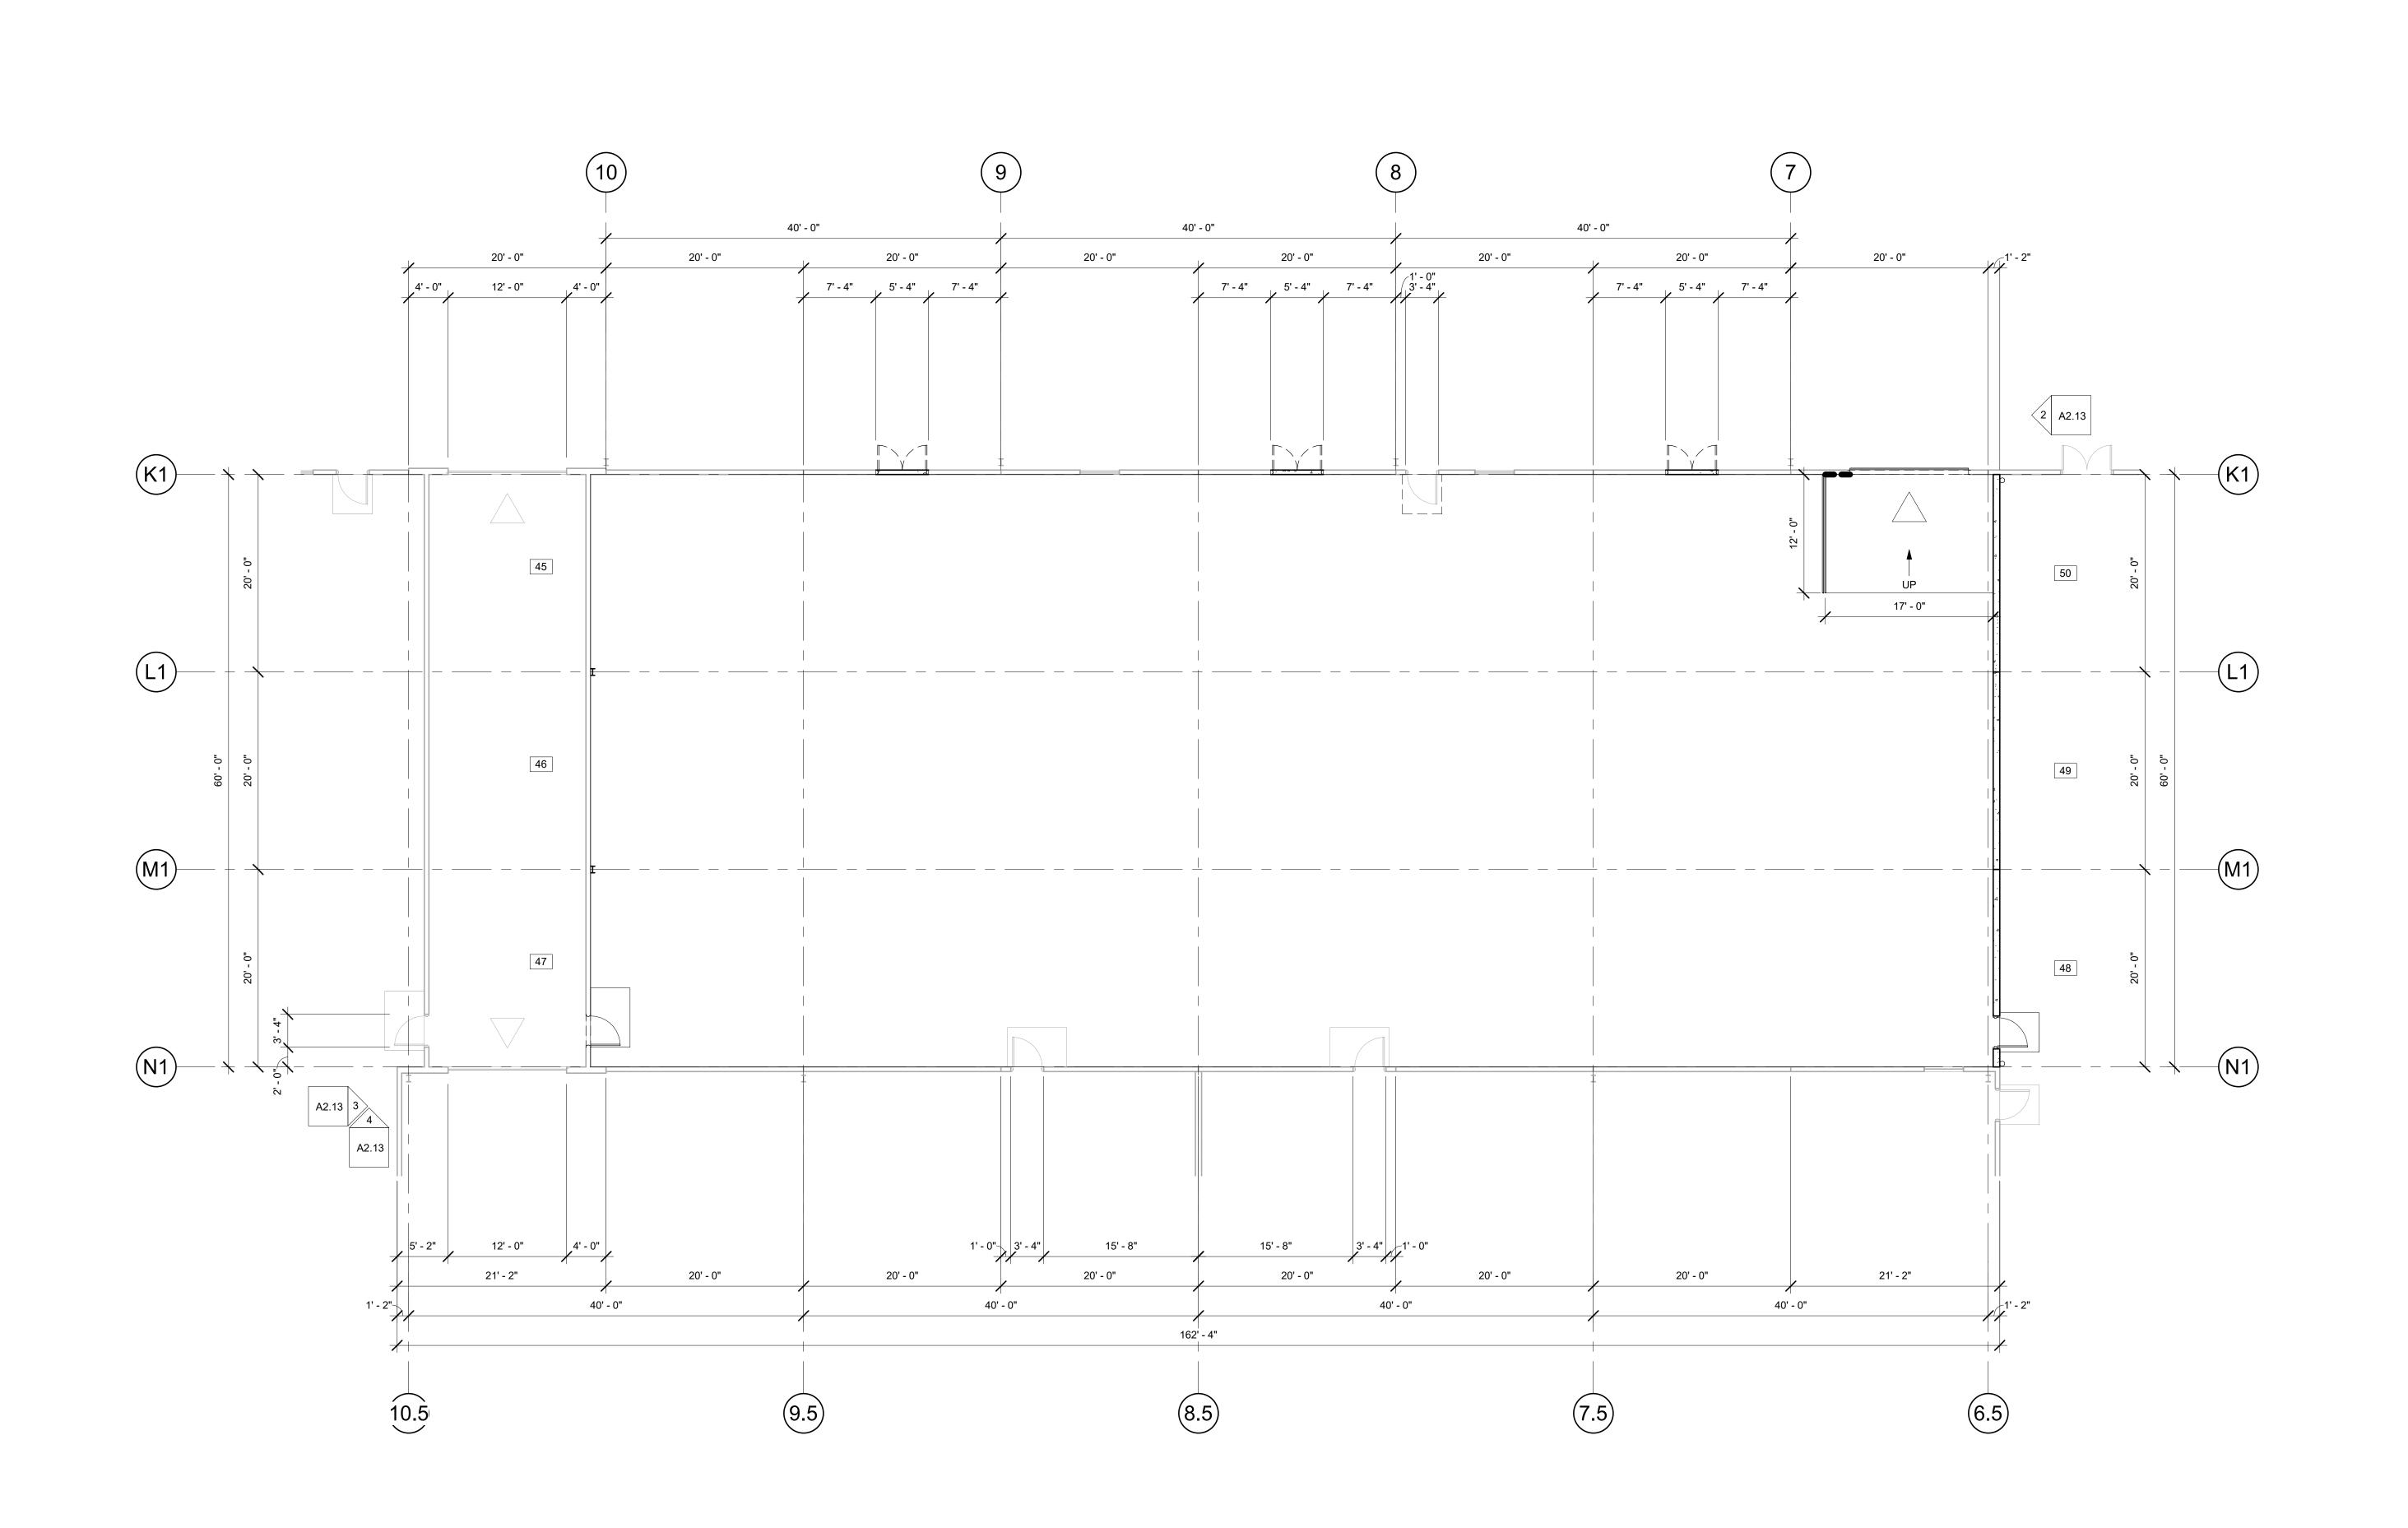
Delta Issued As Issue


SHEET TITLE:
NEW
FLAMMABLE
STORAGE
PLAN

DRAWN BY: JND

CHECKED BY: Checker





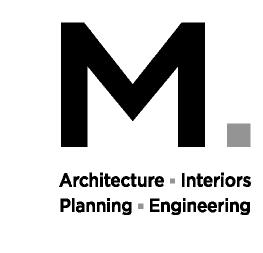



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SHEET TITLE:
ENLARGED **NEW OFFICE** PLAN

DRAWN BY: JND





26' - 4"

40' - 0"

12' - 8"

80' - 6 1/2"

17' - 5 1/4"

17' - 5 1/4"

40' - 0"

80' - 6 1/2"

26' - 8"

40' - 0"

26' - 8"

40' - 6 1/2"

26' - 8"

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EXISTING
BUILDING
ELEVATIONS

DRAWN BY: JND
CHECKED BY: REW

CHECKED BY: RI

SHEET

A2.10

(E)

(D)

(c)

 $\left(\mathsf{B}\right)$

(A)

DOCK APRON -4' - 0"

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25 DOCK APRON -4' - 0"

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> > REVISION SCHEDULE

SHEET TITLE: **OVERALL BUILDING ELEVATIONS**

DRAWN BY: JND CHECKED BY: REW

A2.11

JOB NO. **2210471.00**

G1

(M.5)

(L.5)


4 OVERALL - WEST ELEVATION
A2.11 1/32" = 1'-0"

2 OVERALL - EAST ELEVATION

3 OVERALL - SOUTH ELEVATION

A2.11 1/32" = 1'-0"

A2.11) 1/32" = 1'-0"

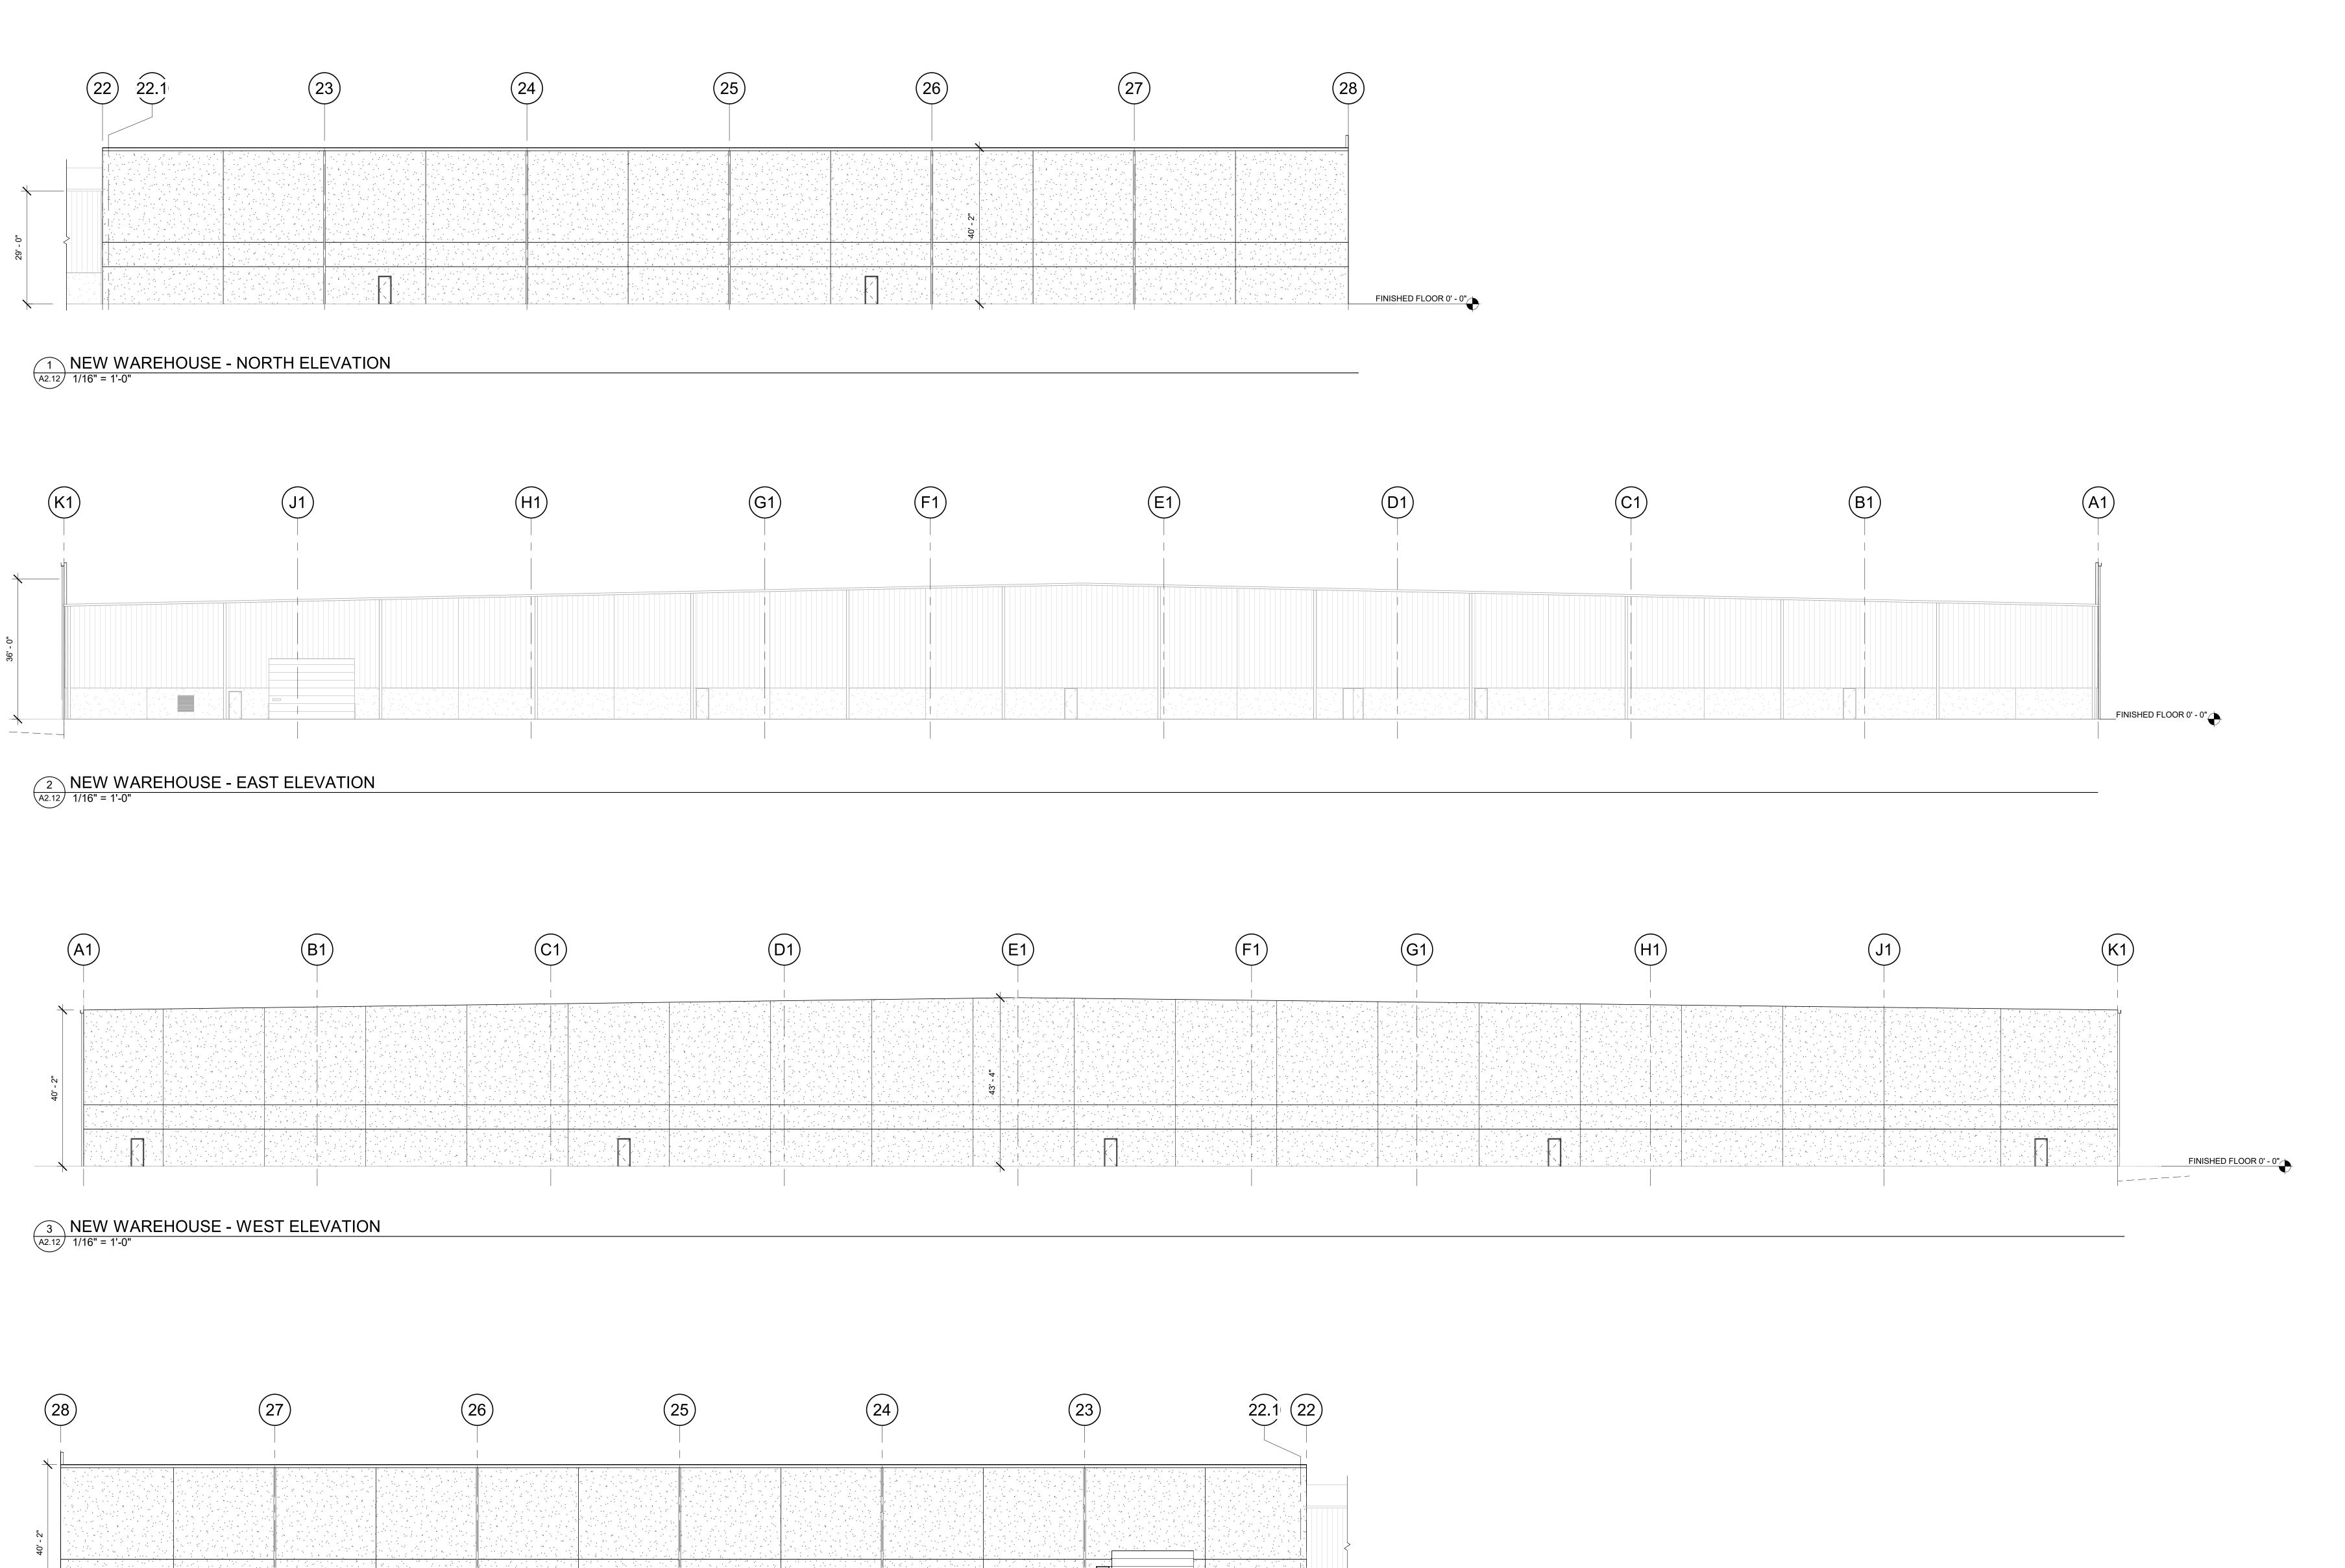

4 NEW WAREHOUSE - SOUTH ELEVATION
A2.12 1/16" = 1'-0"

DOCK APRON -4' - 0"

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SHEET TITLE:


NEW BUILDING


ELEVATIONS


DRAWN BY: JND
CHECKED BY: Checker

SHEET

A2.12

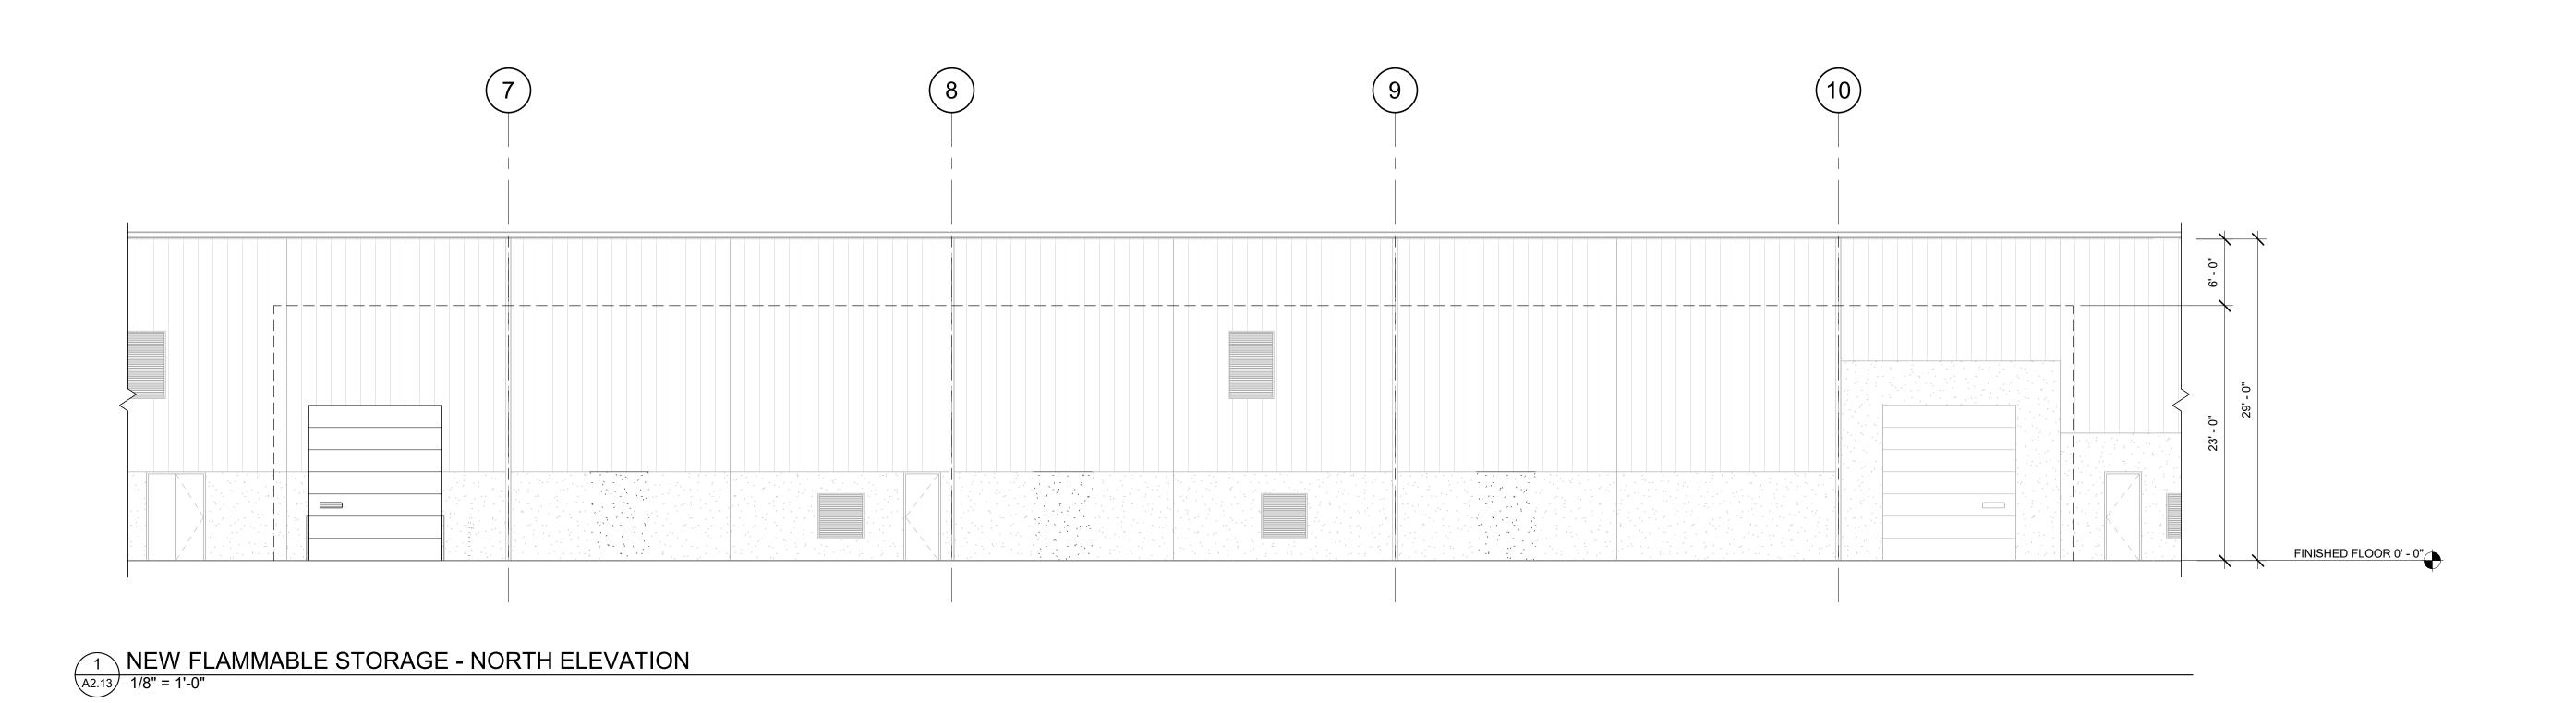

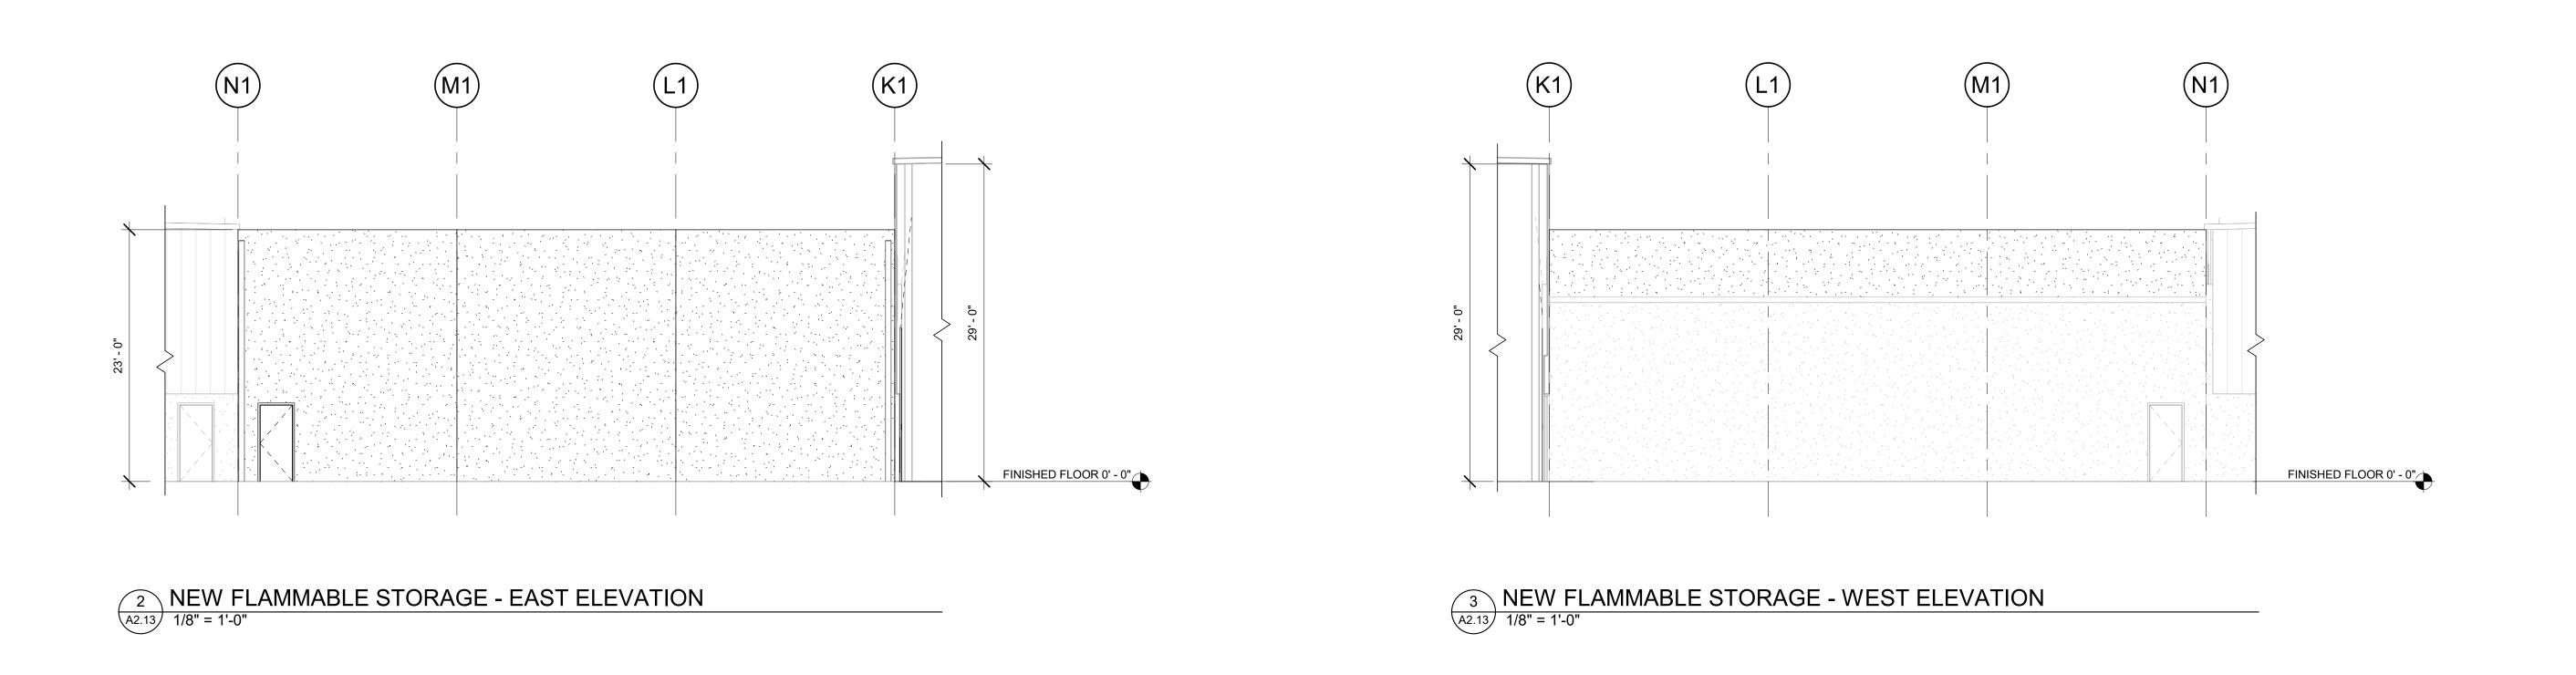

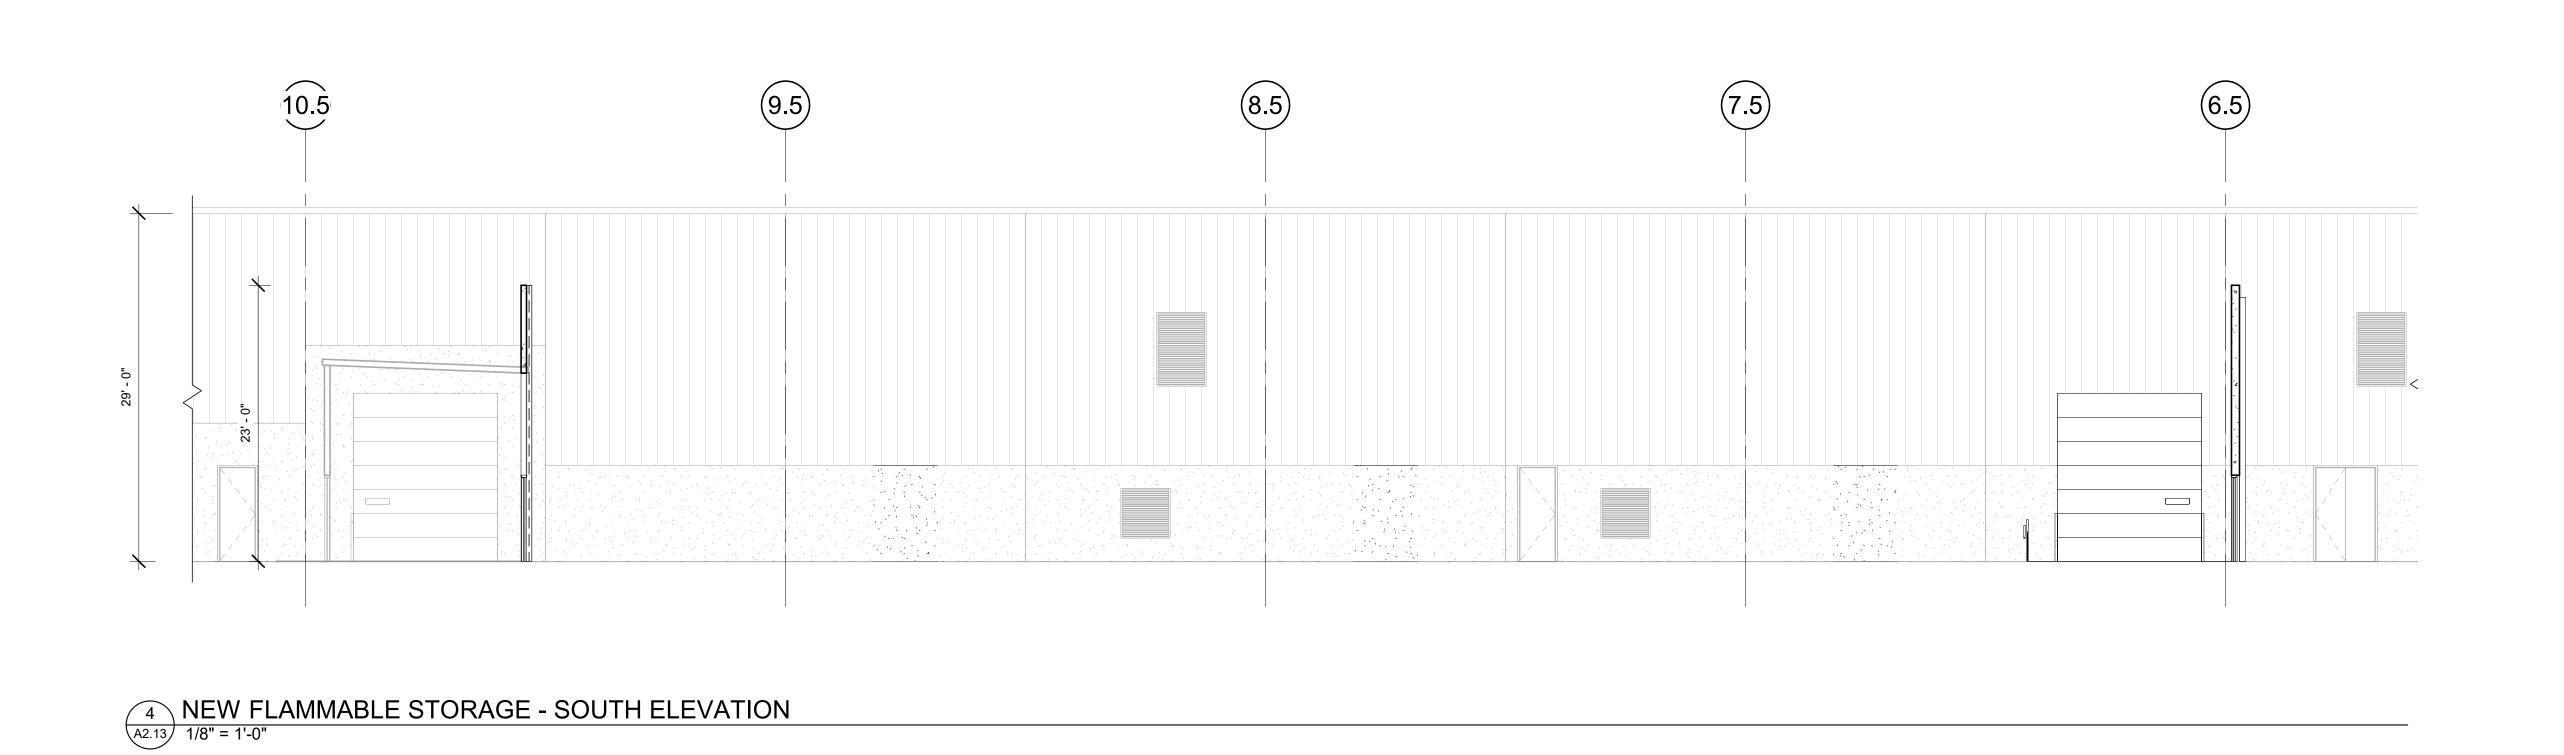

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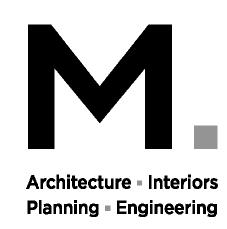
REVISION SCHEDULE

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SHEET TITLE:
NEW BUILDING
ELEVATIONS

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A2.13



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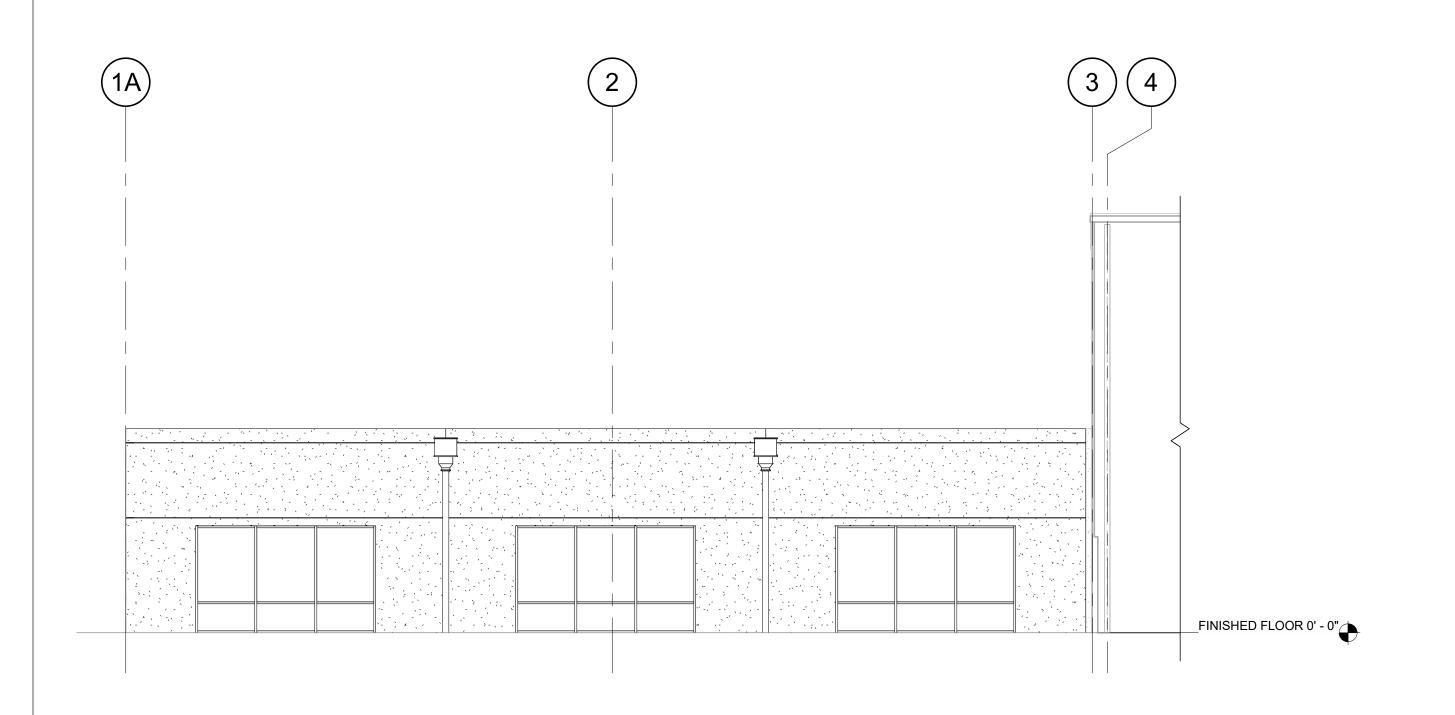
Do It Best: Building

Edit in Manage >
Project Information


Expansion

Mechanical/Electrical

Client Name





1 NEW OFFICE - NORTH ELEVATION
A2.14 1/8" = 1'-0"

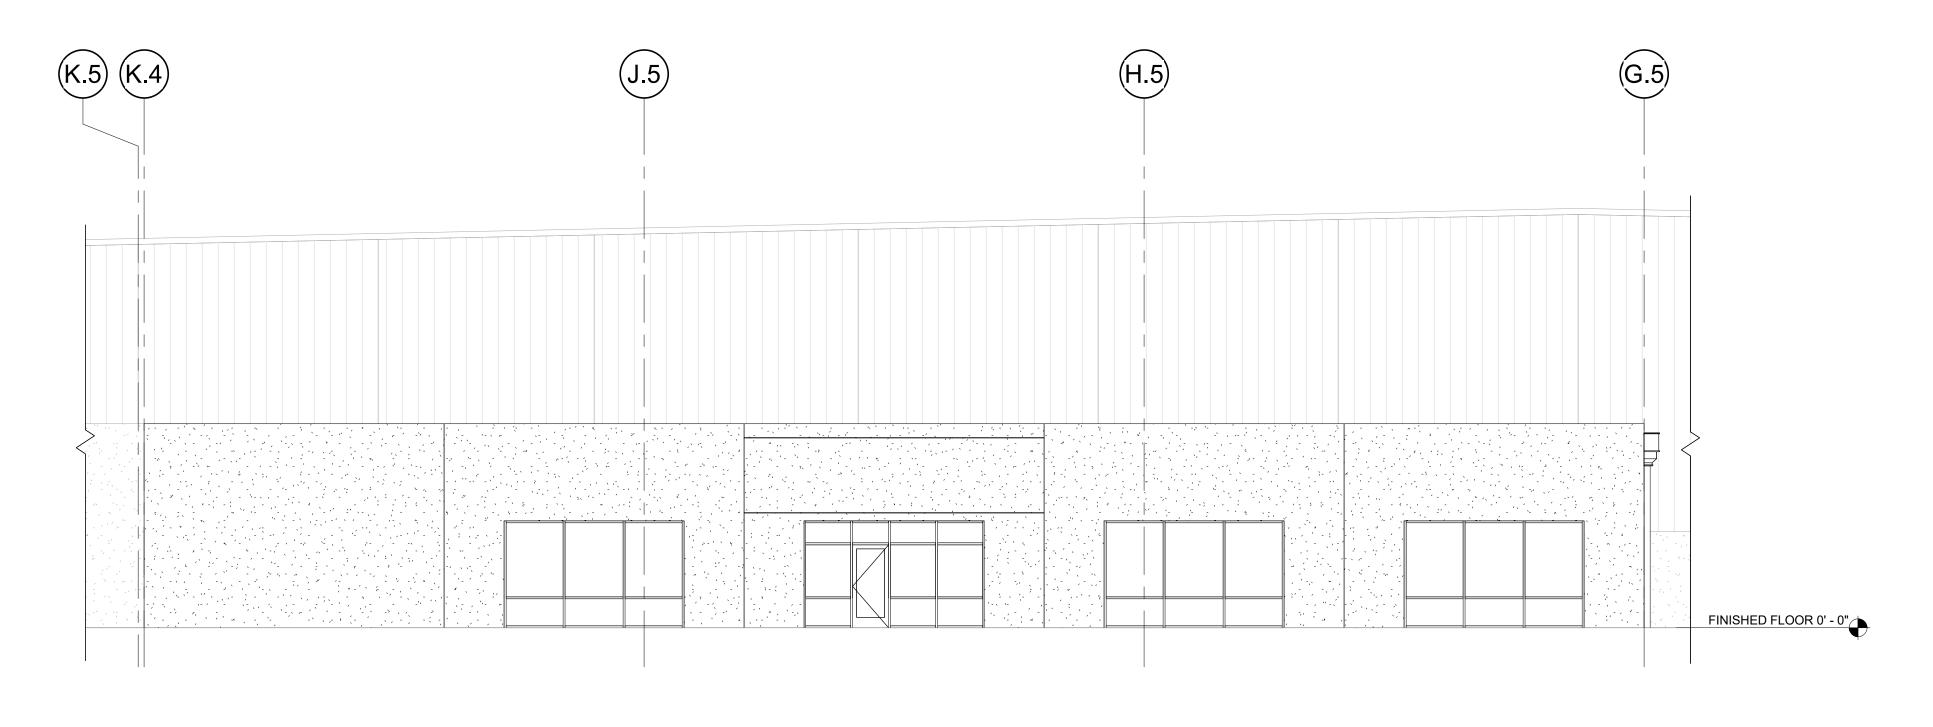

NEW OFFICE - EAST ELEVATION

A2.14 1/8" = 1'-0"

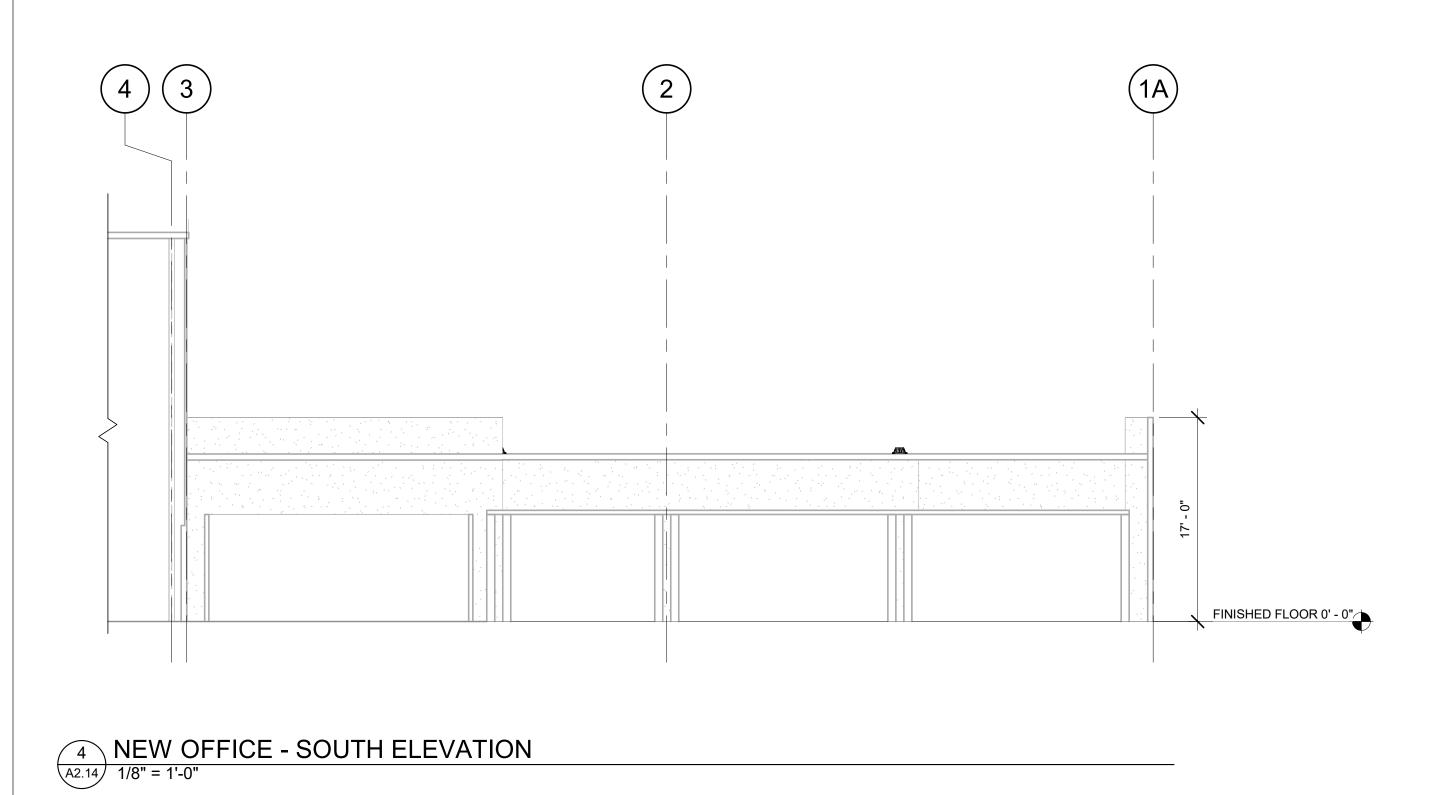

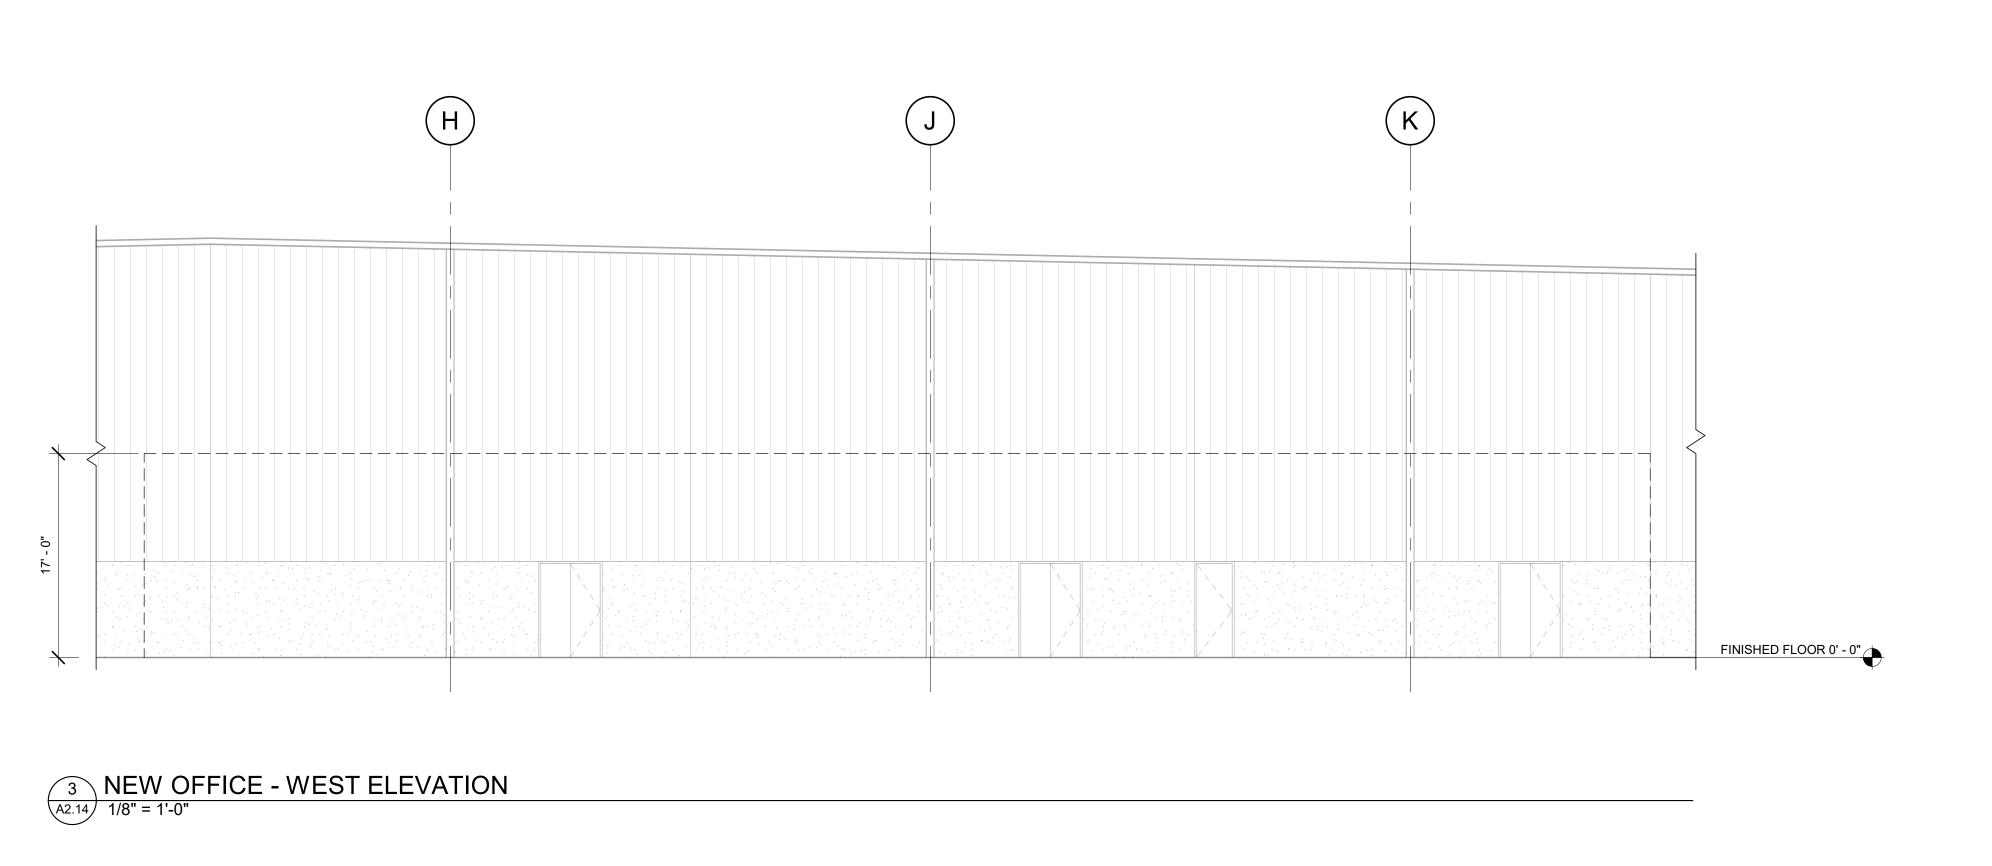

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SHEET TITLE:

NEW BUILDING

ELEVATIONS

DRAWN BY: JND
CHECKED BY: Checker

A2.14

