

#### **Final Decision**

#### **Planning Commission**

File number(s):

DR 23-03, PLA 23-03, SA 23-02, & VAR 23-05

Project name:

Commerce Way Industrial Park

Date of decision:

October 12, 2023

Date of mailing:

October <u>19</u>, 2023

Applicant:

Todd Woodley, COBALT

Landowners:

WB Commerce 100 LLC & WB Commerce 5000 LLC

Site location:

1414 Commerce Way (Tax Lots 051W07DA00100 & 051W08CB05000)

**Decision:** 

Approved with Conditions



Aerial view of the site

#### **Proposed Development**

The subject properties encompass an 11.04-acre site along the east side of Commerce Way. They are within the Light Industrial (IL) zoning district; the Riparian Corridor and Wetlands Overlay District (RCWOD) also covers a portion of the site. The site is undeveloped, except for a telecommunications tower that was recently approved (CU 2020-02 & VAR 2020-07).

The proposal before the Planning Commission was a Design Review application for an industrial park project consisting of two buildings and related site improvements (parking lot, loading bays, and landscaping). A Property Line Adjustment application was included to adjust the shared property boundary between the two lots. A Street Adjustment application was included to request a modified cross-section for Commerce Way. A Variance application was also included, requesting to modify the height limit requirements for exterior light fixtures.



Conceptual Rendering of the Development

#### **Public Hearing Summary**

On October 12, 2023, the Planning Commission held a public hearing for this Type III application package. No testimony was received. After closure of the record, the Commission voted unanimously to approve the application package with the conditions recommended by staff in the staff report published October 5, 2023.

The applicant's Street Adjustment request for a modified Commerce Way cross-section was approved by the Commission. The cross-section is dependent upon a partial right-of-way vacation along Tax Lot 5000, which the City Council must approve.

The Commission also approved the applicant's Variance request for wall light fixtures at 14.5 feet above grade within parking areas and 20 feet above grade in the loading areas.

#### **Conditions of Approval**

#### General

- 1. Substantial Conformance: The applicant or successor shall develop the property in substantial conformance with the final plans submitted and approved with this application, except as modified by these conditions of approval. Were the applicant to revise plans other than to meet conditions of approval or meet building code, even if Planning Division staff does not notice and signs off on building permit issuance, Division staff retains the right to obtain restoration of improvements as shown on an earlier land use review plan set in service of substantial conformance.
- 2. Public Works conditions: The developer shall follow the attached "Public Works Conditions October 5, 2023" (Attachment 102).
- 3. Addressing: Prior to recordation of the property line adjustment, the developer shall submit an Address Assignment Request Form, with accompanying fee payment and materials, to the Community Development Department to begin the process of getting addresses assigned.
- 4. Property line adjustment: The developer shall record the property line adjustment with Marion County in a manner acceptable to the Marion County Surveyor. Recordation of the adjustment shall be completed prior to building permit issuance.
- 5. Fence permit: To demonstrate conformance with 2.06.02 and 5.01.03, the developer shall submit application for and obtain approval of a Fence Permit for any new fencing. Such fencing must also receive approval from the Woodburn Fire District.
- 6. Grading permit: Prior to beginning any grading work on-site, the developer shall apply for and obtain a Grading Permit from the City per 5.01.04.
- 7. Sign permit(s): To demonstrate conformance with 3.10 and 5.01.10, submit application for and obtain approval of a Sign Permit for any new signage.

#### Right-of-Way & Easements

- 8. Right-of-way dedication: Developer shall dedicate Commerce Way right-of-way for Tax Lot 100, as illustrated on Sheet C-1.03. Dedication would occur concurrently with recordation of the property line adjustment.
- 9. Easements: The developer shall grant the following easements concurrently with recordation of the property line adjustment. Prior to recordation, submit a draft copy to the City for review.

- a. Streetside public utility easements: To meet 3.02.01B & F2, an 8-foot-wide streetside public utility easement along the site frontage of Commerce Way as illustrated on Sheet C-1.05.
- b. On-site public utility easements: To meet 3.02.01C, a 16-foot-wide public utility easement centered along the public water line running through the site.
- c. RCWOD easement: To meet 3.01.08C, 3.02.01D, and 3.02.02A, a public improvement and maintenance easement that follows the boundary of the Riparian Corridor & Wetlands Overlay District (RCWOD). This easement shall also allow for public trail access and trail improvements.
- d. Access easement: To meet 3.04.01A2 and 3.04.03C4a, a 60-foot-wide access easement centered on the shared property line.
- e. Refuse and recycling area: An access easement over Tax Lot 5000 benefiting Tax Lot 100, to provide access to the paved refuse and recycling bins area.
- 10. Vacation requests: Application materials illustrate and note certain vacations being requested (see Sheet C-1.03). Prior to recordation of the property line adjustment and prior to civil plans approval for public improvements, the developer shall successfully complete the vacation process for the following:
  - a. The requested right-of-way along Tax Lot 5000; and
  - b. The requested 30-foot-wide easement within Tax Lot 100 (MCDR Volume 442, Page 525).

#### **Transportation**

- 11. Commerce Way improvements: In conformance with the proposed street cross-section illustrated on Sheet C-0.03, the developer shall complete the following right-of-way (ROW) improvements to Commerce Way along the frontage of the subject properties:
  - a. Improvements: Construct street improvements to match the cross-section on Sheet C-0.03 and the site plan on Sheet C-1.07. Improvements are due prior to building permit issuance.
  - b. Street trees: To meet 3.01.04B and 3.06.03A, plant lawn grass and at least 21 small size street trees within the landscape strip. Small size trees are defined in Table 3.06B as having a height of 18-40 feet at maturity. Prohibited street tree species are outlined in Table 3.06C. If the minimum number of street trees cannot be planted due to interference with other public improvements, the fee-in-lieu for any street trees not planted is \$250 per tree (fee payment would be due prior to building permit issuance).
  - c. Access: To meet 3.01.02C, the driveway approaches shall comply with applicable Public Works Department standard drawings and specifications.
  - d. Fire turnaround: If required by the Woodburn Fire District for providing adequate access, developer shall provide a fire turnaround at the northern end of Commerce Way to the standards required by the Fire Marshal.

- 12. Truck route: Exiting semi-trucks shall utilize the 'Hardcastle Avenue > N. Front Street > OR Highway 214' route to exit the site; they are not permitted to travel east on Hardcastle Avenue or south on N. Front Street. Similarly, entering semi-trucks shall utilize the 'OR Highway 214 > N. Front Street > Hardcastle Avenue' route to access the site.
- 13. Traffic mitigation: The following are due prior to building permit issuance:
  - a. To alleviate current and future safety and capacity issues at the N. Front Street / OR Highway 214 ramp, the developer shall pay a proportionate share fee-in-lieu of \$40,500 to the City towards TSP Project R12 and any safety improvements at this location.
  - To alleviate current and future safety and capacity issues at the Settlemier Ave /
     N. Boones Ferry Road / OR Highway 214 intersection, the developer shall pay a proportionate share fee-in-lieu of \$6,923.23 to the City towards TSP Project R3.
  - c. To mitigate current and future safety and capacity issues at the I-5 ramp intersections with OR Highway 214, the developer shall pay to the City a \$5,000 proportionate share mitigation fee towards TSP Projects R8 & R9.
- 14. Mill Creek greenway trail: Pursuant to 3.01.08B & F, the developer shall pay a proportionate share fee-in-lieu for Mill Creek Greenway Trail improvements. The fee amount is \$53,034.75. Payment is due prior to building permit issuance.

#### Utilities

- 15. Street lighting: Pursuant to 3.02.03A, adjacent street lighting for Commerce Way shall comply with City of Woodburn and Portland General Electric (PGE) standards and specifications. The applicant shall either provide documentation to the attention of the Public Works Department indicating that existing illumination complies with the standards or install new lighting to conform. This is due prior to building permit issuance.
- 16. Power line burial: To meet 3.02.04B1, the applicant shall bury the existing overhead power lines along the Commerce Way frontage. This is due prior to building permit issuance.
- 17. Underground utilities: Pursuant to 3.02.04, all utility services to and within the development shall be underground.

#### Other

18. RCWOD maintenance: Prior to building permit final inspection, the developer shall inspect the extent of the subject properties within the RCWOD, submit a report on existing conditions within this area to the Community Development Department, and remove any invasive plants. Such maintenance work shall be in compliance with applicable outside agency regulations and permitting requirements (e.g. Department of Environmental Quality, Department of State Lands, Army Corps of Engineers).

- 19. Parking: The developer shall complete the following prior to building permit issuance:
  - a. To meet 3.05.02J, revise site plans to illustrate striped directional markings throughout the parking lot and circulation area.
  - b. To meet 3.05.03H2 & 3, revise plans to include signage and striping details for carpool / vanpool parking stalls.
  - c. To meet 3.05.0312-4, revise plans to include electric vehicle parking stall details for charging level, striping, and signage.
  - d. To meet 3.05.06C2 & 3, revise plans to include facility and dimension details for bicycle parking stalls.

#### Notes to the Applicant

The following are not planning / land use / zoning conditions of approval, but are notes for the applicant to be aware of and follow:

- Permits: Permits are applied for using the <u>Oregon ePermitting</u> online permit system. The City Building Division administers building and mechanical permits; Marion County Public Works administers plumbing and electrical permits.
- 2. Records: Staff recommends that the applicant retain a copy of the subject approval.
- 3. Fences, fencing, & free-standing walls: The approval excludes any new fences, fencing, & free-standing walls, which are subject to WDO 2.06 and the permit process of 5.01.03.
- 4. Signage: The approval excludes any signage, which is subject to WDO 3.10 and the permit process of 5.01.10.
- 5. Other Agencies: The applicant, not the City, is responsible for obtaining permits from any county, state and/or federal agencies, which may require approval or permit, and must obtain all applicable City and County permits for work prior to the start of work and that the work meets the satisfaction of the permit-issuing jurisdiction. The Oregon Department of Transportation (ODOT) might require highway access, storm drainage, and other right-of-way (ROW) permits. All work within the public ROW or easements within City jurisdiction must conform to plans approved by the Public Works Department and must comply with a Public Works Right-of-Way permit issued by said department. Marion County plumbing permits must be issued for all waterline, sanitary sewer, and storm sewer work installed beyond the Public Right-of-Way, on private property.
- 6. Inspection: The applicant shall construct, install, or plant all improvements, including landscaping, prior to City staff verification. Contact Planning Division staff at least three (3) City business days prior to a desired date of planning and zoning inspection of site improvements. This is required and separate from and in addition to the usual building code and fire and life safety inspections. Note that Planning staff are not primarily inspectors, do

- not have the nearly immediate availability of building inspectors, and are not bound by any building inspector's schedule or general contractor convenience.
- 7. Stormwater management: The storm sewer system and any required on-site detention for the development must comply with the City Storm Water Management Plan, Oregon Department of Transportation (ODOT), Public Works storm water practices and the Storm Drainage Master Plan. The applicant shall provide a final hydraulic analysis for the development and collection system, including the downstream capacity of the proposed storm sewer system. All required on-site detention area for the runoff from this site will need to be provided in accordance with the hydraulic analysis. The detention system is to be maintained by the applicant in perpetuity.
- 8. Public Works Review: Staff performs final review of the civil plans (within City right-of-way jurisdiction) during the building permit stage. Public infrastructure must be constructed in accordance with plans approved by the City, ODOT, as well as current Public Works construction specifications, Standard Drawings, Standard Details, and General Conditions. All improvements/work within the right-of-way shall be completed prior to final building inspection.
- 9. ODOT review: Applicant is required to obtain a permit from ODOT for all work within ODOT jurisdiction. Applicant to provide a copy of the ODOT permit approval prior to building permit issuance.
- 10. Railroad coordination: Applicant to coordinate work with the appropriate railroad company for all work within or adjacent to their right-of-way.
- 11. Franchises: The applicant provides for the installation of all existing and new franchised utilities and any required easements.
- 12. Water: All water mains and appurtenances must comply with Public Works, Building Division, and Woodburn Fire District requirements. Existing water services lines that are not going to be use with this new development must be abandoned at the main line. The City performs required abandonment of existing water facilities at the water main with payment by the property owner. All taps to existing water mains must be done by a "Hot Tap" method and by approved City of Woodburn Contractors. The applicant shall install the proper type of backflow preventer for all domestic, lawn irrigation and fire sprinkler services. The backflow devices and meters shall be located near the city water main within an easement, unless approved otherwise by Public Works. Contact Byron Brooks, City of Woodburn Water Superintendent, for proper type and installation requirements of the backflow device at (503) 982-5380.
- 13. Grease Interceptor/Trap: If applicable, a grease trap would need to be installed on the sanitary service, either as a central unit or in the communal kitchen/food preparation area.

Contact Marion County Plumbing Department for permit and installation requirements, (503) 588-5147.

- 14. Fire: Fire protection requirements must comply with the Woodburn Fire District standards and requirements. Place fire hydrants within the public ROW or public utility easement and construct them in accordance with Public Works Department requirements, specifications, standards, and permit requirements. Fire protection access, fire hydrant locations and fire protection issues must comply with current fire codes and Woodburn Fire District standards. See City of Woodburn Standard Detail No. 5070-2 Fire Vault. The fire vault must be placed within the public right-of-way or public utility easement.
- 15. SDCs: The developer pays System Development Charges prior to building permit issuance.

#### **Appeals**

Per WDO 4.01.11E, the decision is final unless appealed pursuant to Oregon Revised Statutes (ORS), state administrative rules, and WDO  $\underline{4.02.01}$ . The appeal to City Council due date is twelve (12) days from the mailing date of this final decision notice per 4.02.01B1. A valid appeal must meet the requirements of 4.02.01.

A copy of the decision is available for inspection at no cost, and the City would provide a copy at reasonable cost at the Community Development Department, City Hall, 270 Montgomery Street, Woodburn, OR 97071. For questions or additional information, contact the Planning Division at (503) 982-5246 or <a href="mailto:planning@ci.woodburn.or.us">planning@ci.woodburn.or.us</a>.

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Dan Handel, AICP, Planner

10/19/2023

Affirmed,

Lisa Ellsworth, Chair, Planning Commission

10/18/2023

Date

#### Attachments:

- 1. Public Works Conditions October 5, 2023 (Staff Report Attachment 102)
- 2. Approved site plans (Staff Report Attachment 107)



Public Works Conditions of Approval DR 23-03, PLA 23-03, SA 23-02, & VAR 23-05 WB Commerce 100 LLC & 5000 LLC (1414 Commerce Way) October 5, 2023

#### A. CONDITIONS OF LAND USE APPROVAL:

- The Applicant, not the City, is responsible for obtaining any necessary permits from the State, Marion County, Oregon Division of State Lands, US Army Corps of Engineering, Union Pacific Railroad, and/or federal agencies that may require such permit or approval for the construction of this development.
- 2. The applicant, not the City, is responsible for obtaining any necessary permits from adjacent property owners that may require such permits or approval for work within their property boundaries.
- Applicant to provide a copy of approved permit(s) from the Oregon Division of State Lands and US Army Corps of Engineering, as applicable prior to civil plans approval, if a permit shall be obtained for discharging storm drainage into state lands.
- 4. Applicant to provide a final Engineer stamped storm drainage hydraulic analysis report for detention, conveyance system and a final 100-year floodway, floodplain, and wetland delineation for this development. The storm drainage hydraulic analysis shall comply with, Oregon Division of State Lands, US Army Corps of Engineering and City's requirements, as applicable.
- 5. The applicant is responsible for obtaining approval from the City's Planning Division and Woodburn Fire District for dead-end turnarounds requirements for public streets and private share access.
- 6. Department of Environmental Quality Erosion Control 1200C permit will need to be obtained for this development prior to City issuing approval of civil plans.
- 7. Applicant to install street lighting along Commerce Way. Streetlights shall be in accordance with street lighting plans approved by the City and conforming to Portland General Electric installation (PGE) and under PGE's option B.
- Applicant to provide for the installation of all franchise utilities and shall provide any required easements for these facilities. All permanent utility services to the development shall be underground.
- 9. The Applicant, by this Development, shall not cause storm water runoff to be impounded on adjacent properties. Applicant to construct private storm sewer systems, including detention facilities in accordance with approved plans and drainage reports. All required on-site and off-site detention area(s) for the runoff from this site will need to be provided

- in accordance with the hydraulic analysis. The property owner shall maintain all on-site detention areas in perpetuity.
- 10. All sewer mains are a gravity system and the termini of sewer lines locations, depths, and sizes shall be such that it is suited for future extensions to adjoining areas.
- 11. All sanitary sewer and storm drainage laterals serving the proposed developments are private up to the main public line.
- 12. All City-maintained facilities located on private property shall require a minimum of 16-foot-wide utility easement conveyed to the City by the property owner. This is the applicant's responsibility to provide, not the City's. Utilities of unusual depth, size or location may require a larger width.
- 13. Applicant to provide a flexible pavement structure designed for all new public streets, by a registered professional engineer using subgrade reaction appropriate for the site, traffic index, and a 20-year design life for pavement system. Structure thicknesses shall not be less than values form table on City of Woodburn Standard Detail No. 42001 (Typical Pavement Structure).
- 14. The owner/applicant shall be required to enter into an improvement agreement.
- 15. Applicant to pay all public improvements (right-of-way) fees for all public improvements that are to be maintained by the City as per Ordinance #1795.
- 16. Final review of the Civil Plans will be done during the permit application for public improvements. Public infrastructure will be designed and constructed in accordance with plans approved by Public Works and complying with City, State and Federal requirements/guidelines current at the time of the development application. All public infrastructure improvements shall be completed, inspected, and accepted prior to building permit issuance.
- 17. Provide and record the required right-of-way dedications and public utility easements, prior to City issuance of building permit.
- 18. All public improvements shall be deemed complete prior to City issuance of building permit.
- 19. System Development charges shall be paid prior to building permit issuance.
- 20. All onsite private storm systems and sewer lateral lines shall comply with Marion County plumbing permit and requirements.
- 21. Fire hydrants locations and fire protection requirements shall be as per the Woodburn Fire Districts and City of Woodburn requirements. Actual fire hydrant locations and in-line valving locations shall be determined during the final Civil Plans approval and building permit issuance.






# SITE PLAN REVIEW SUBMISSION

## WB COMMERCE 100 LLC AND WB COMMERCE 5000 LLC COBALT COMMERCE INDUSTRIAL PARK

WOODBURN, MARION COUNTY, OREGON

AUGUST 2023

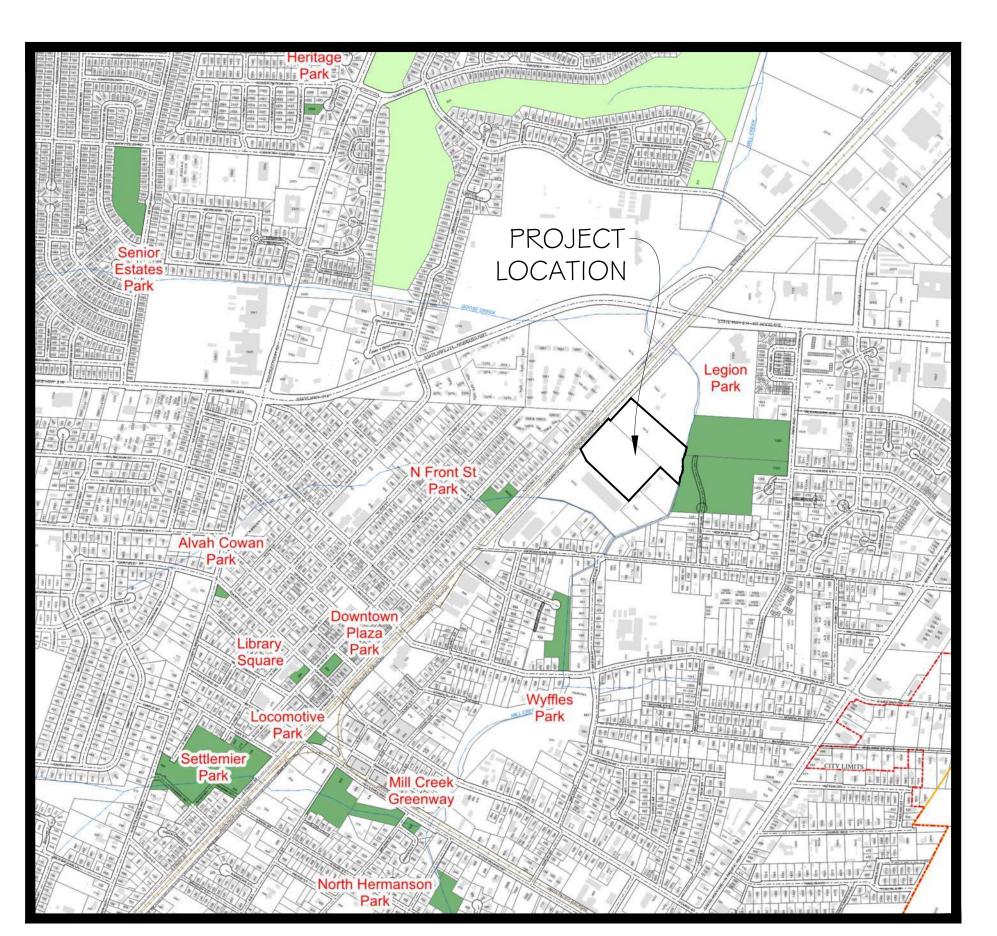

TAXLOT 051W08CB 4900	TAXLOT 051W08CB 04800
TAXLOT 100 PROPOSED BUILDING #1 65,004 9Q, FT BUILDING  TAXLOT 100 PROPOSED BUILDING #2 89,123 5Q, FT BUILDING  TAXLOT 100 PROPOSED BUILDING #2 89,123 5Q, FT BUILDING	TAXLOT O5 I WO7DD O0100  TAXLOT O5 I WO7DD O0200
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SHEET INDEX			
SHEET NUMBER	SHEET TITLE		
C-0.01	COVER SHEET		
C-0.03	CIVIL NOTES AND LEGEND		
C-1.01	EXISTING CONDITIONS AND DEMOLITION PLAN		
C-1.03	EXISTING PARCEL CONFIGURATION AND EASEMENT PLAN		
C-1.05	PROPOSED PARCEL CONFIGURATION AND EASEMENT PLAN		
C-1.07	SITE PLAN		
C-1.09	FIRE ACCESS PLAN		
C-1.11	GRADING AND DRAINAGE PLAN		
C-1.13	OVERALL UTILITY PLAN		
E-1.01	PHOTOMETRIC PLAN		
LI.I	PLANTING KEY PLAN AND SCHEDULE		
LI.2	PLANTING PLAN		
LI.3	PLANTING PLAN		
LI.4	PLANTING PLAN		

OVERALL VICINITY MAP





#### PROJECT CONTACTS AND INFORMATION

OWNER DEVELOPER: COBALT DEVELOPMENT, LLC 8215 SW TUALATIN-SHERWOOD RD SUITE #200 TUALATIN, OR 97062 971-252-2370 CONNECT@COBALTBUILT.COM

DESIGN ENGINEER: PROJECT DELIVERY GROUP, LLC KEITH WHISENHUNT, PE & PLS 7938 CROSBY ROAD NE WOODBURN, OR 9707 I 503-364-4004 (OFFICE) KEITHW@PDGNW.COM

SURVEYOR: PROJECT DELIVERY GROUP, LLC BRYAN WHISENHUNT, PLS 7938 CROSBY ROAD NE WOODBURN, OR 9707 I 503-364-4004 (OFFICE) BRYANW@PDGNW.COM


LOCAL JURISDICTION CITY OF WOODBURN CITY HALL 270 MONTGOMERY STREET WOODBURN, OREGON 97071-4730 (503) 982-5246 PLANNING@CI.WOODBURN.OR.US

LANDSCAPE ARCHITECT LAURUS DESIGNS LLC LAURA A. ANTONSON, RLA, ASLA 1012 PINE ST, SILVERTON, OR 97381 503.784.6494 laura@laurusdesigns.com

PROJECT LOCATION: COMMERCE WAY WOODBURN, MARION COUNTY, LATITUDE = 45° 8'55" NORTH LONGITUDE = 122°50'50" WEST TOWNSHIP: 55 RANGE: IW SECTION: 7 AND 8 QUARTER: SE AND SW TAX LOT: 05 | WO8CB 05000 AND 051W07DA 00100

#### ATTENTION EXCAVATORS

OREGON LAW REQUIRES YOU TO FOLLOW RULES ADOPTED BY THE OREGON UTILITY NOTIFICATION CENTER. THOSE RULES ARE SET FORTH IN OAR 952-001-0010 THROUGH OAR 952-001-0090. YOU MAY OBTAIN COPIES OF THESE RULES FROM THE CENTER BY CALLING 503-232-1987. IF YOU HAVE ANY QUESTIONS ABOUT THE RULES, YOU MAY CONTACT THE CENTER. YOU MUST NOTIFY THE CENTER AT LEAST TWO BUSINESS DAYS BEFORE COMMENCING AN EXCAVATION. CALL 503-246-6699.

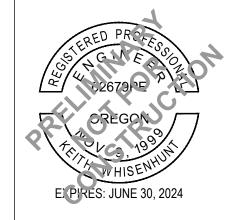

COVER SHEET

C-0.01

ATTENTION:

Know what's **below**. Call before you dig.

OREGON LAW REQUIRES YOU TO FOLLOW RULES ADOPTED BY THE OREGON UTILITY NOTIFICATION CENTER. THOSE RULES ARE SET FORTH IN OAR 952-001-0010 THROUGH 952-001-0090. YOU MAY OBTAIN COPIES OF THE RULES BY CALLING THE CENTER AT (503) 232-1987.

#### GENERAL NOTES

- I. ALL WORK SHALL CONFORM TO THE CURRENT STANDARD SPECIFICATIONS AND REQUIREMENTS OF THE AUTHORITIES HAVING JURISDICTION AND THE CURRENT AMERICAN PUBLIC WORKS ASSOCIATION STANDARDS FOR PUBLIC WORKS CONSTRUCTION.
- 2. THE SURVEY INFORMATION SHOWN AS A BACKGROUND SCREEN IS BASED ON A SURVEY BY OTHERS AND IS SHOWN FOR REFERENCE ONLY. CONTRACTOR TO VERIFY ALL EXISTING CONDITIONS WITH ITS OWN RESOURCES PRIOR TO START OF ANY CONSTRUCTION.
- 3. CONTRACTOR MUST COMPLY WITH LOCAL AND STATE REQUIREMENTS TO NOTIFY ALL UTILITY COMPANIES FOR LINE LOCATIONS SEVENTY-TWO (72) HOURS (MINIMUM) PRIOR TO START OF WORK. DAMAGE TO UTILITIES SHALL BE CORRECTED AT THE CONTRACTOR'S EXPENSE.
- 4.CONTRACTOR SHALL ADJUST ALL STRUCTURES IMPACTED BY CONSTRUCTIONS IMPROVEMENTS TO NEW FINISH GRADES.
- 5.REQUEST BY THE CONTRACTOR FOR CHANGES TO THE PLANS MUST BE APPROVED BY THE ENGINEER.
- 6.ALL WORK WITHIN THE PUBLIC RIGHT-OF-WAY REQUIRES A PUBLIC WORKS PERMIT
- TO REQUESTING AGENCY SIGN OFF ON PERMITS FOR OCCUPANCY.

7.CONTRACTOR SHALL PROVIDE THE ENGINEER OF RECORD WITH AS-BUILT PLANS AT LEAST 2 WEEKS PRIOR

8.CONTRACTOR SHALL PERFORM ALL THE WORK SHOWN ON THE DRAWINGS AND ALL INCIDENTAL WORK NECESSARY TO COMPLETE THE PROJECT.

#### DEMOLITION NOTES

- I. INSTALL EROSION CONTROL MEASURES AND TEMPORARY FENCING PRIOR TO ANY DEMOLITION ACTIVITIES. 2.DEMOLISH AND REMOVE ALL STRUCTURES AND ASSOCIATED FEATURES (APPURTENANCES), AS SHOWN. 3.DEMOLISH ALL PAVED AREAS ON SITE AS SHOWN, DOWN TO NATIVE SUBGRADE.
- 4.ALL VEGETATION AND DELETERIOUS MATERIALS WITHIN THE LIMITS OF WORK SHALL BE STRIPPED AND REMOVED FROM THE SITE PRIOR TO GRADING WORK, UNLESS NOTED OTHERWISE (E.G. PROTECTED
- 5. PROTECT ALL EXISTING LANDSCAPING AT AND BEYOND LIMITS OF WORK.
- 6.PROTECT ALL UNDERGROUND UTILITY SERVICES AND CONDUIT UNLESS NOTED OTHERWISE.
- 7. WHERE APPLICABLE, VERIFY DISCONNECT OF GAS AND ELECTRIC WITH UTILITY. CUT/CAP UTILITY SERVICES (STORMWATER AND SANITARY WITHIN 5 FEET OF EDGE OF R.O.W.) CAP WATERLINE ON OWNER'S SIDE OF METER AND PERFORM OTHER DEMOLITION TASKS AS REQUIRED. ADDITIONAL REMOVALS MAY BE REQUIRED BY THE AUTHORITIES HAVING JURISDICTION AND THE CONTRACTOR SHALL CONFIRM ACCORDINGLY PRIOR TO BID.

#### GRADING NOTES

ROW

- I. ROUGH GRADING: ROUGH GRADE TO ALLOW FOR DEPTH OF BUILDING SLABS, PAVEMENTS, BASE COURSES, AND TOPSOIL PER DETAILS AND SPECIFICATIONS.
- 2.FINISH GRADING: BRING ALL FINISH GRADES TO APPROXIMATE LEVELS INDICATED. WHERE GRADES ARE NOT OTHERWISE INDICATED, HARDSCAPE FINISH GRADES ARE TO BE THE SAME AS ADJACENT SIDEWALKS, CURBS, OR THE OBVIOUS GRADE OF ADJACENT STRUCTURE SOFTSCAPE GRADES (INCLUDING ADDITIONAL DEPTH OF TOPSOIL) SHALL BE SET 6 INCHES BELOW BUILDING FINISHED FLOORS WHERE ABUTTING BUILDINGS, I-2 INCHES WHERE ABUTTING WALKWAYS OR CURBS, OR MATCHING OTHER SOFTSCAPE GRADES. GRADE TO UNIFORM LEVELS OR SLOPES BETWEEN POINTS WHERE GRADES ARE GIVEN ROUND OFF SURFACES, AVOID ABRUPT CHANGES IN LEVELS. AT COMPLETION OF JOB AND AFTER BACKFILLING BY OTHER TRADES HAS BEEN COMPLETED, REFILL AND COMPACT AREAS WHICH HAVE SETTLED OR ERODED TO BRING TO FINAL GRADES.
- 3.EXCAVATION: EXCAVATE FOR SLABS, PAVING, AND OTHER IMPROVEMENTS TO SIZES AND LEVELS SHOWN OR REQUIRED. ALLOW FOR FORM CLEARANCE AND FOR PROPER COMPACTION OF REQUIRED BACKFILLING MATERIAL. DAMAGE TO UTILITIES SHALL BE CORRECTED AT THE CONTRACTOR'S EXPENSE.
- 4.EFFECTIVE EROSION PREVENTION AND SEDIMENT CONTROL IS REQUIRED. EROSION CONTROL DEVICES MUST BE INSTALLED AND MAINTAINED MEETING THE LOCAL AGENCY AND STATE AGENCY REQUIREMENTS. THE AUTHORITIES HAVING JURISDICTION MAY, AT ANY TIME ORDER CORRECTIVE ACTION AND STOPPAGE OF WORK TO ACCOMPLISH EFFECTIVE EROSION CONTROL.
- 5. DRAINAGE SHALL BE CONTROLLED WITHIN THE WORK SITE AND SHALL BE ROUTED SO THAT ADJACENT PRIVATE PROPERTY, PUBLIC PROPERTY, AND THE RECEIVING SYSTEM ARE NOT ADVERSELY IMPACTED. THE ENGINEER AND/OR AUTHORITIES HAVING JURISDICTION MAY, AT ANY TIME ORDER CORRECTIVE ACTION AND STOPPAGE OF WORK TO ACCOMPLISH EFFECTIVE DRAINAGE CONTROL.
- 6.SITE TOPSOIL STOCKPILED DURING CONSTRUCTIONS AND USED FOR LANDSCAPING SHALL BE APPROVED BY THE LANDSCAPE ARCHITECT.
- 7.CONTRACTOR TO REVIEW AND CONFIRM GRADES AT JOIN POINTS, SUCH AS AT DAYLIGHT LIMITS AND BUILDING ENTRANCES, PRIOR TO CONSTRUCTION.
- 8.ACCESSIBLE PARKING SPACES AND LOADING ZONES SHALL BE CONSTRUCTED AT 2% MAXIMUM SLOPE IN ALL DIRECTIONS. 9.PEDESTRIAN SIDEWALK CONNECTIONS BETWEEN PUBLIC R.O.W. SHALL BE CONSTRUCTED AT AND 2%

MAXIMUM CROSS SLOPE AND 5% MAXIMUM LONGITUDINAL SLOPE (8.33% FOR DESIGNATED RAMPS)

- 45.25' R.O.W.

STREET

- WATER

MAIN

STORM ~

MAIN

SANITARY MAIN

STREET EXCEPTION REQUEST FOR

COMMERCE WAY TYPICAL SECTION

#### SITE WORK NOTES

- I. ALL CURB RADII TO BE 3 FEET UNLESS NOTED OTHERWISE.
- 2.STAIR RISERS AND TREADS SHALL BE CONFORMANT WITH THE REQUIREMENTS OF THE AUTHORITIES HAVING JURISDICTION AND THE CURRENT EDITION OF THE STATE BUILDING CODE (E.G. OSCC).
- 3. WHEREVER A PEDESTRIAN WALKING PATH IS WITHIN 36 INCHES OF A VERTICAL DROP OF 30 INCHES OR GREATER, GUARDRAIL SHALL BE INSTALLED CONFORMANT WITH THE REQUIREMENTS OF THE AUTHORITIES HAVING JURISDICTION AND THE CURRENT EDITION OF THE STATE BUILDING CODE (E.G. INTERNATIONAL BUILDING CODE, CHAPTER 10, SECTION 1015).

#### UTILITY NOTES

- I. ALL WORK SHALL CONFORM TO THE CURRENT EDITIONS OF THE STATE PLUMBING AND BUILDING CODES WITH LOCAL AMENDMENTS AS APPLICABLE ALONG WITH ANY ADDITIONAL REQUIREMENTS OF THE AUTHORITIES HAVING JURISDICTION.
- 2. THE WORKING DRAWINGS ARE GENERALLY DIAGRAMMATIC. THEY DO NOT SHOW EVERY OFFSET, BEND OR ELBOW REQUIRED FOR INSTALLATION IN THE SPACE PROVIDED. THEY DO NOT SHOW EVERY DIMENSION, COMPONENT PIECE, SECTION, JOINT OR FITTING REQUIRED TO COMPLETE THE PROJECT. ALL LOCATIONS FOR WORK SHALL BE CHECKED AND COORDINATED WITH EXISTING CONDITIONS IN THE FIELD BEFORE BEGINNING CONSTRUCTION. EXISTING UNDERGROUND UTILITIES WITHIN THE LIMITS OF EXCAVATION SHALL BE VERIFIED AS TO CONDITION, SIZE AND LOCATION BY UNCOVERING (POTHOLING), PROVIDING SUCH IS PERMITTED BY THE AUTHORITIES HAVING JURISDICTION, BEFORE BEGINNING CONSTRUCTION. CONTRACTOR TO NOTIFY ENGINEER IF THERE ARE ANY DISCREPANCIES.
- 3.NOT ALL REQUIRED CLEANOUTS ARE SHOWN ON THE PLANS. PROVIDE CLEANOUTS AS REQUIRED BY THE AUTHORITIES HAVING JURISDICTION AND THE CURRENT EDITION OF THE STATE PLUMBING CODE (E. G. UNIFORM PLUMBING CODE CHAPTER 7, SECTIONS 707 AND 719, AND CHAPTER 11, SECTION 1101.13).
- 4.ALL SANITARY AND STORM PIPING IS DESIGNED USING CONCENTRIC PIPE TO PIPE AND WYE FITTINGS, UNLESS OTHERWISE NOTED.
- 5.ALL DOWNSPOUT LEADERS TO BE 6 INCHES AT 2.0% MINIMUM UNLESS NOTED OTHERWISE
- 6.IF APPLICABLE, PROVIDE 2 INCH PVC DRAIN LINE FROM DOMESTIC WATER METER VAULT AND BACKFLOW PREVENTER VAULT TO THE DOUBLE DETECTOR CHECK VALVE (FIRE) VAULT. PROVIDE 1.3 HP SUMP PUMP AT BASE OF FIRE VAULT AND INSTALL 2 INCH PVC DRAIN LINE WITH BACKFLOW VALVE FROM SUMP PUMP TO DAYLIGHT AT NEAREST CURB. FURNISH 3/4 INCH DIAMETER CONDUIT FROM BUILDING ELECTRICAL ROOM TO FIRE VAULT FOR SUMP PUMP ELECTRICAL SERVICE NOTE: COORDINATE WITH FIRE PROTECTION CONTRACTOR FOR FLOW SENSOR INSTALLATION AND CONDUIT REQUIREMENTS.
- 7.IF APPLICABLE, CONTRACTOR TO PROVIDE POWER TO IRRIGATION CONTROLLER. SEE LANDSCAPE PLANS AND SPECIFICATIONS.
- 8.SEE BUILDING PLUMBING DRAWINGS FOR PIPING WITHIN THE BUILDING AND UP TO 5 FEET OUTSIDE THE BUILDING, INCLUDING ANY FOUNDATION DRAINAGE PIPING.
- 9.CONTRACTOR TO MAINTAIN MINIMUM 3 FEET OF COVER OVER ALL UTILITY PIPING AND CONDUITS, UNLESS NOTED OTHERWISE.
- IO. WHERE CONNECTING TO AN EXISTING PIPE, AND PRIOR TO ORDERING MATERIALS, THE CONTRACTOR SHALL EXPOSE THE END OF THE EXISTING PIPE TO VERIFY THE LOCATION, SIZE, AND ELEVATION. NOTIFY ENGINEER OF ANY DISCREPANCIES.
- I I . CONTRACTORS SHALL SCOPE ALL PRIVATE ONSITE GRAVITY SYSTEM LINES THAT ARE BEING CONNECTED TO FOR PROPOSED SERVICE. SCOPING SHALL OCCUR A MINIMUM OF 72 HOURS PRIOR TO CONSTRUCTION AND THE ENGINEER SHALL BE NOTIFIED IMMEDIATELY OF ANY DISCREPANCIES WITH AS-BUILT RECORDS/SURVEY FINDINGS OR IF THE EXISTING UTILITIES ARE DAMAGED OR SHOW SIGNS OF SIGNIFICANT DETERIORATION. CONTRACTOR SHALL PROVIDE THE ENGINEER WITH VIDEO RECORDS, ALONG WITH A SKETCH IF THE LOCATIONS DIFFER FROM AS-BUILT PLANS OR SURVEY FINDINGS.
- I 2. PRODUCT MATERIAL SUBMITTALS FOR REVIEW BY THE ENGINEER SHALL BE ACCOMPANIED BY A MANUFACTURE'S CERTIFICATION THAT THE PRODUCT IS CAPABLE OF MEETING PERFORMANCE EXPECTATIONS (I.E. WATERTIGHT, MINIMUM/MAXIMUM BURIAL, PREVENTION OF GROUNDWATER INTRUSION, ETC.) BASED ON THEIR REVIEW OF THE PROJECT PLANS. IN THE ABSENCE OF A MANUFACTURE'S CERTIFICATION, THE GENERAL CONTRACTOR'S REVIEW STAMP SHALL CONSTITUTE THAT THEY HAVE PERFORMED THE NECESSARY REVIEW TO CERTIFY THE PRODUCT'S CONFORMANCE TO PROJECT SPECIFICATIONS AND GENERAL EXPECTATIONS.
- 13. PIPE LENGTHS SHOWN ON PLANS ARE TWO DIMENSIONAL AND MEASURED FROM CENTER OF STRUCTURE TO CENTER OF STRUCTURE
- 14. RIM ELEVATIONS SHOWN ON PLANS REFERENCE THE CENTER OF THE STRUCTURE. THE CONTRACTOR SHALL BE RESPONSIBLE FOR RECONCILING LIDS/GRATES ETC. TO THE SLOPES OF THE SITE GRADING.
- 15. MANHOLE OR VAULT RIM ELEVATIONS SHALL BE SET FLUSH IN PAVEMENT AREAS AND 3-4 INCHES ABOVE GRADE IN LANDSCAPE AREAS. RIMS IN PAVEMENT AREAS SHALL BE H-20 TRAFFIC RATED.

PROPOSED

ROW

1.0'-

6.0'

SIDEWALK

- 8.0′ PUE -----


**--** 5.0' <del>--|-</del>

## ABBREVIATIONS

SHTO	AMERICAN ASSOCIATION OF STATE HIGHWAY	MID	MIDPOINT OF CURVE
 АВ	AND TRANSPORATION OFFICIALS  AGGREGATE BASE	MJ	MECHANICAL JOINT
AC	ASPHALT CONCRETE	NO	NUMBER
DA		NTS	NOT TO SCALE
BC	AMERICANS WITH DISABILITIES ACT	ОН	OVERHEAD
BMP	BEGINNING OF CURVE	OSHA	OCCUPATIONAL STATE HEALTH
BO	BEST MANAGEMENT PRACTICE	Р	POWER
VCE	BLOW OFF	PC	POINT OF CURVATURE
	BEGINNING OF VERTICAL CURVE ELEVATION	PED	PEDESTAL
VCS	BEGINNING OF VERTICAL CURVE STATION	POT	POINT OF TANGENCY
3W	BACK OF SIDEWALK	PRC	POINT OF REVERSE CURVE
CB	CATCH BASIN	PSE	PUBLIC SERVICE EASEMENT
CL	CENTER LINE	PT	POINT
CLR	CLEAR	PVI	POINT OF VERTICAL INTERSECT
CO	CLEANOUT	R	RADIUS
DMM	COMMUNICATION	PCWOD	RIPARIAN CORRIDOR AND WET
OW	CITY OF WOODBURN	RCWOD	DISTRICT
DI	DUCTILE IRON	RD	ROOF DRAIN
DS	DOWN SPOUT	RIM	RIM ELEVATION
E	ELECTRIC	ROW	RIGHT OF WAY
EC	EROSION CONTROL	RPP	REDUCED PRESSURE PRINCIPL PREVENTOR
EG	EXISTING GRADE	RR	RAIL ROAD
LEV	ELEVATION	RT	RIGHT
SA	ENDANGERED SPECIES ACT	S	SLOPE, FOOT PER FOOT
VCE	END OF VERTICAL CURVE ELEVATION	SAN	SANITARY
VCS_	END OF VERTICAL CURVE STATION	SD	STORM DRAIN
EX	EXISTING	SDAD	STORM DRAIN AREA DRAIN
DC	FIRE DEPARTMENT CONNECTION	SDCB	STORM DRAIN CATCH BASIN
FF	FINISH FLOOR	SDCO	STORM DRAIN CLEANOUT
FG	FINISHED GRADE	SDCS	STORM DRAIN CONTROL STRU
FH	FIRE HYDRANT	SDMH	STORM DRAIN MANHOLE
FL	FLOW LINE/BOTTOM OF CURB	SF	SQUARE FEET
FR	FIBER ROLL	SIG	SIGNAL
=W	FIRE WATER	55	SANITARY SEWER
GM	GAS METER	SSCO	SANTIARY SEWER CLEANOUT
НВ	HOSE BIB	SSMH	SANITARY SEWER MANHOLE
DPE	HIGH-DENSITY POLYETHYLENE	STA	STATION
NV	INVERT ELEVATION OF PIPE	TBC	TOP BACK OF CURB
RRV	IRRIGATION VALVE	TFC	
JB	JUNCTION BOX	TOW	TOP FACE OF CURB
Κ	CURVE COEFFICIENT	TR	TOP OF WALL
_AT	LATERAL		TRANSFORMER
LT	LEFT	TYP	TYPICAL
.VC	LENGTH OF VERTICAL CURVE	UG	UNDERGROUND
ΜН	MANHOLE	USPS	UNITED STATES POSTAL SERVI
		W	DOMESTIC WATER

NO	NUMBER
NTS	NOT TO SCALE
ОН	OVERHEAD
OSHA	OCCUPATIONAL STATE HEALTH AGENCY
Р	POWER
PC	POINT OF CURVATURE
PED	PEDESTAL
POT	POINT OF TANGENCY
PRC	POINT OF REVERSE CURVE
PSE	PUBLIC SERVICE EASEMENT
PT	POINT
PVI	POINT OF VERTICAL INTERSECTION
R	RADIUS
RCWOD	RIPARIAN CORRIDOR AND WETLAND OVERLAY DISTRICT
RD	ROOF DRAIN
RIM	RIM ELEVATION
ROW	RIGHT OF WAY
RPP	REDUCED PRESSURE PRINCIPLE BACKFLOW PREVENTOR
RR	RAIL ROAD
RT	RIGHT
5	SLOPE, FOOT PER FOOT
SAN	SANITARY
SD	STORM DRAIN
SDAD	STORM DRAIN AREA DRAIN
SDCB	STORM DRAIN CATCH BASIN
SDCO	STORM DRAIN CLEANOUT
SDCS	STORM DRAIN CONTROL STRUCTURE
SDMH	STORM DRAIN MANHOLE
SF	SQUARE FEET
SIG	SIGNAL
55	SANITARY SEWER
55CO	SANTIARY SEWER CLEANOUT
SSMH	SANITARY SEWER MANHOLE
STA	STATION
TBC	TOP BACK OF CURB
TFC	TOP FACE OF CURB
TOW	TOP OF WALL
TR	TRANSFORMER
TYP	TYPICAL
UG	UNDERGROUND
USPS	UNITED STATES POSTAL SERVICE
W	DOMESTIC WATER

## DRAWING LEGENE

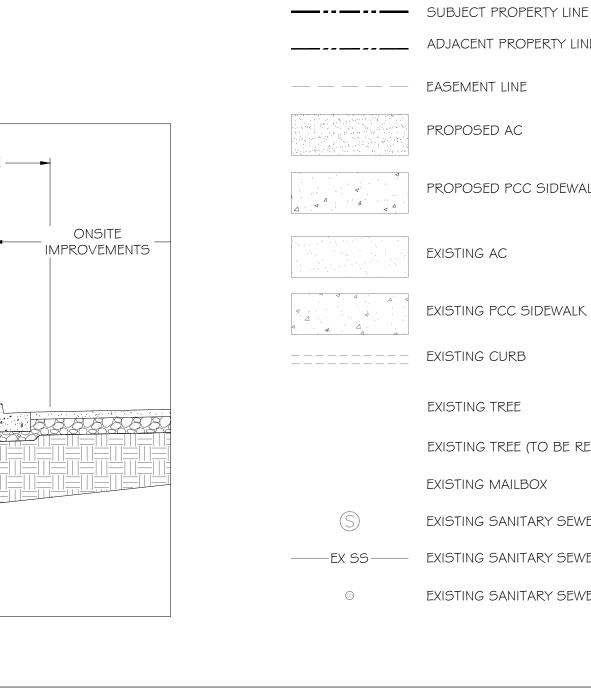

ADJACENT PROPERTY LINE

PROPOSED PCC SIDEWALK

EXISTING PCC SIDEWALK

EXISTING TREE (TO BE REMOVED)

EXISTING SANITARY SEWER MANHOLE

EXISTING SANITARY SEWER CLEANOUT

EXISTING SANITARY SEWER PIPE

PROPOSED AC


EXISTING AC

EXISTING CURB

EXISTING TREE

EXISTING MAILBOX

	EXISTING STORM SEWER MANHOLE
——EX SD——	EXISTING STORM SEWER PIPE
	EXISTING STORM SEWER CATCH BASIN
	PROPOSED STORM AREA DRAIN
	PROPOSED STORM SEWER MANHOLE
——————————————————————————————————————	PROPOSED STORM SEWER PIPE
TR	EXISTING TELEPHONE RISER
P	EXISTING POWER VAULT
EB	EXISTING ELECTRICAL BOX
•	EXISTING POWER POLE
••	EXISTING POWER POLE WITH DROP
	EXISTING GUY ANCHOR
$\Rightarrow$	EXISTING POWER POLE WITH LIGHT
——EX UG E—— ——EX OH E——	EXISTING POWER LINE
——EX GAS——	EXISTING GAS LINE
—EX OH COMM— —EX UG COMM—	EXISTING COMMUNICATION LINE
——EX FO——	EXISTING FIBER OPTIC LINE
——EX TEL——	EXISTING TELEPHONE LINE

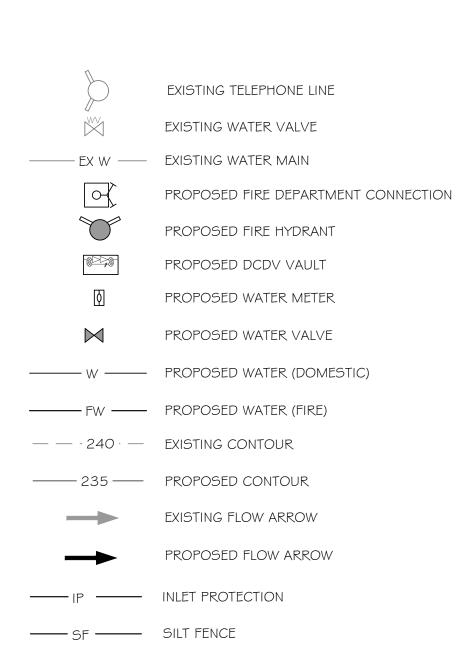

CIVIL ENGINEERS LAND SURVEYORS PROJECT MANAGERS PLANNERS www.pdgnw.com

DATE SIGNED:


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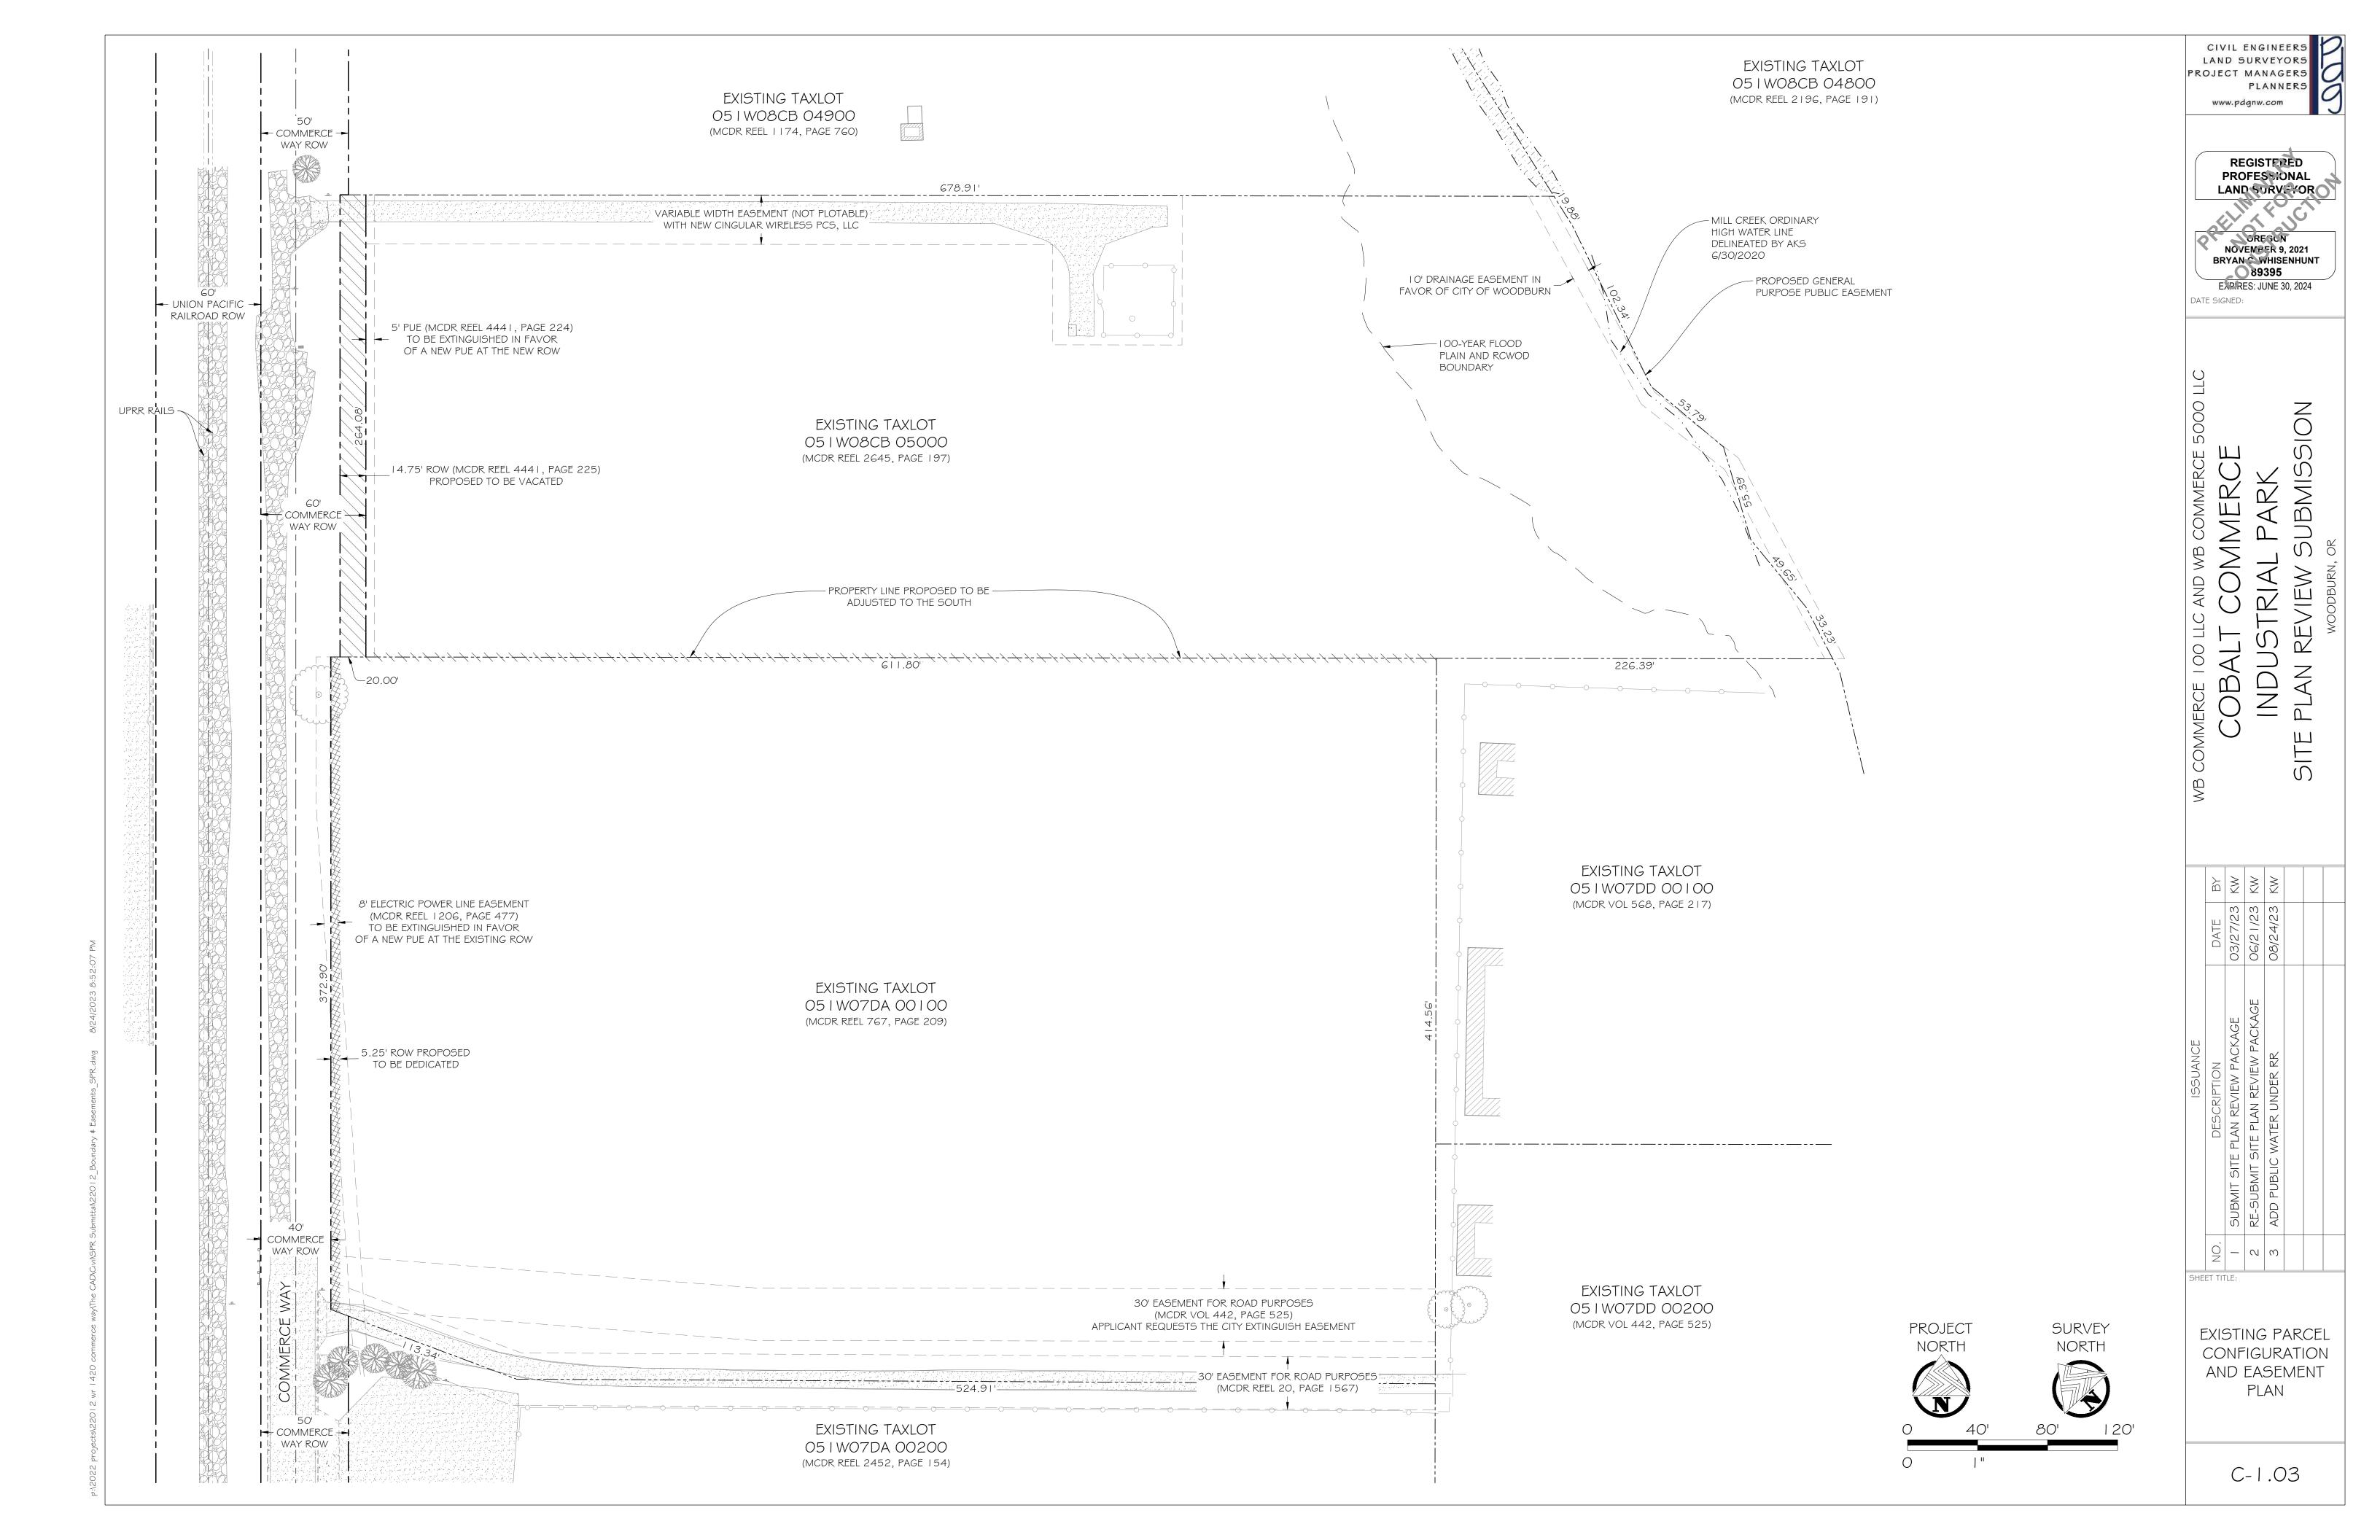
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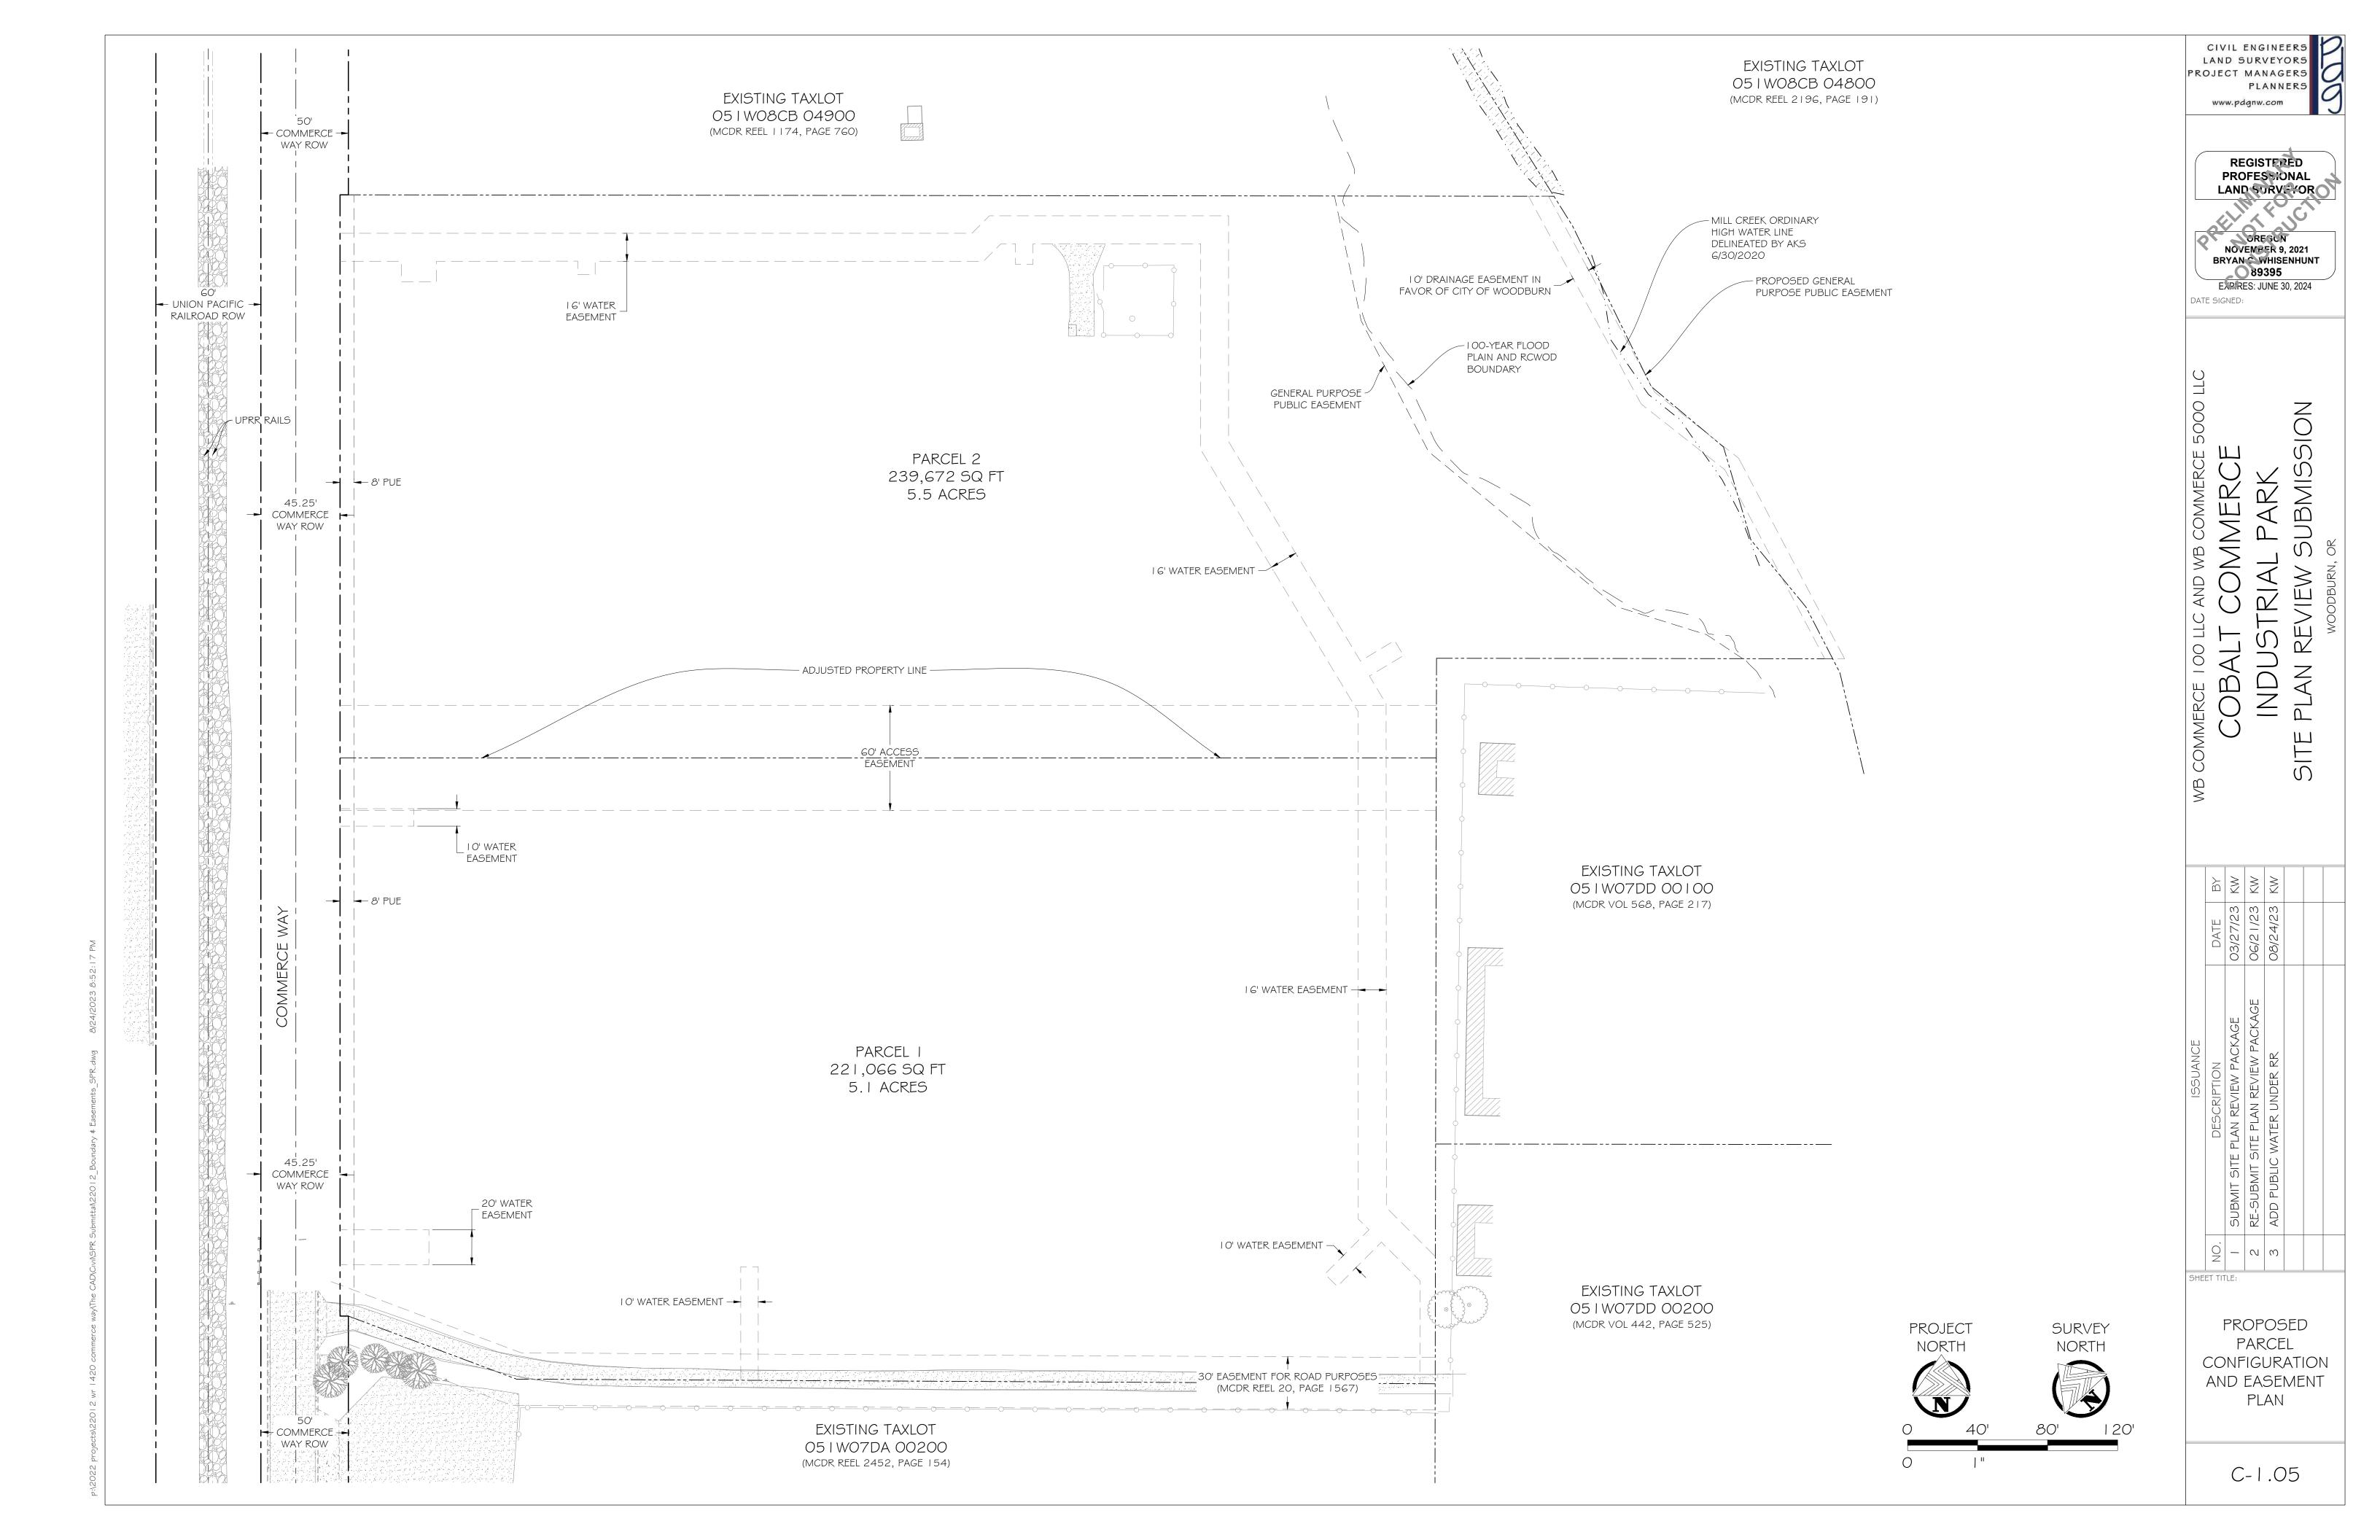
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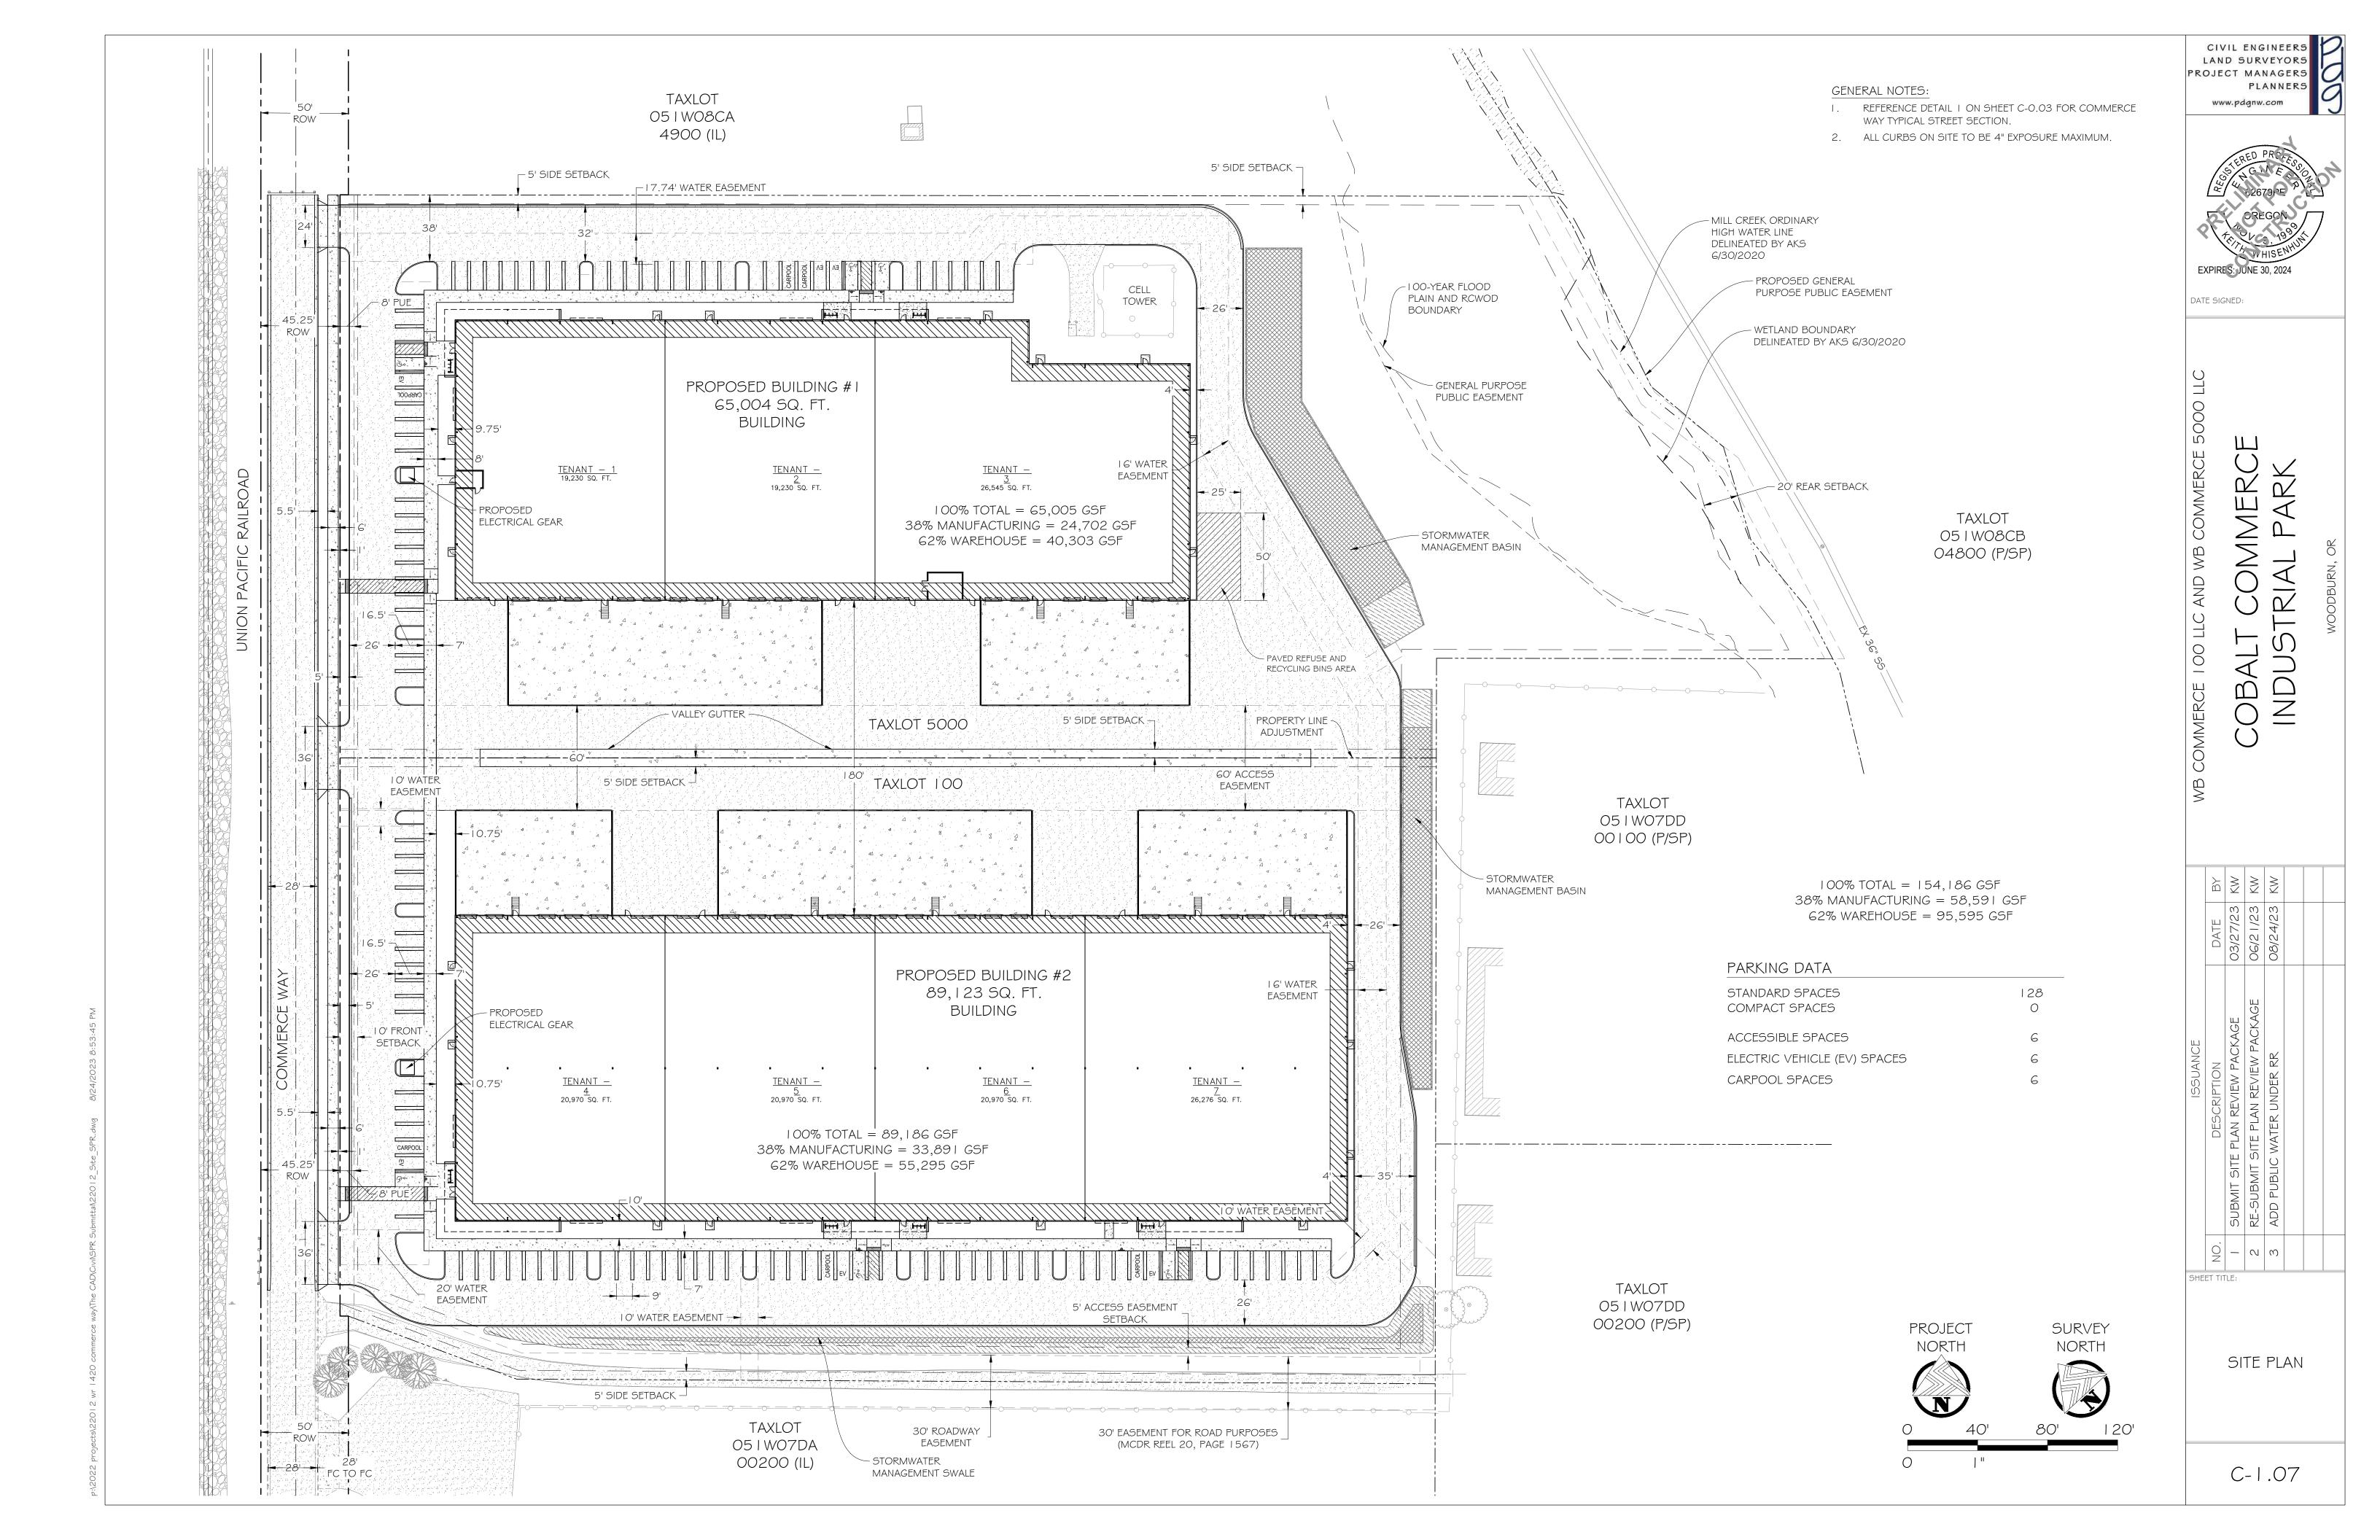
LEGEND


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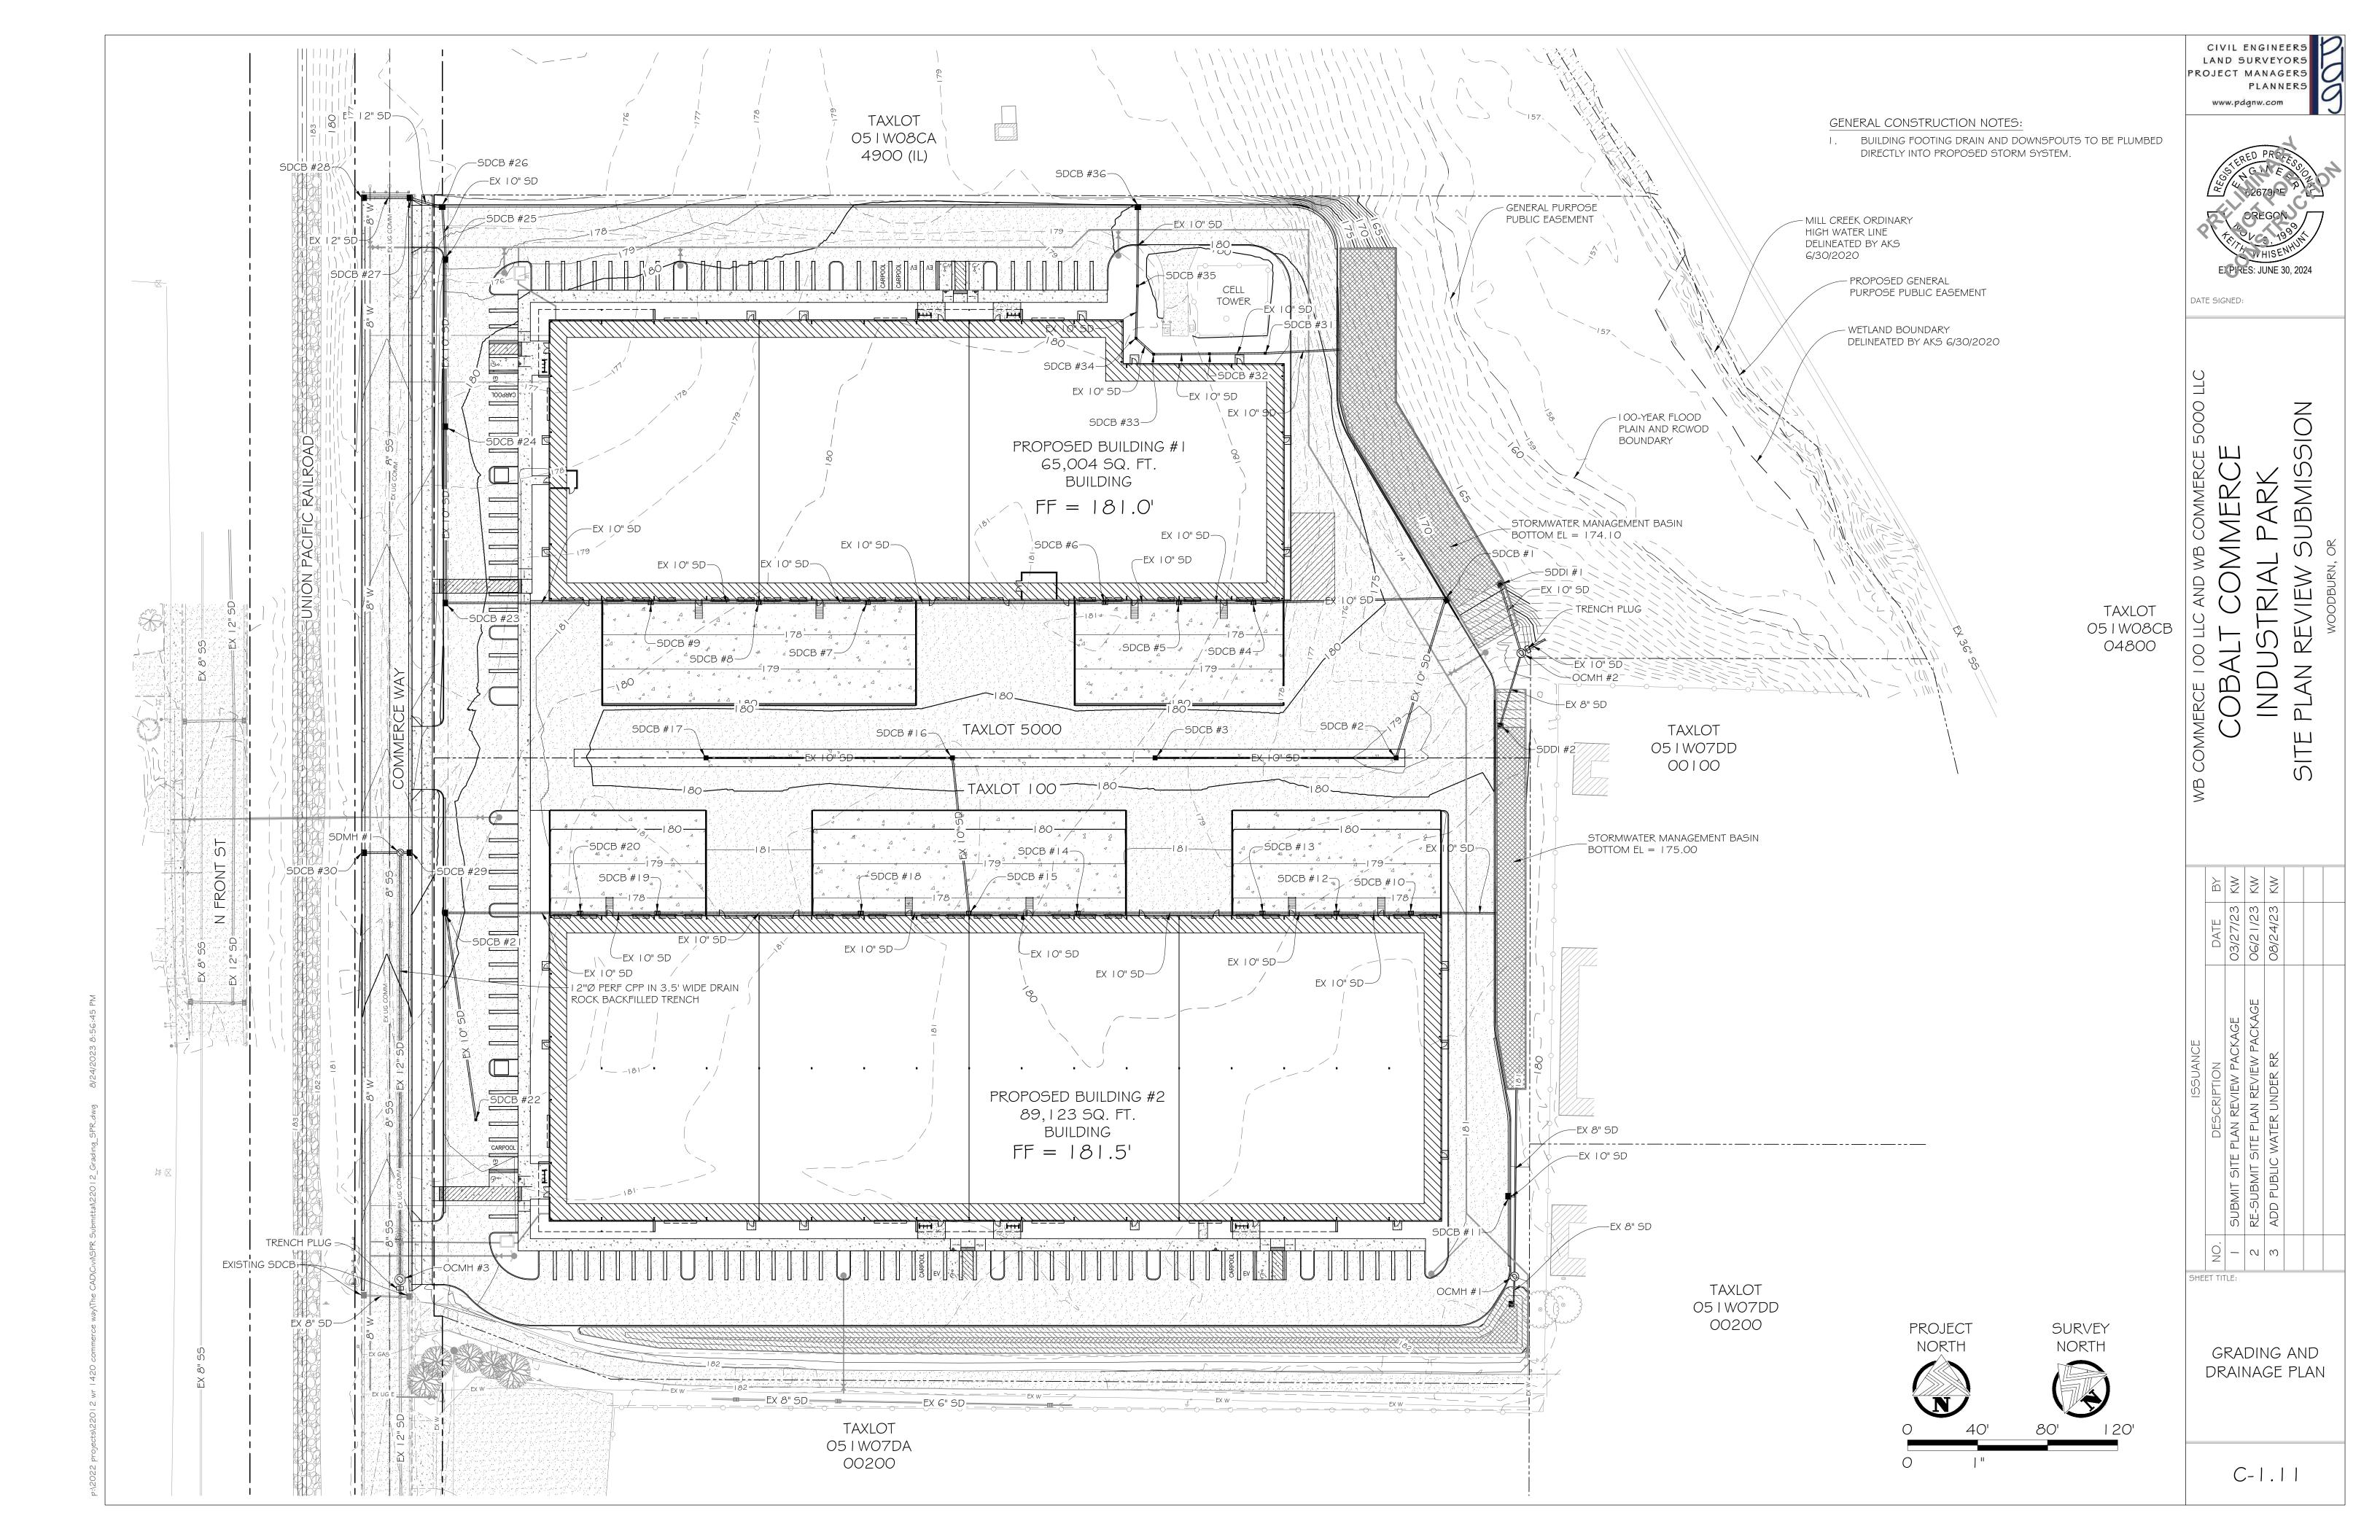










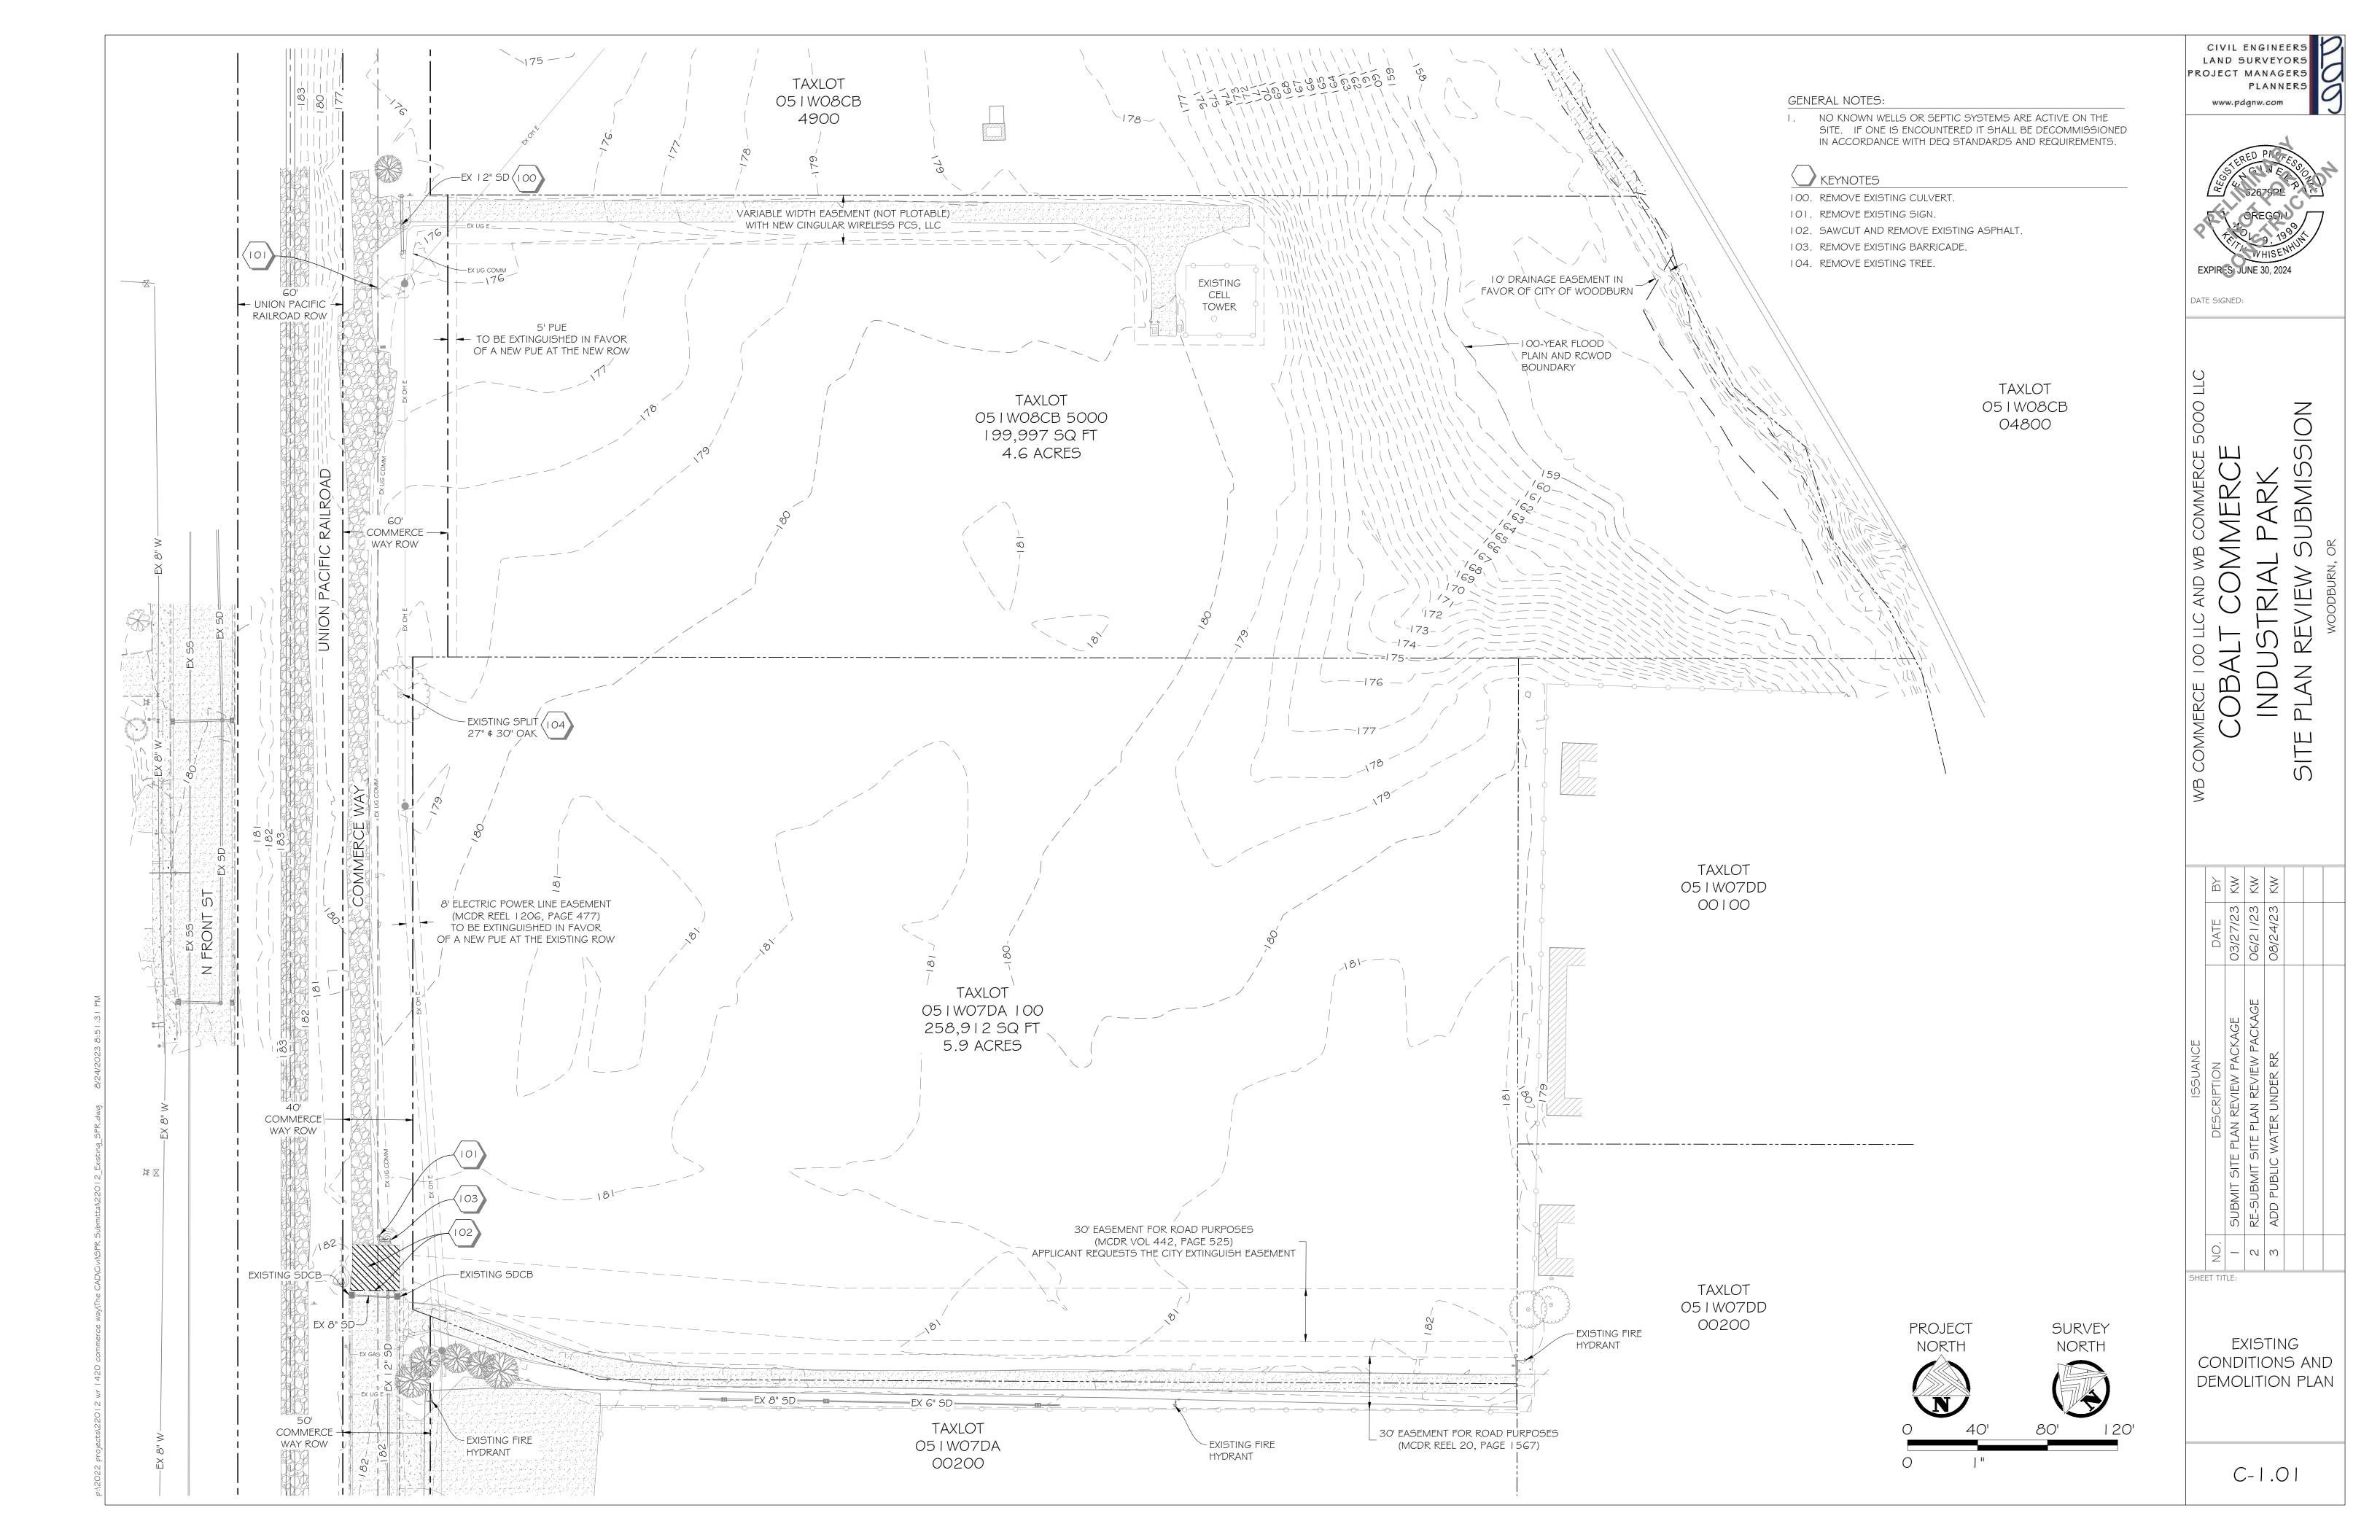


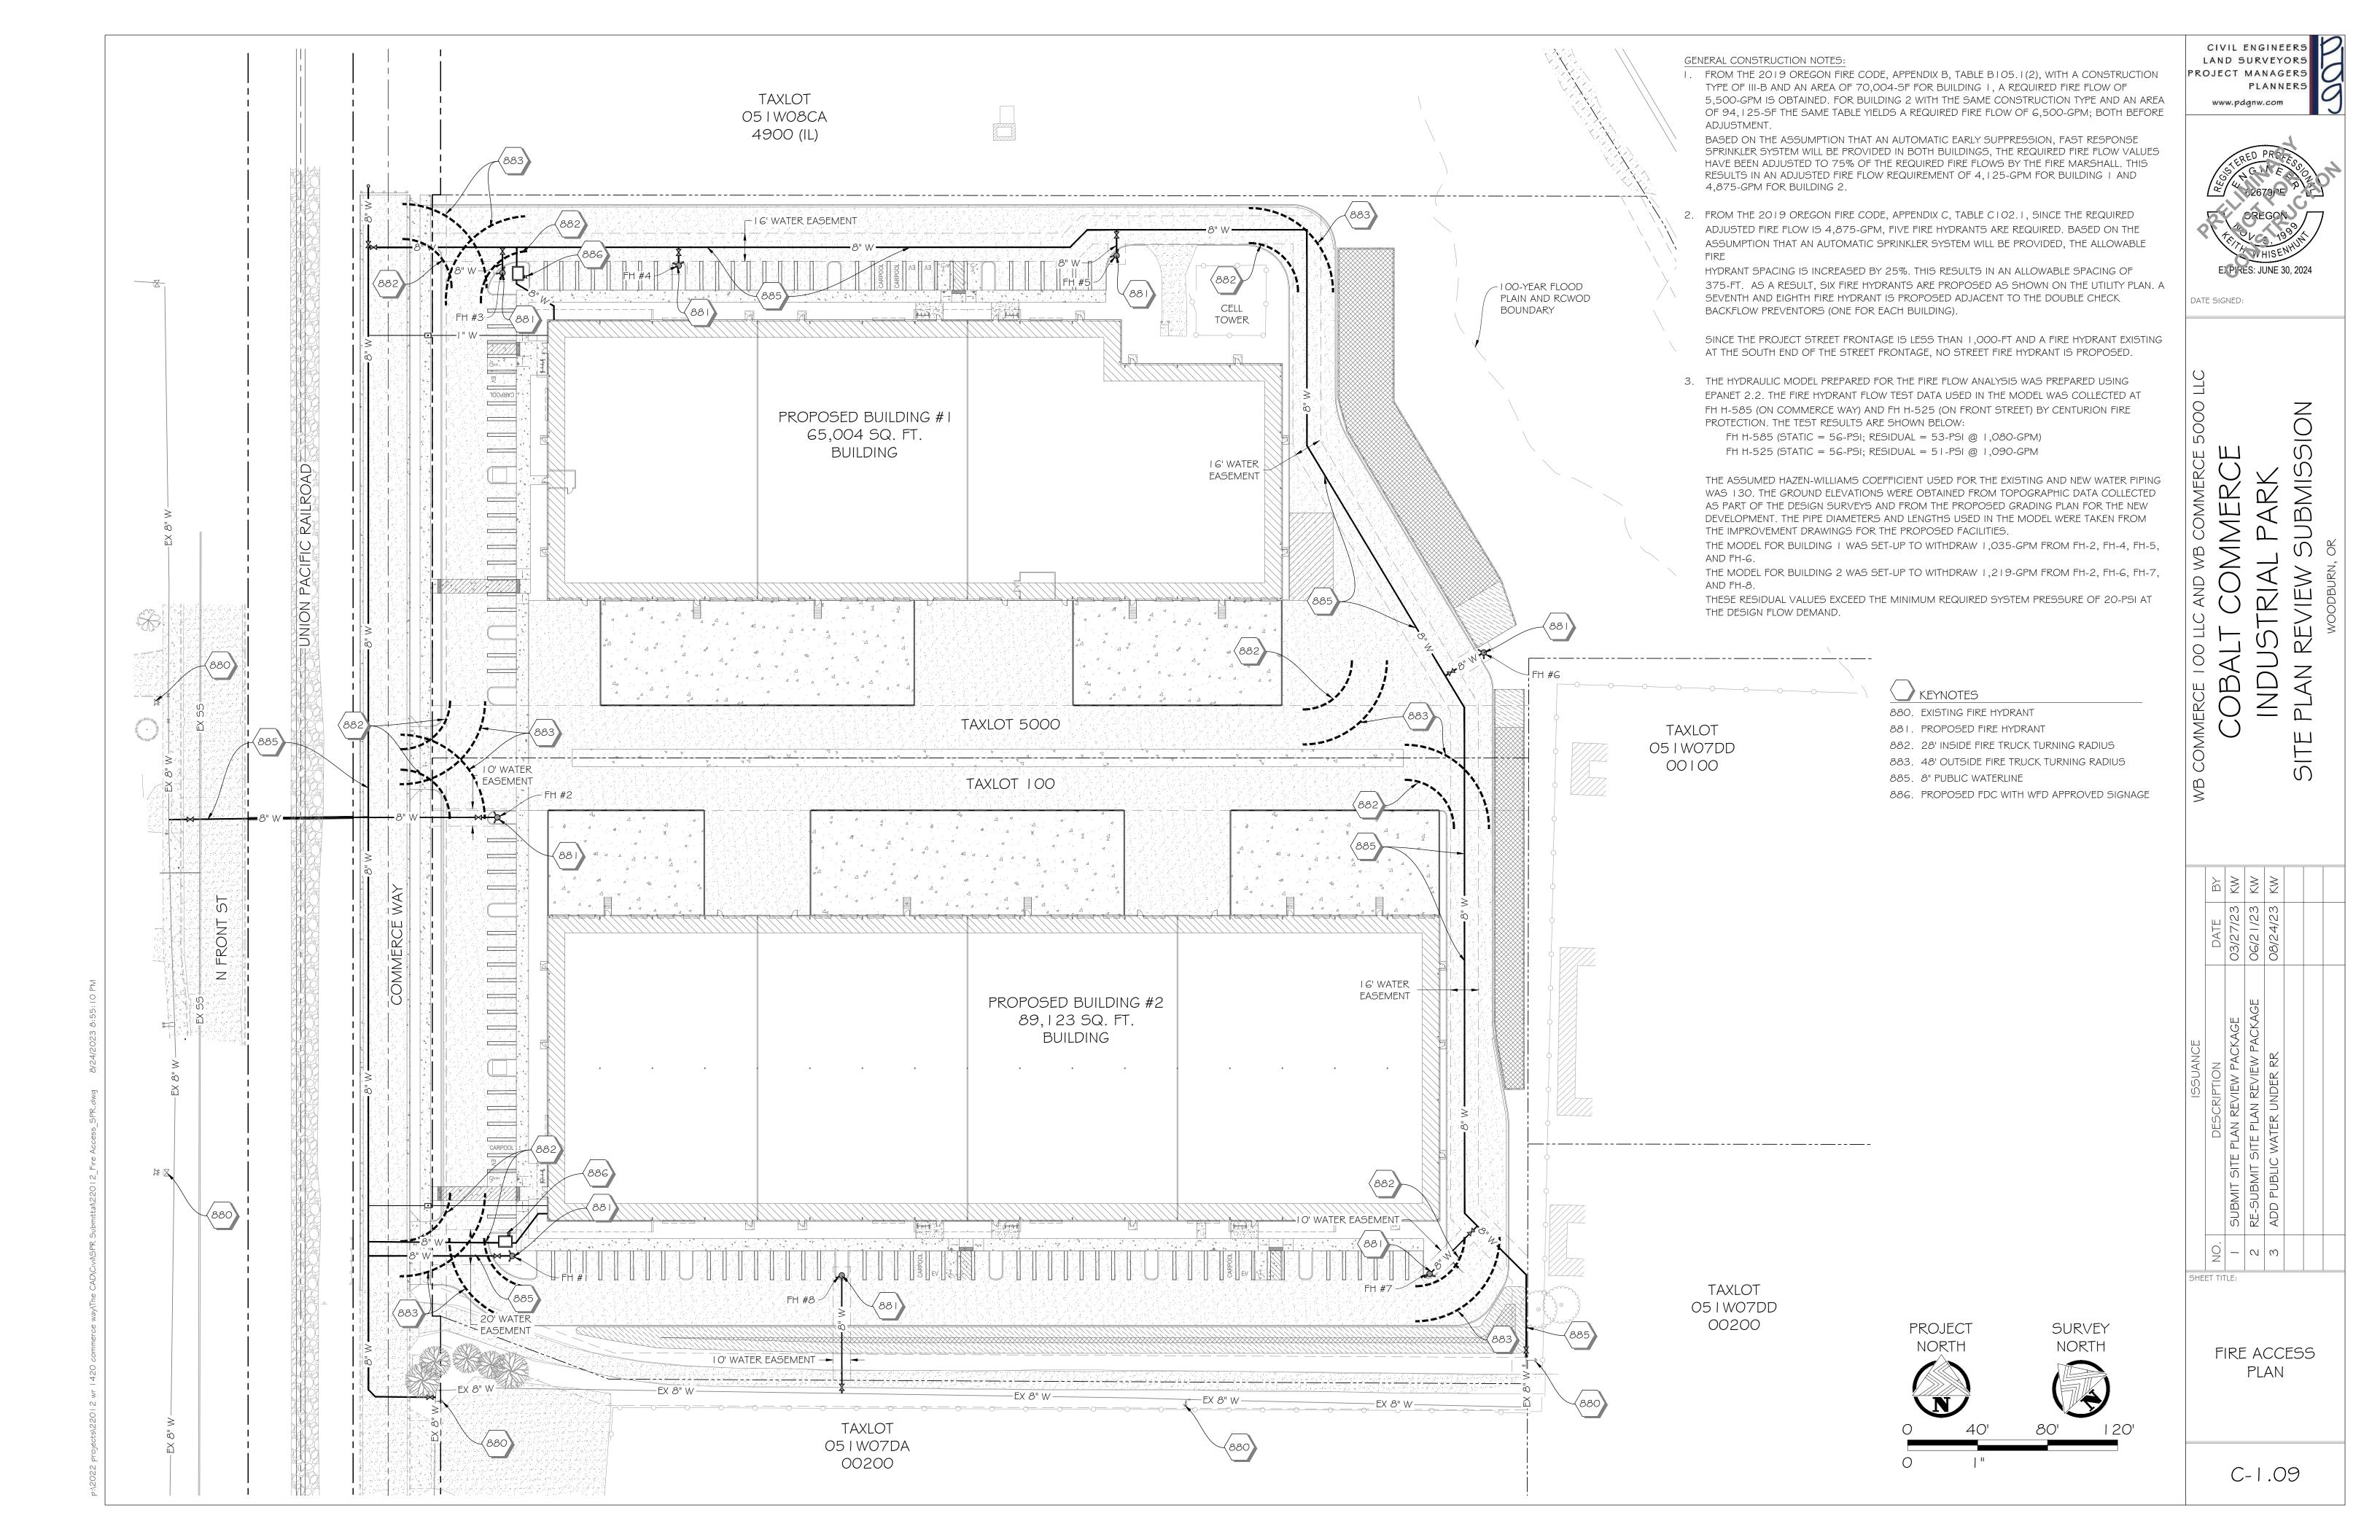

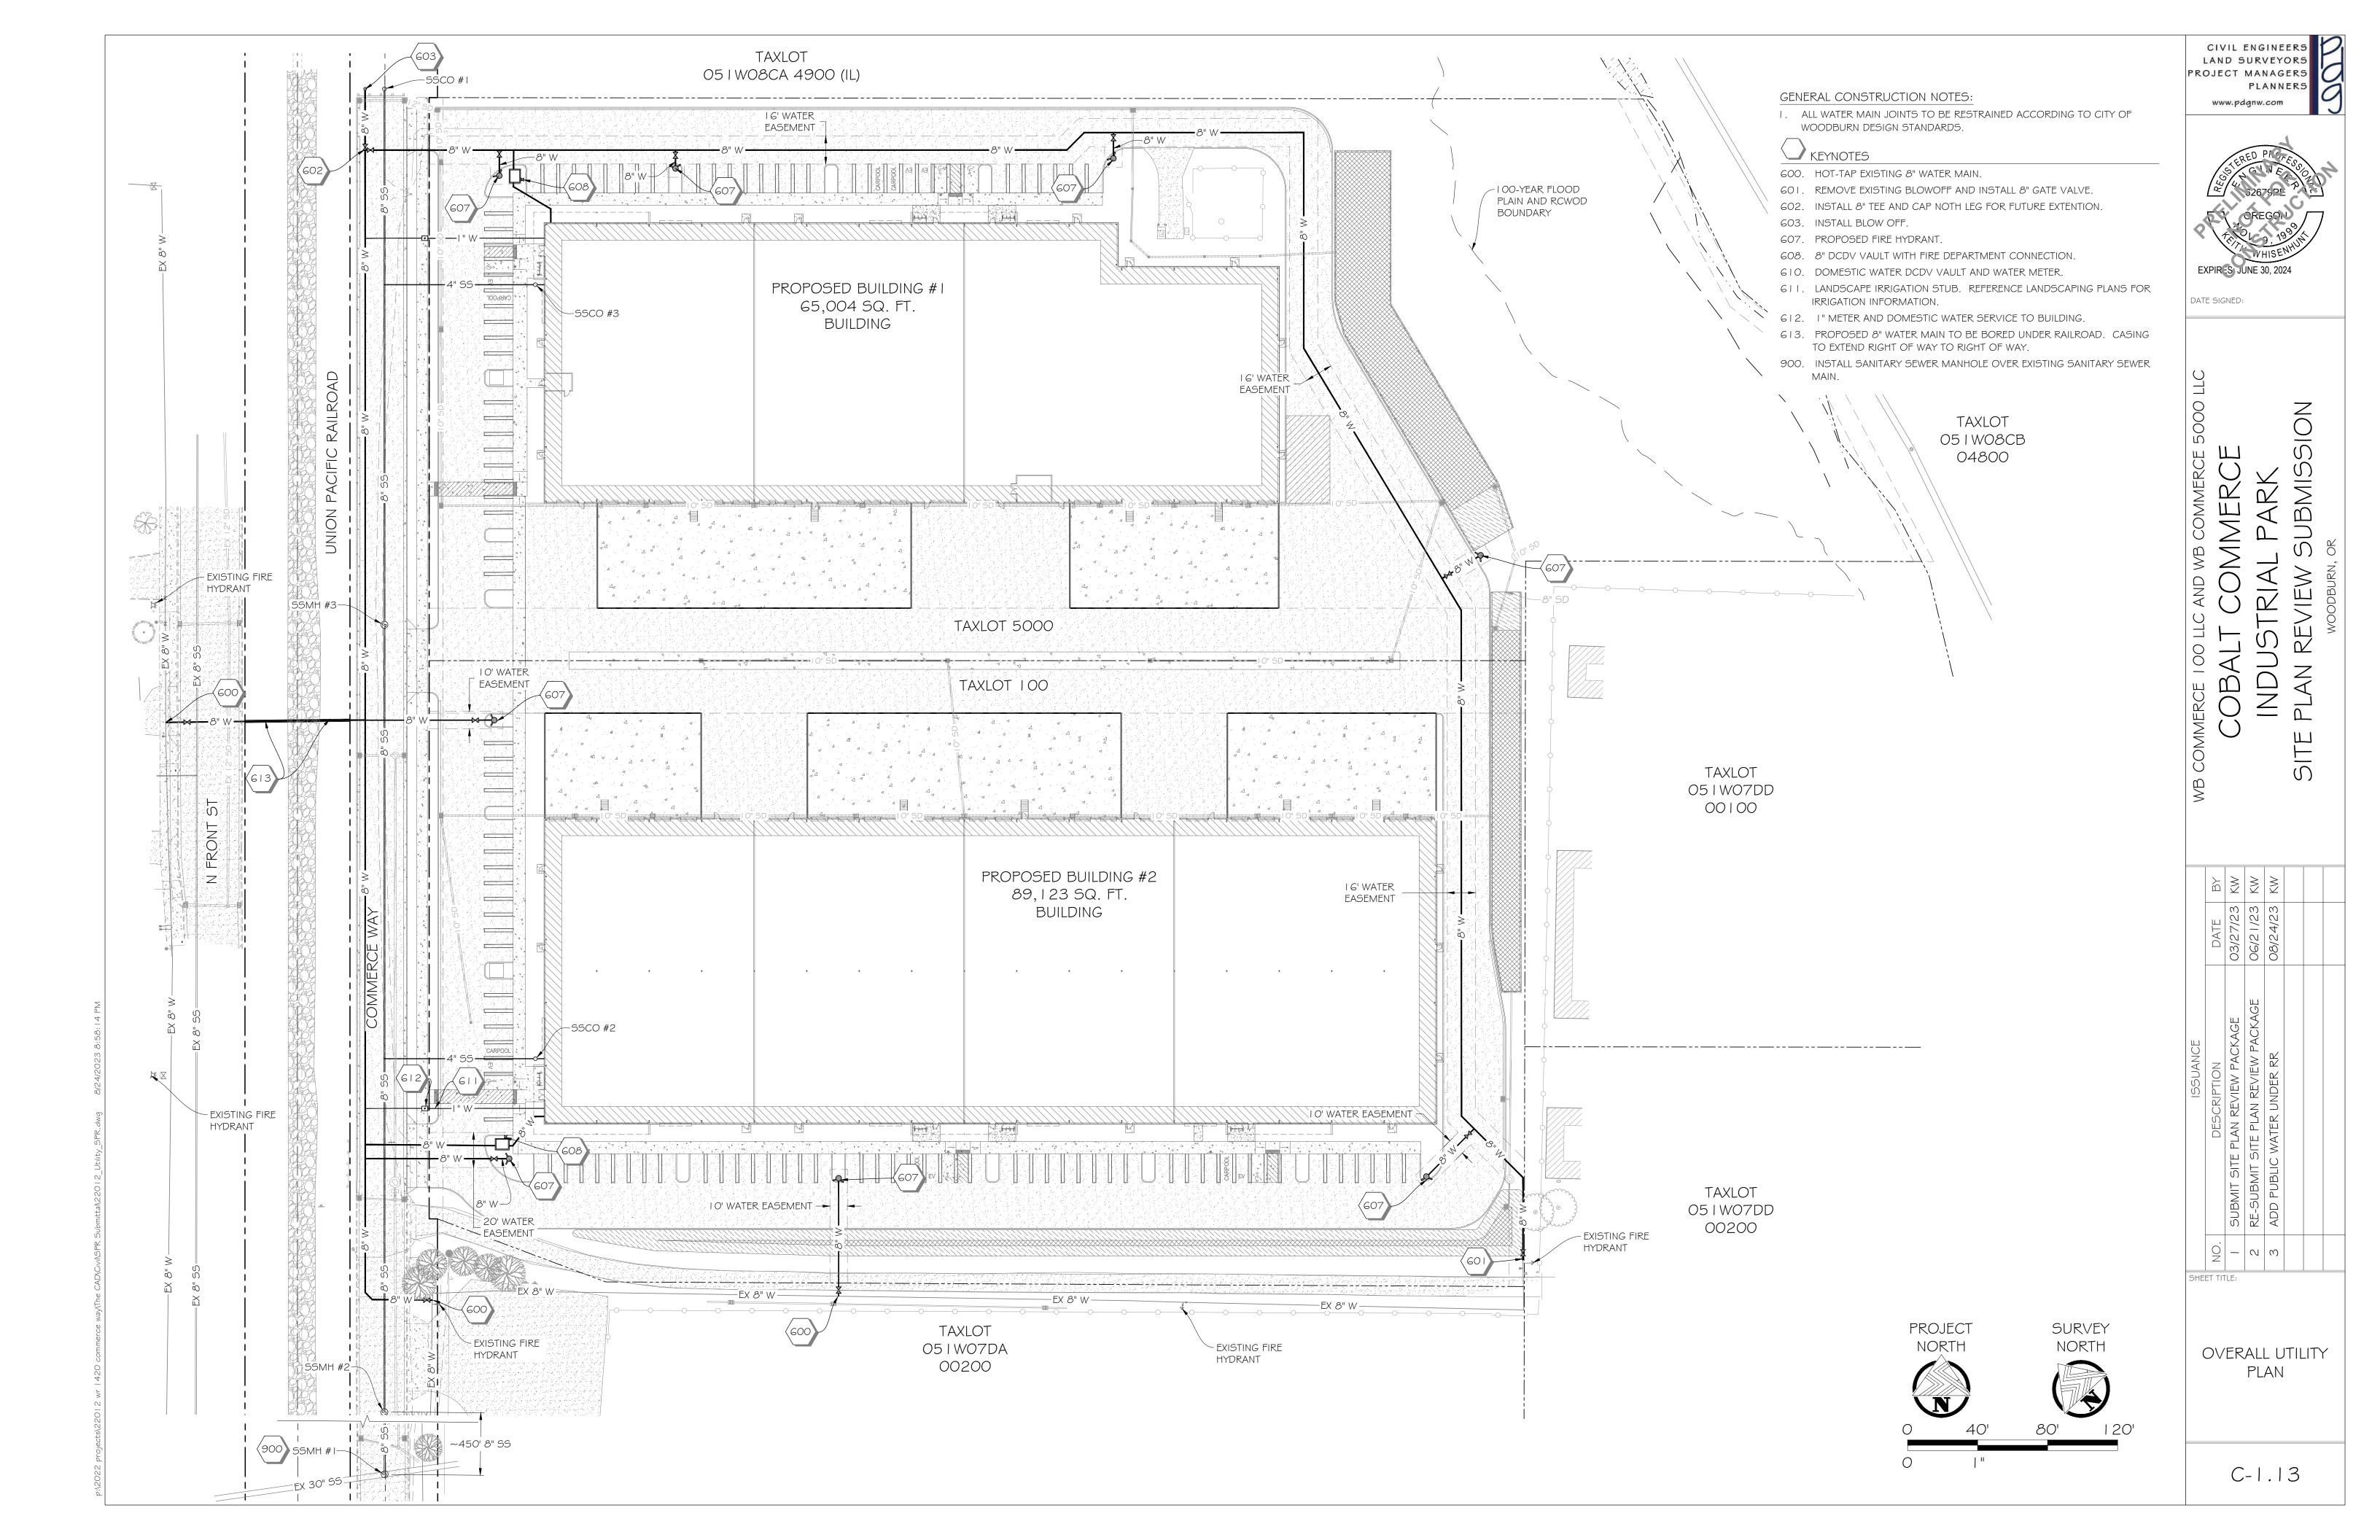

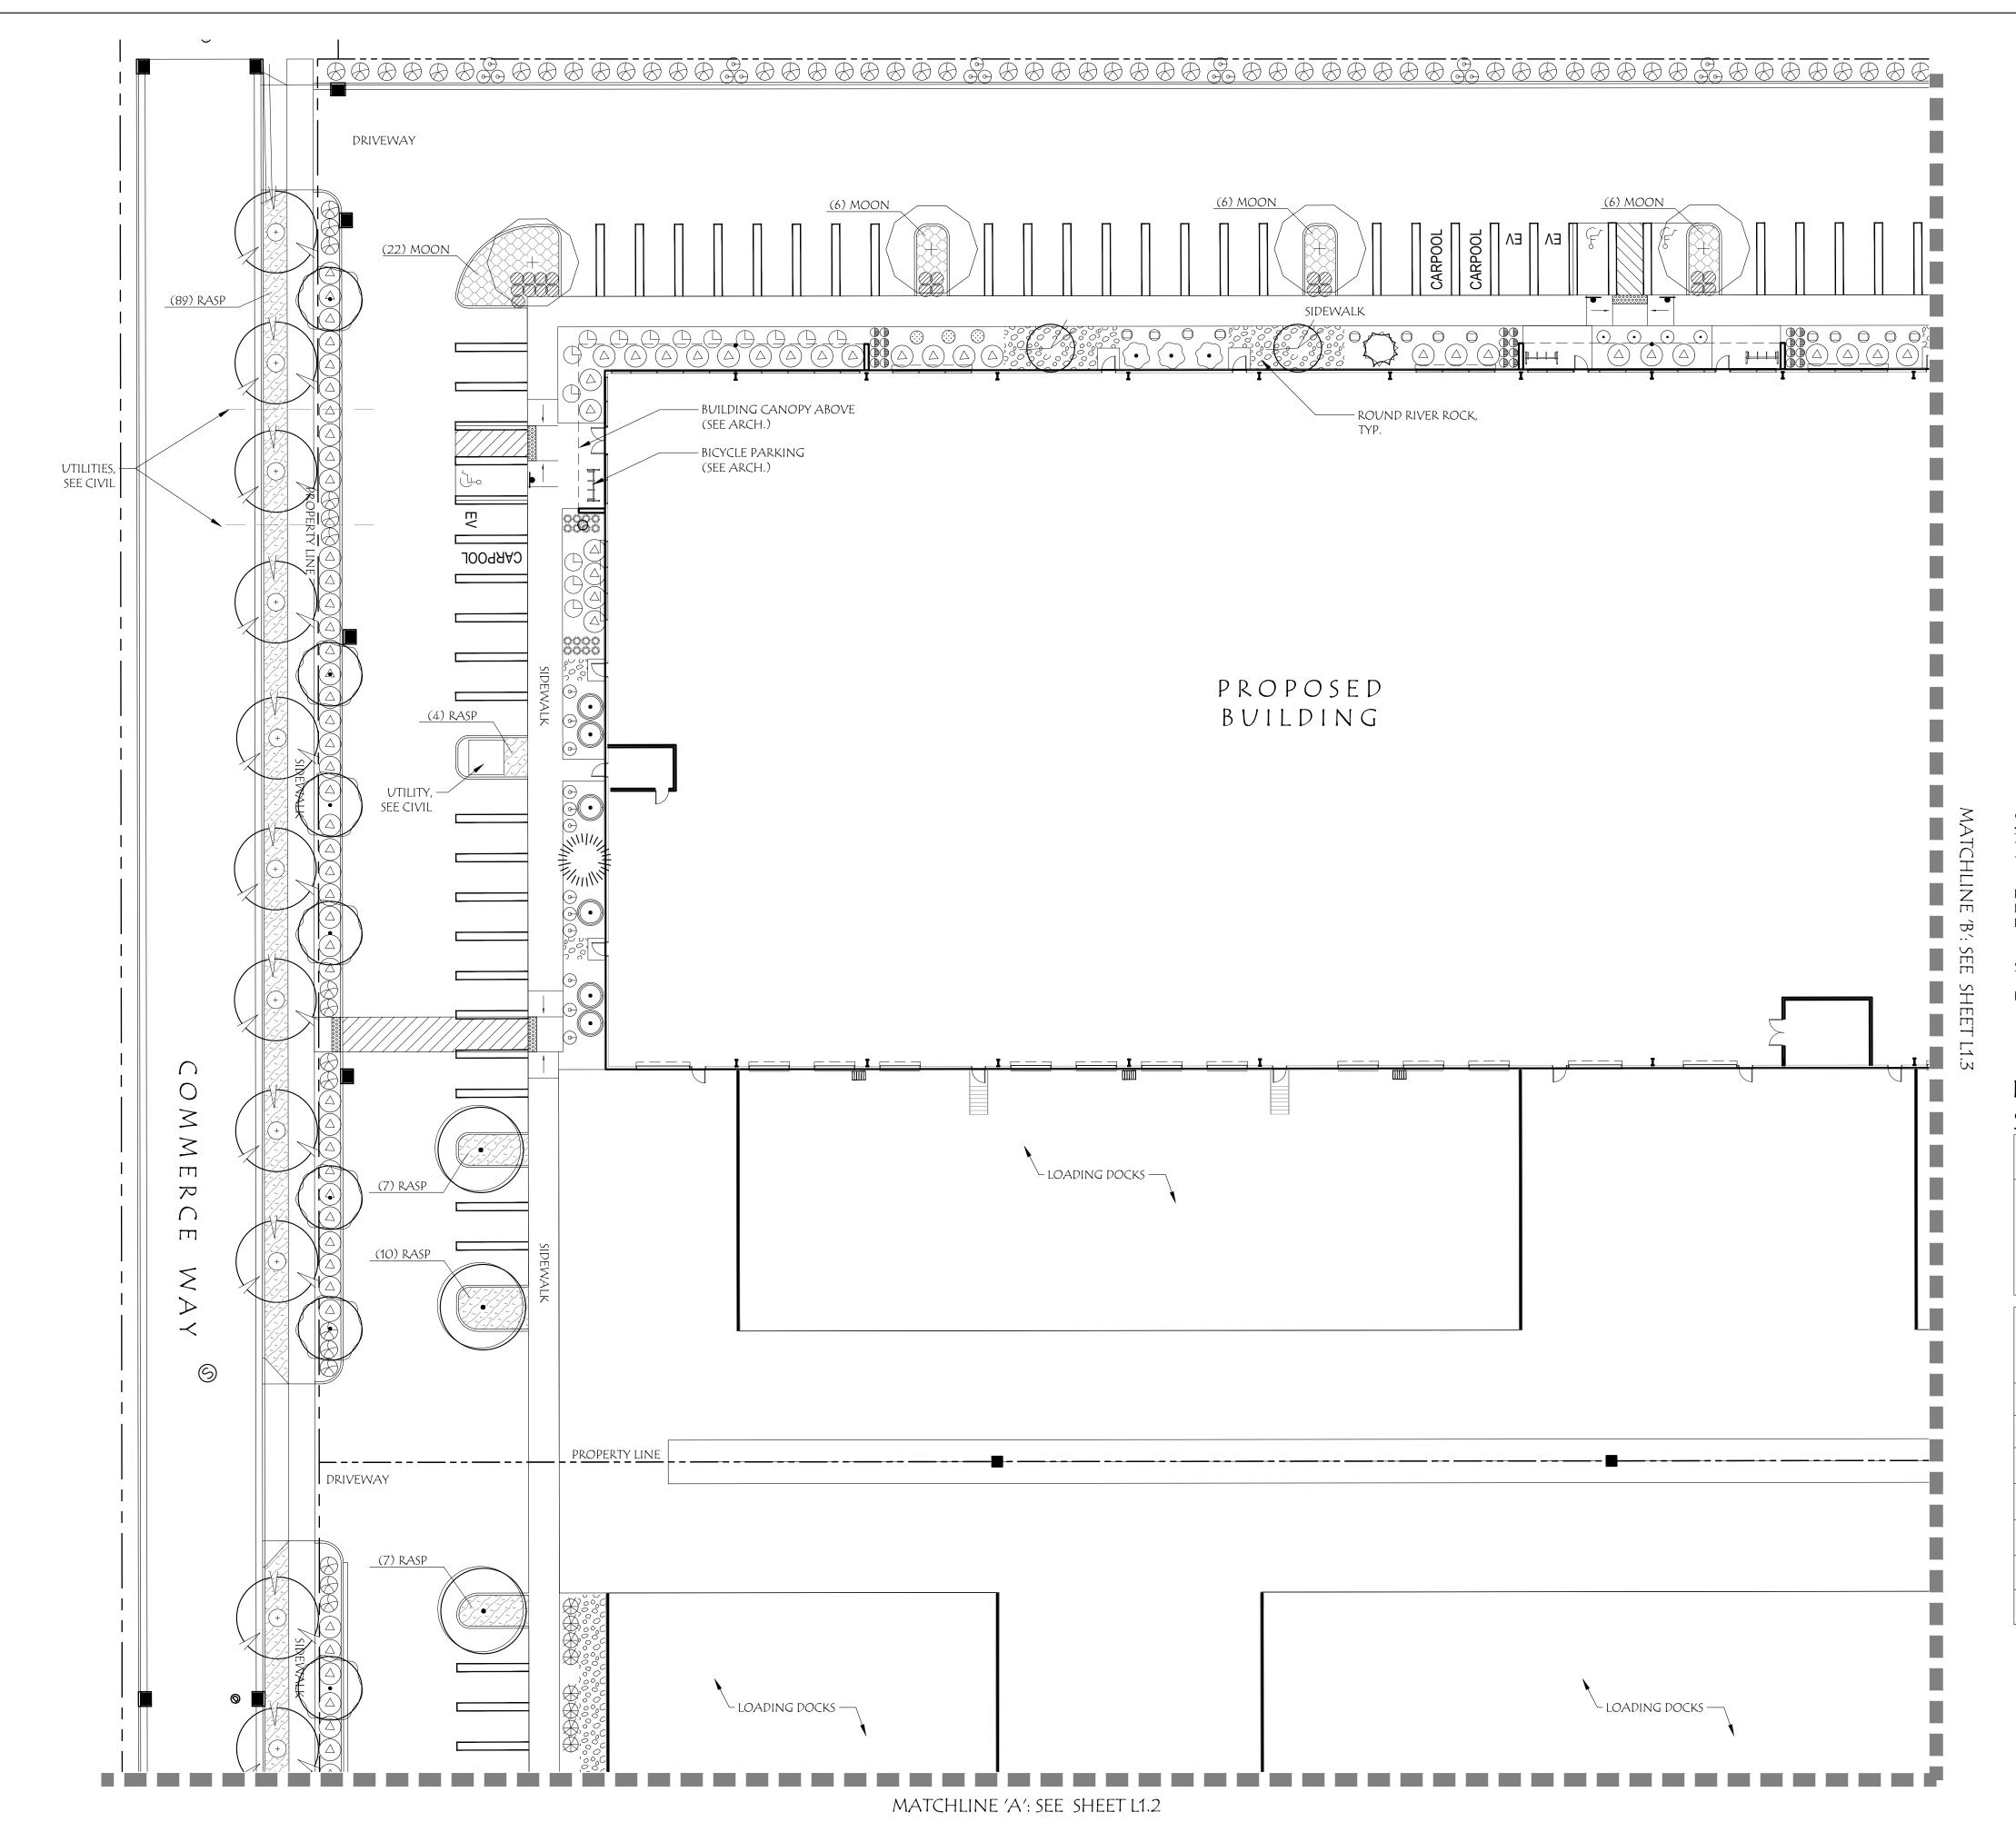

## Key Map:

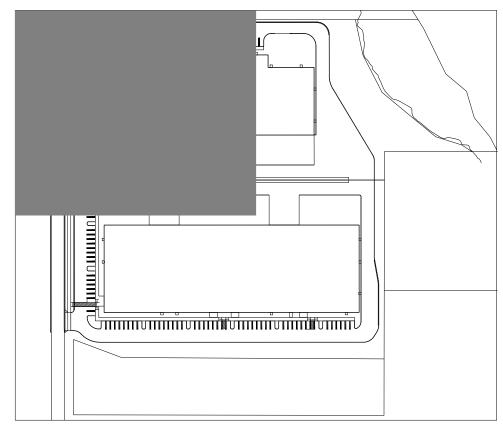

## General Notes:

- 1. PLANS ARE PRELIMINARY, NOT FOR BIDDING OR CONSTRUCTION.
- 2. SEE ARCHITECTURAL DRAWINGS FOR SITE PLAN AND BUILDING DETAILS.
- 3. STREET TREES SELECTED FROM WOODBURN APPROVED STREET TREE LIST FOR SMALL TREES.
- 4. PLANTING REQUIREMENTS SEE THIS SHEET, L1.2 AND L1.3.
- 5. PLANT SCHEDULE SEE SHEET L1.4.
- 6. STREET TREE PLANTING DETAIL SEE SHEET L1.4.
- 7. FINAL PLANTING NOTES AND DETAILS TO BE INCLUDED IN PERMIT SET.
- 8. IRRIGATION TO BE AN AUTOMATIC UNDERGROUND IRRIGATION SYSTEM DESIGNED BY THE LANDSCAPE ARCHITECT.

#### Site Information

TOTAL SITE AREA (SF) = 496,584 SF (11.4 ACRES) TOTAL LANDSCAPE AREA = 52,360 SF

PARKING AREA: 57,812 SF REQUIRED: 10% = 5,781 SF PROPOSED: 6,043 SF

SMALL STREET TREES REQUIRED FOR LOCAL STREET: ONE TREE PER EVERY 30 FEET
OF STREET FRONTAGE
PROVIDED: 17 TREES (520 FEET OF STREET FRONTAGE)

## Landscape Planting Requirements: Street Setback

REQUIRED PLANTS: 1 PLANT UNIT (PU) / 15 SF

SIGNIFICANT TREE = 15 PU

LARGE TREE = 10 PU

MEDIUM TREE = 8 PU

SMALL TREE = 4 PU

LARGE SHRUB = 2 PU

SMALL/MEDIUM SHRUB = 1 PU

LAWN/GROUND COVER = 1 PU / 50 SF

LANDSCAPE SQUARE FOOTAGE = 3,096 SF NUMBER OF PLANT UNITS = 206 PU

Plants	# of Plants	Plant Units
Large Tree	-	-
Medium Tree	-	-
Small Tree	12	48
Large Shrub	70	140
Small / Medium Shrub	35	35
Lawn / Groundcover	-	-
Total Plant Units		223



Cobalt Commerce Industrial Park

Commerce Way Woodburn, Oregon



PRELIMINARY PLANTING PLAN



SCALE: 1"=20-0"


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June 22nd, 2023


revisions			
#	DATE	NOTES	INITIALS

L1.1

PROJECT #: 1504C

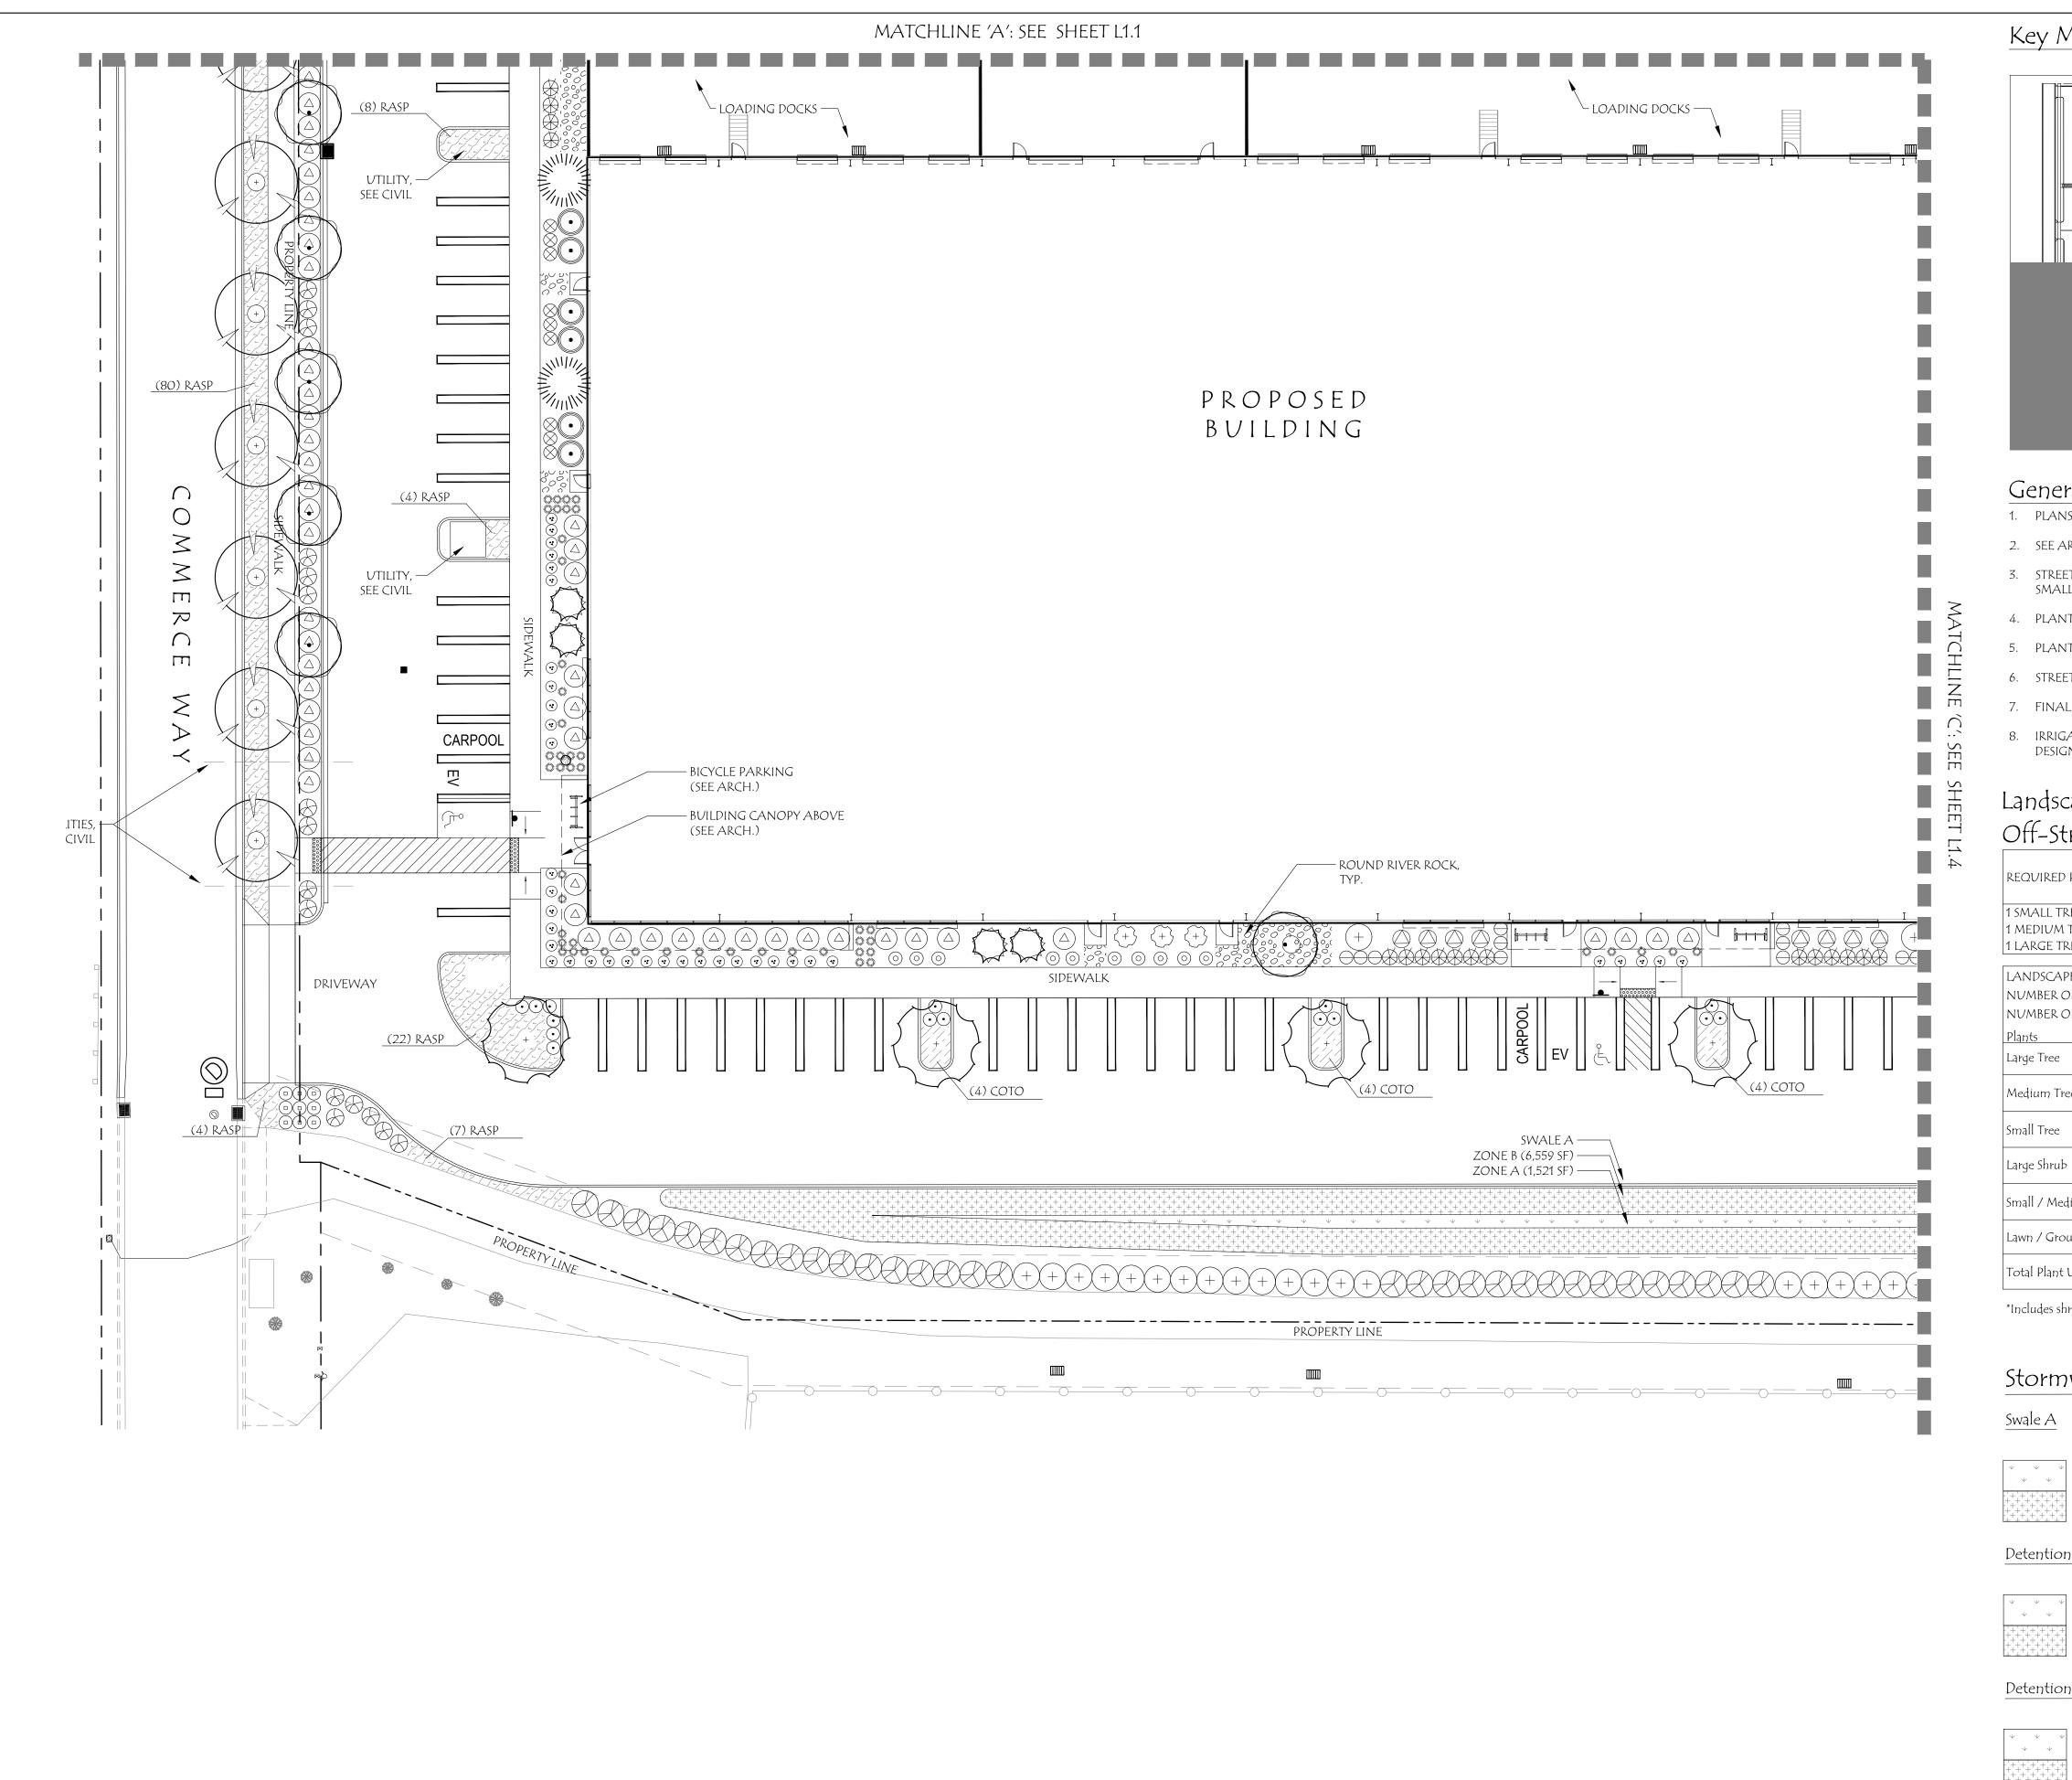

## Key Map:

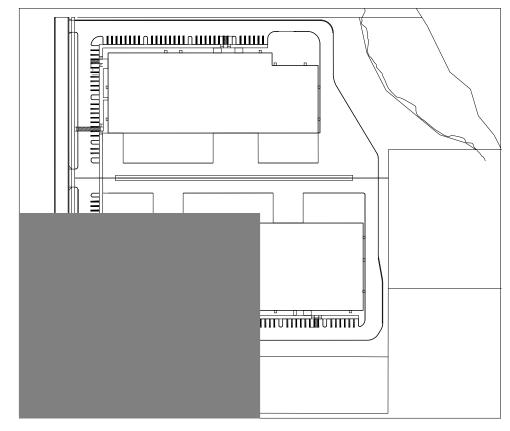

## General Notes:

- 1. PLANS ARE PRELIMINARY, NOT FOR BIDDING OR CONSTRUCTION.
- 2. SEE ARCHITECTURAL DRAWINGS FOR SITE PLAN AND BUILDING DETAILS.
- STREET TREES SELECTED FROM WOODBURN APPROVED STREET TREE LIST FOR SMALL TREES.
- 4. PLANTING REQUIREMENTS SEE THIS SHEET L1.1 AND L1.3.
- 5. PLANT SCHEDULE SEE SHEET L1.4.
- 6. STREET TREE PLANTING DETAIL SEE SHEET L1.4.
- 7. FINAL PLANTING NOTES AND DETAILS TO BE INCLUDED IN PERMIT SET.
- 8. IRRIGATION TO BE AN AUTOMATIC UNDERGROUND IRRIGATION SYSTEM DESIGNED BY THE LANDSCAPE ARCHITECT.

## Landscape Planting Requirements: Off-Street Parking/Loading

REQUIRED PLANTS: PARKING SPACES BELOW 1 SMALL TREE PER 10 PARKING SPACES 1 MEDIUM TREE PER 15 PARKING SPACES 1 LARGE TREE PER 25 PARKING SPACES

LANDSCAPE SQUARE FOOTAGE = 14,022 SF					
NUMBER OF PLANT UNITS = 701 PU NUMBER OF PARKING SPACES = 128 SPACES = 13 SMALL TREES					
Plants	Plants # of Plants Plant Units				
Large Tree	-	-			
Medium Tree	-	-			
Small Tree	14	56			
Large Shrub	12	24			
Small / Medium Shrub	531	531			
Lawn / Groundcover 10,354 SF 207					
Total Plant Units 818					

\*Includes shrubs planted in Stormwater Swale A

## Stormwater Facility Planting Requirements

	SWALE AREA:	8,080
Ψ Ψ Ψ Ψ Ψ	ZONE A AREA:	1,521 SI
+++++++++++++++++++++++++++++++++++++++	ZONE B AREA:	6,559 S

#### Detention Basin B

	DETENTION BASIN AREA:	3,860 SF
ψ ψ ψ ψ ψ	ZONE A AREA:	3,107 SF
+'+'+'+'+'+ -++++++ -+++++++++++++++++	zone b Area:	439 SF

#### Detention Basin C

	DETENTION BASIN AREA:	7,724 SF	
\( \psi \)	ZONE A AREA:	6,678 SF	
	zone b Area:	698 SF	
*Planting C	alculations derived from		
City of Portland Stormwater Management Manual			



Cobalt Commerce Industrial Park

Commerce Way Woodburn, Oregon



PRELIMINARY PLANTING PLAN




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0' 10' 20'


June 22nd, 2023

revisions								
#	DATE	NOTES	INITIALS					

PROJECT #: 1504

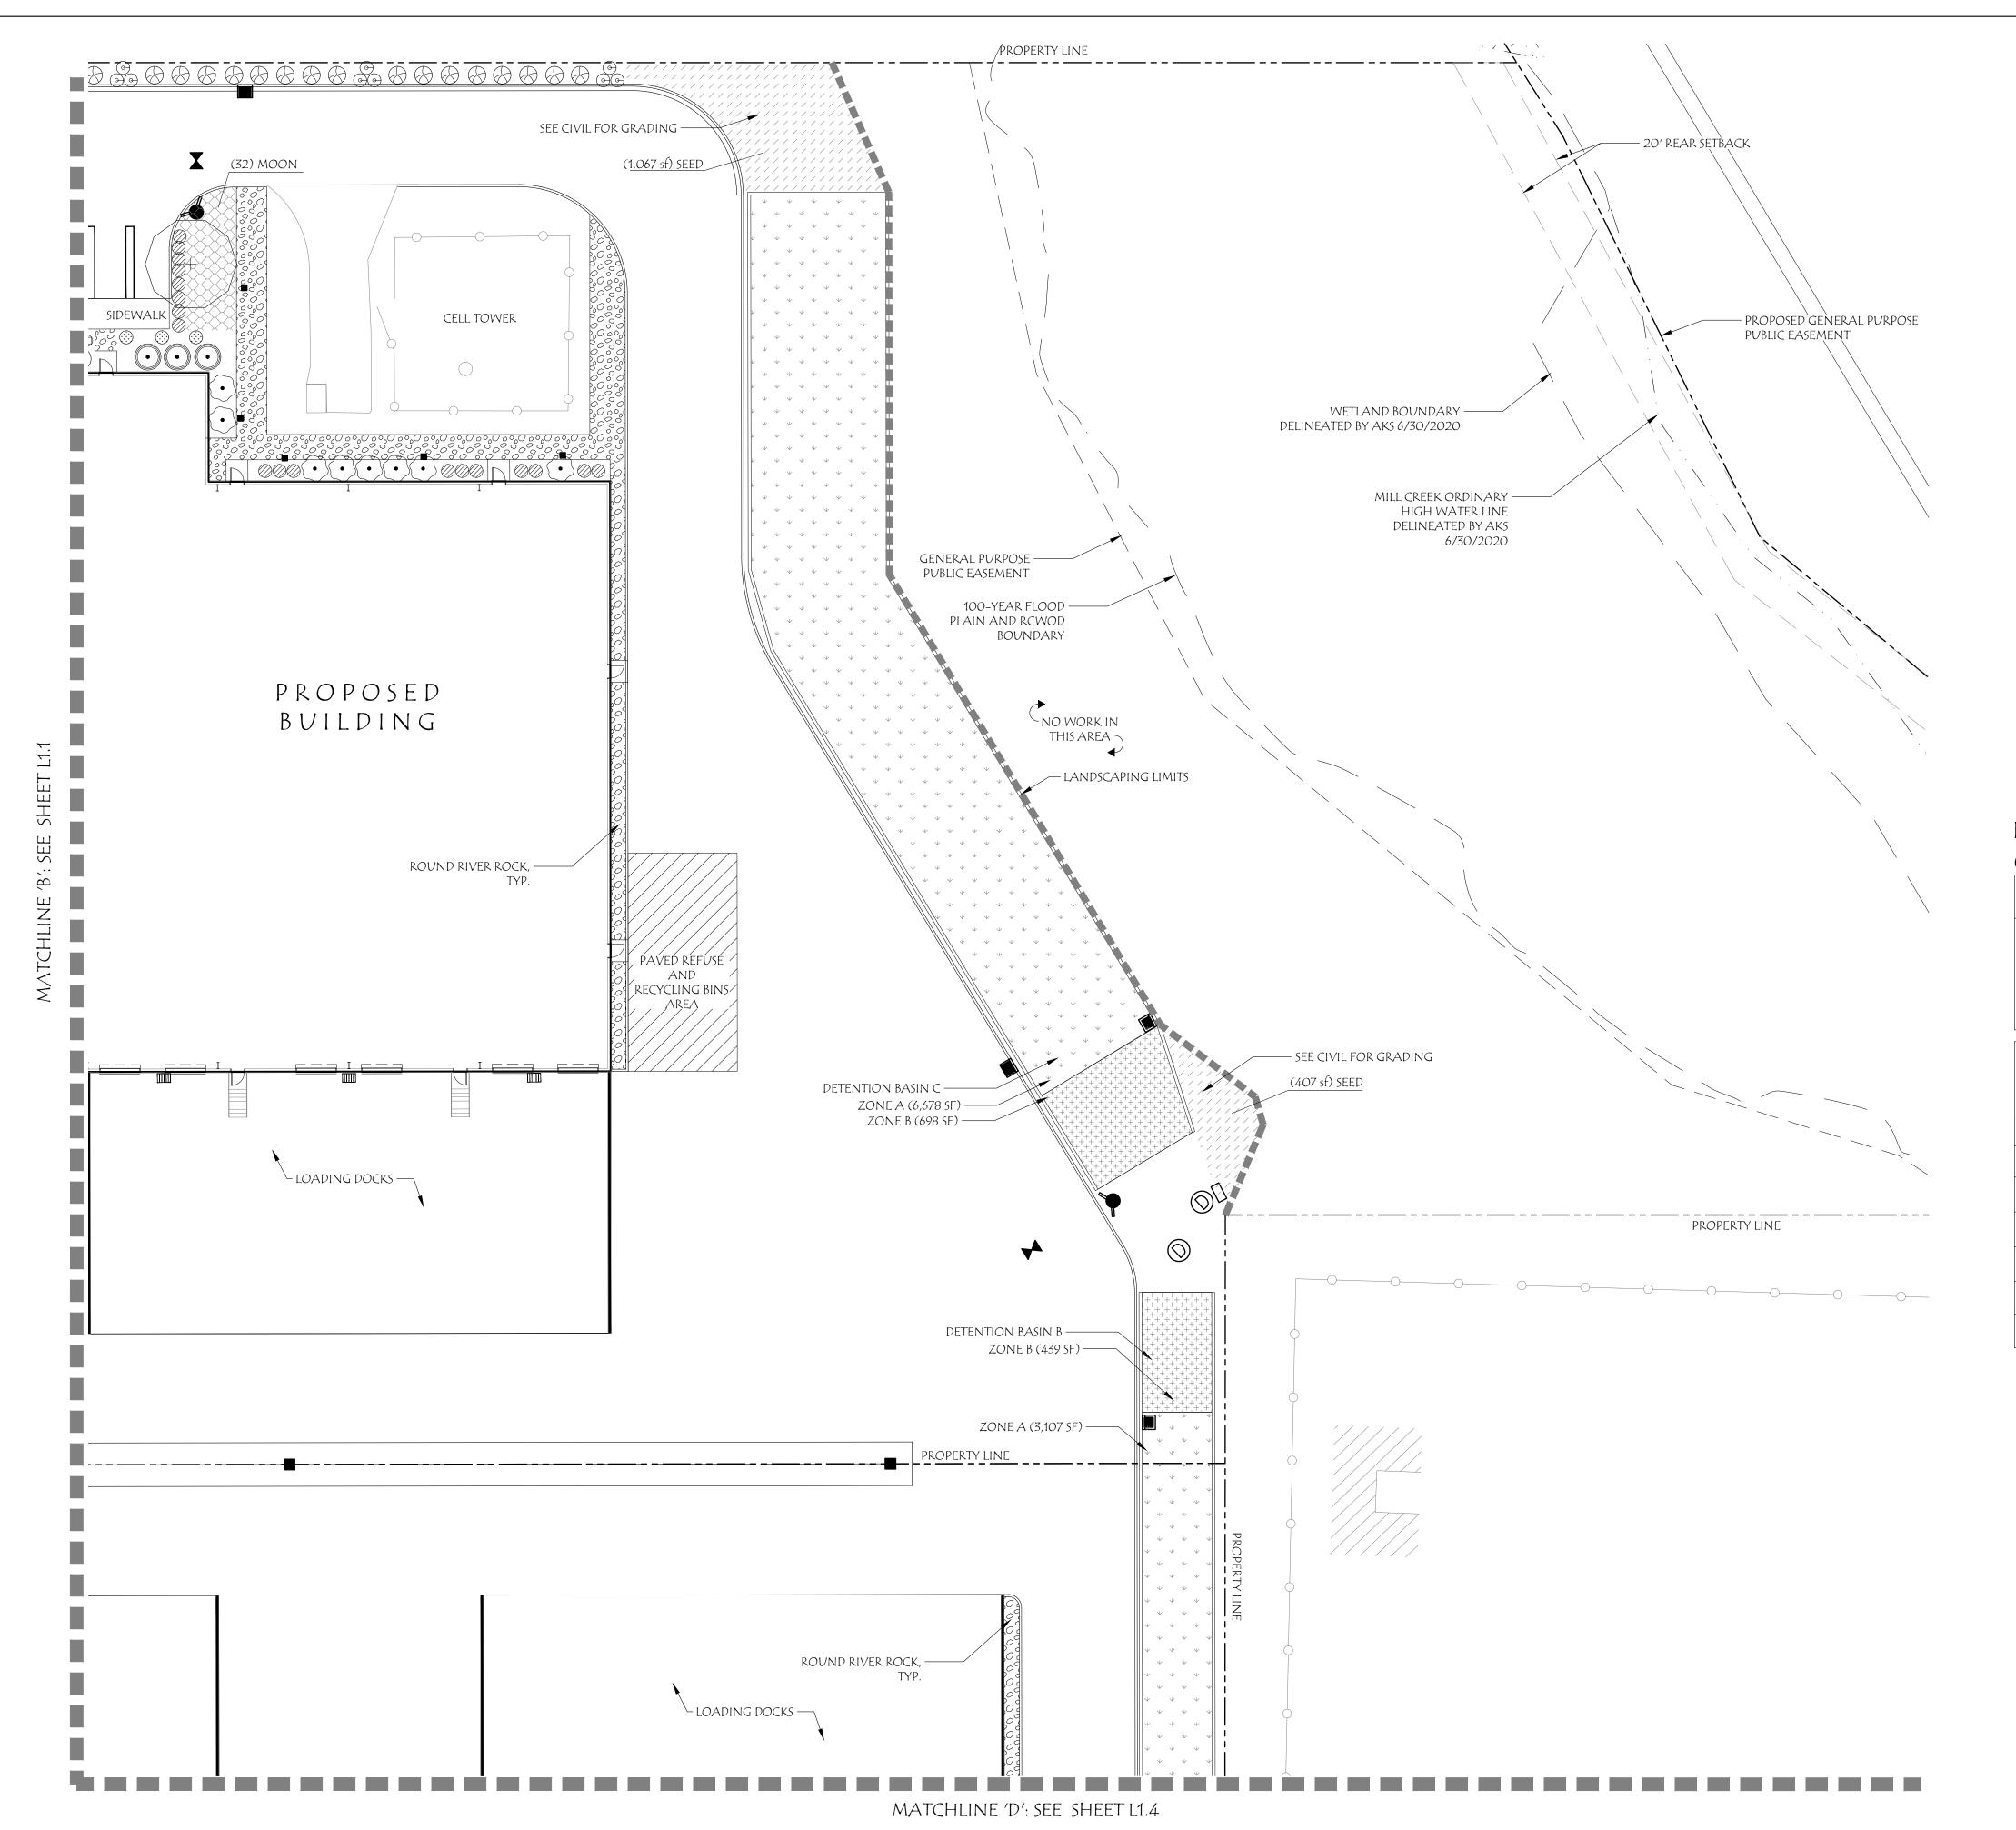

## Key Map:

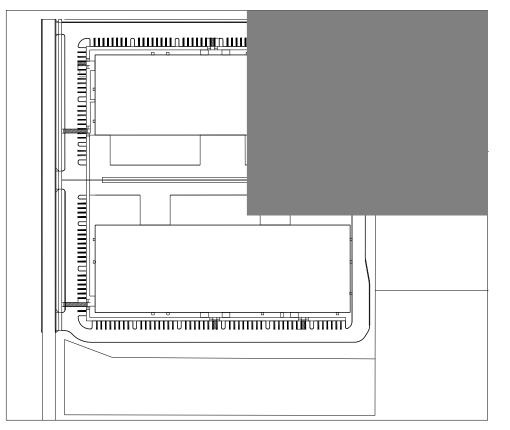

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- 3. STREET TREES SELECTED FROM WOODBURN APPROVED STREET TREE LIST FOR SMALL TREES.
- 4. PLANTING REQUIREMENTS SEE THIS SHEET L1.1 AND L1.2.
- 5. PLANT SCHEDULE SEE SHEET L1.4.
- 6. STREET TREE PLANTING DETAIL SEE SHEET L1.4.
- 7. FINAL PLANTING NOTES AND DETAILS TO BE INCLUDED IN PERMIT SET.
- 8. IRRIGATION TO BE AN AUTOMATIC UNDERGROUND IRRIGATION SYSTEM DESIGNED BY THE LANDSCAPE ARCHITECT.

## Landscape Planting Requirements: Other Yards

REQUIRED PLANTS: 1 PLANT UNIT (PU) / 50 SF

SIGNIFICANT TREE = 15 PU
LARGE TREE = 10 PU
MEDIUM TREE = 8 PU
SMALL TREE = 4 PU
LARGE SHRUB = 2 PU
SMALL/MEDIUM SHRUB = 1 PU
LAWN/GROUND COVER = 1 PU / 50 SF

11 11 11 11 11 11 11 11 11 11 11 11 11									
LANDSCAPE SQUARE FOOTAGE =35,250 SF									
NUMBER OF PLANT UNIT	S = 705 PU								
Plants	# of Plants	Plant Units							
Large Tree	-	-							
Medium Tree	-	-							
Small Tree	13	52							
Jingii Tiec	15	32							
Large Shrub	199	398							
	.,,	2,0							
Small / Medium Shrub	276	276							
Lawn / Groundcover	2,512	50							
Total Plant Units		776							



Cobalt Commerce Industrial Park

Commerce Way Woodburn, Oregon



## PRELIMINARY PLANTING PLAN



SCALE: 1"=20-0"


0′ 10′ 20′

June 22nd, 2023

REVISIONS								
#	DATE	notes	INITIALS					

L1.3

PR∩JFCT #: 15∩/*C* 

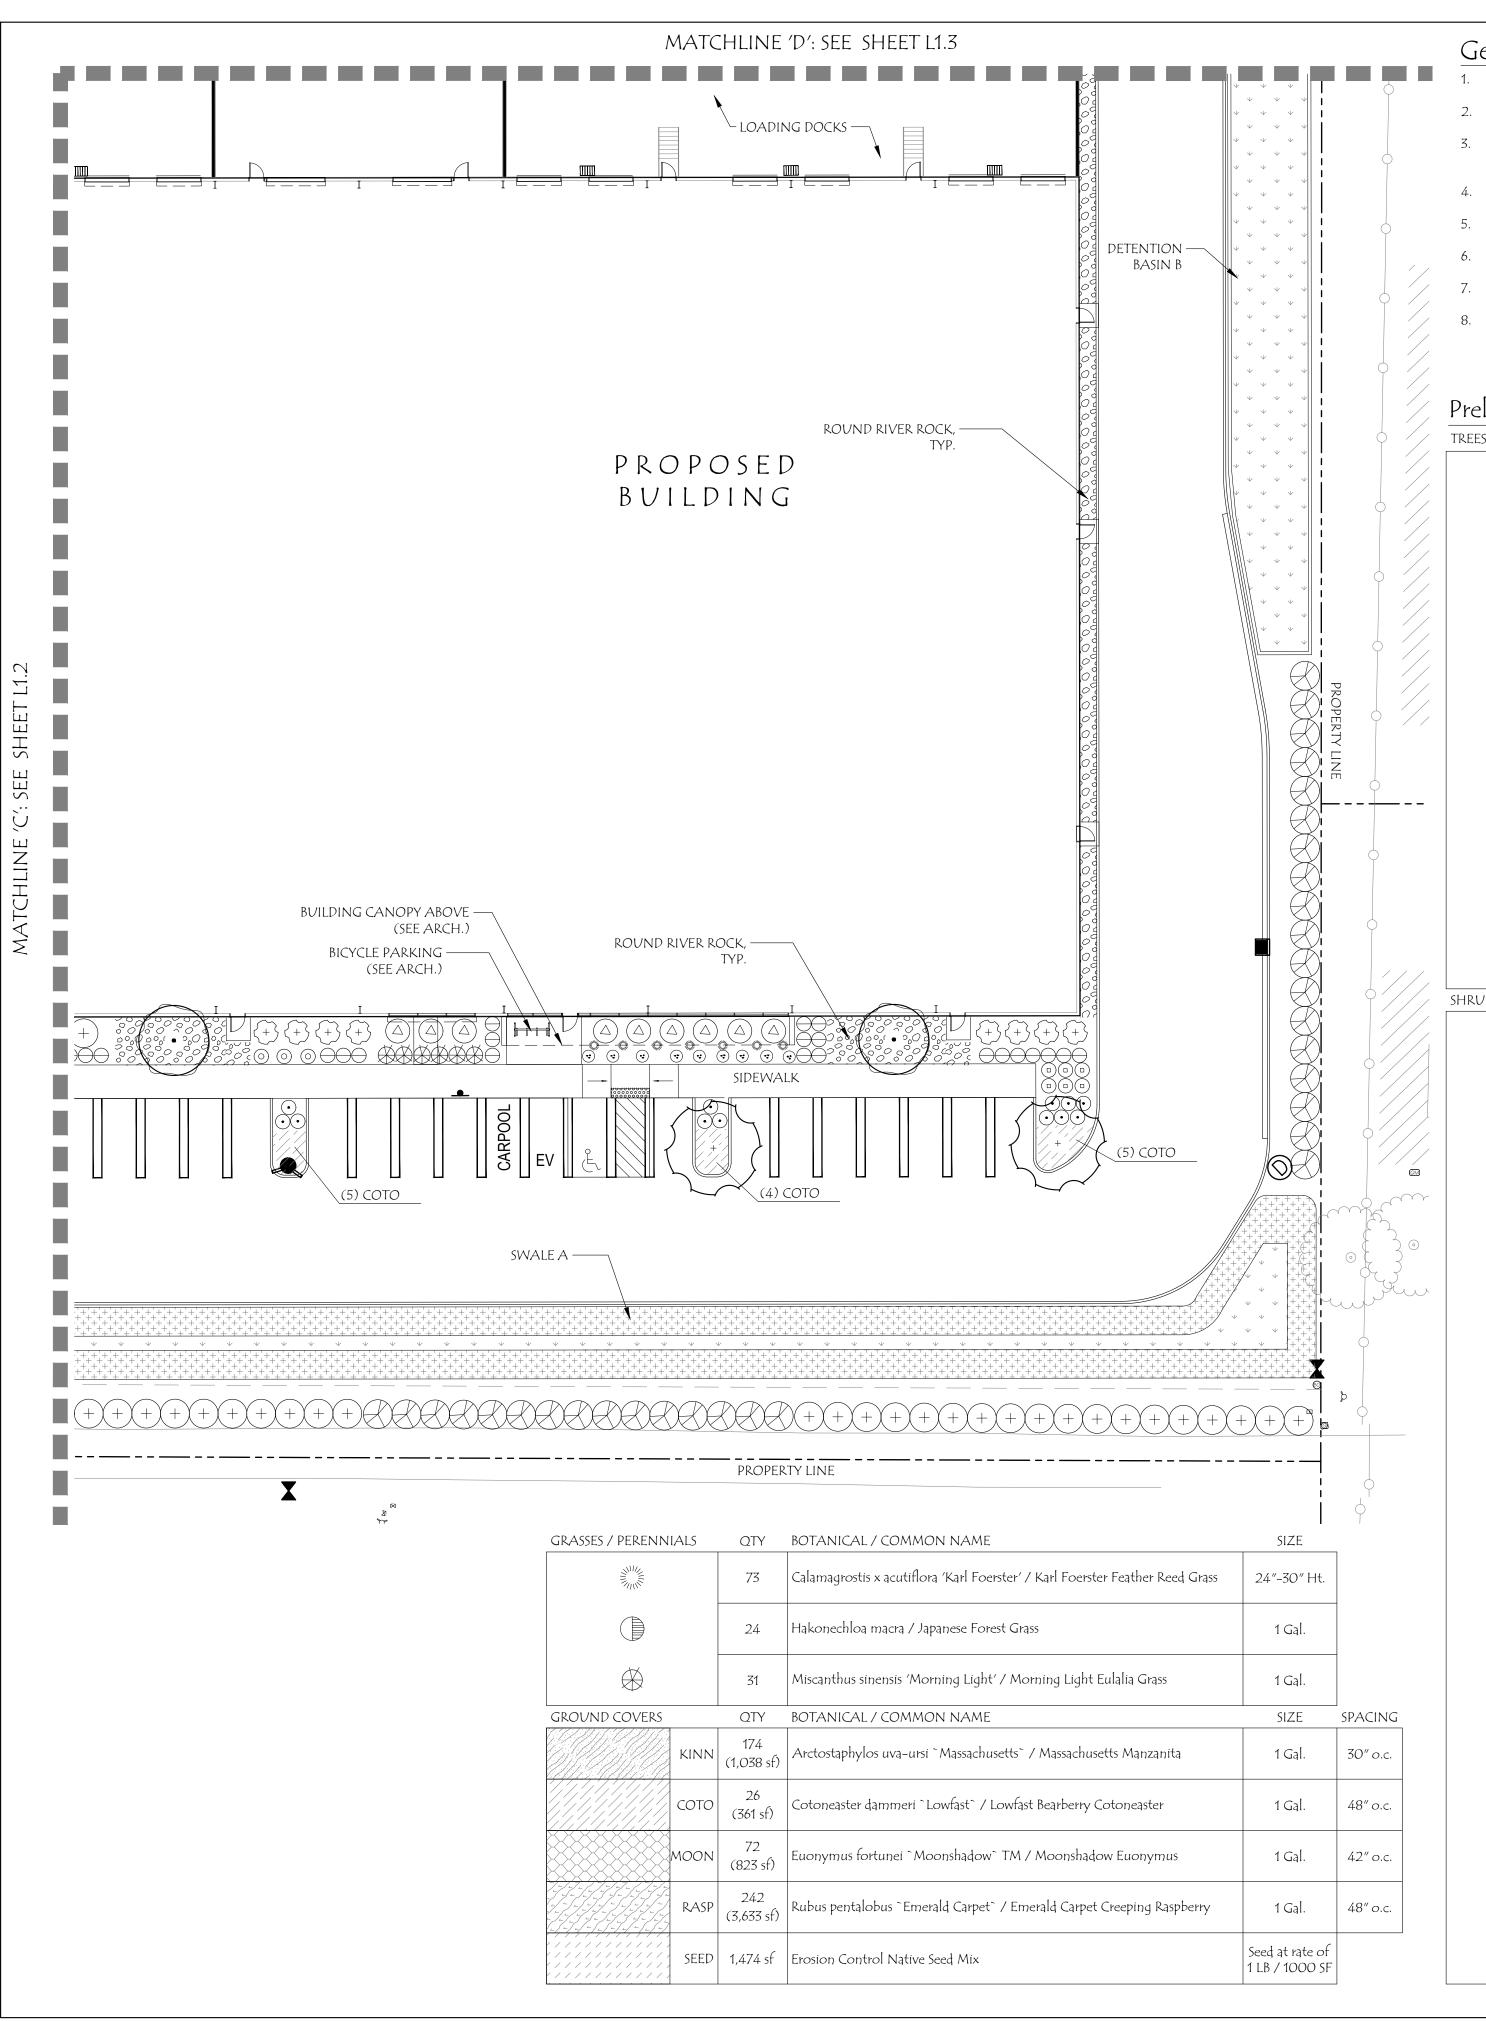

#### General Notes:

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- 4. PLANTING REQUIREMENTS SEE SHEET L1.1 AND L1.2.
- 5. PLANT SCHEDULE SEE THIS SHEET.
- 6. STREET TREE PLANTING DETAIL SEE THIS SHEET.
- 7. FINAL PLANTING NOTES AND DETAILS TO BE INCLUDED IN PERMIT SET.
- 8. IRRIGATION TO BE AN AUTOMATIC UNDERGROUND IRRIGATION SYSTEM DESIGNED BY THE LANDSCAPE ARCHITECT.

## Preliminary Plant Schedule







SIZE

Small

Small

Small

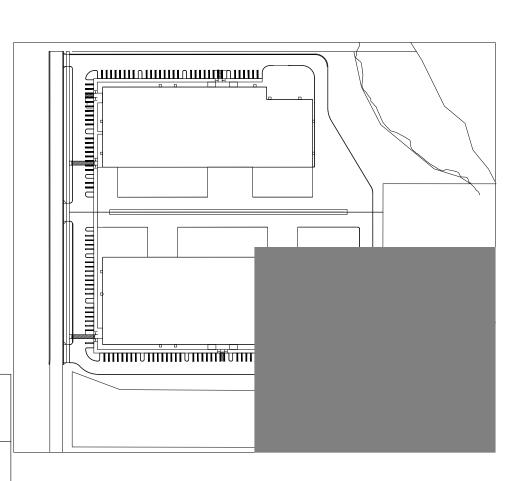

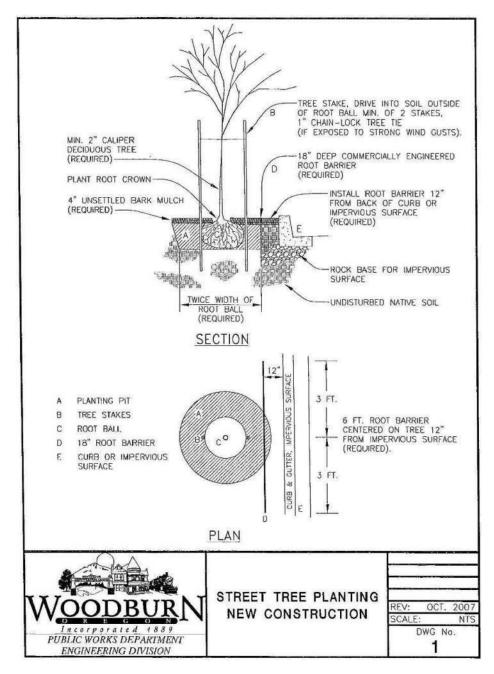



Cobalt Commerce Industrial Park

Commerce Way Woodburn, Oregon



PRELIMINARY PLANTING PLAN





SCALE: 1"=20-0"

June 22nd, 2023

	revisions								
#	DATE	NOTES	initials						

PROJECT #: 1504

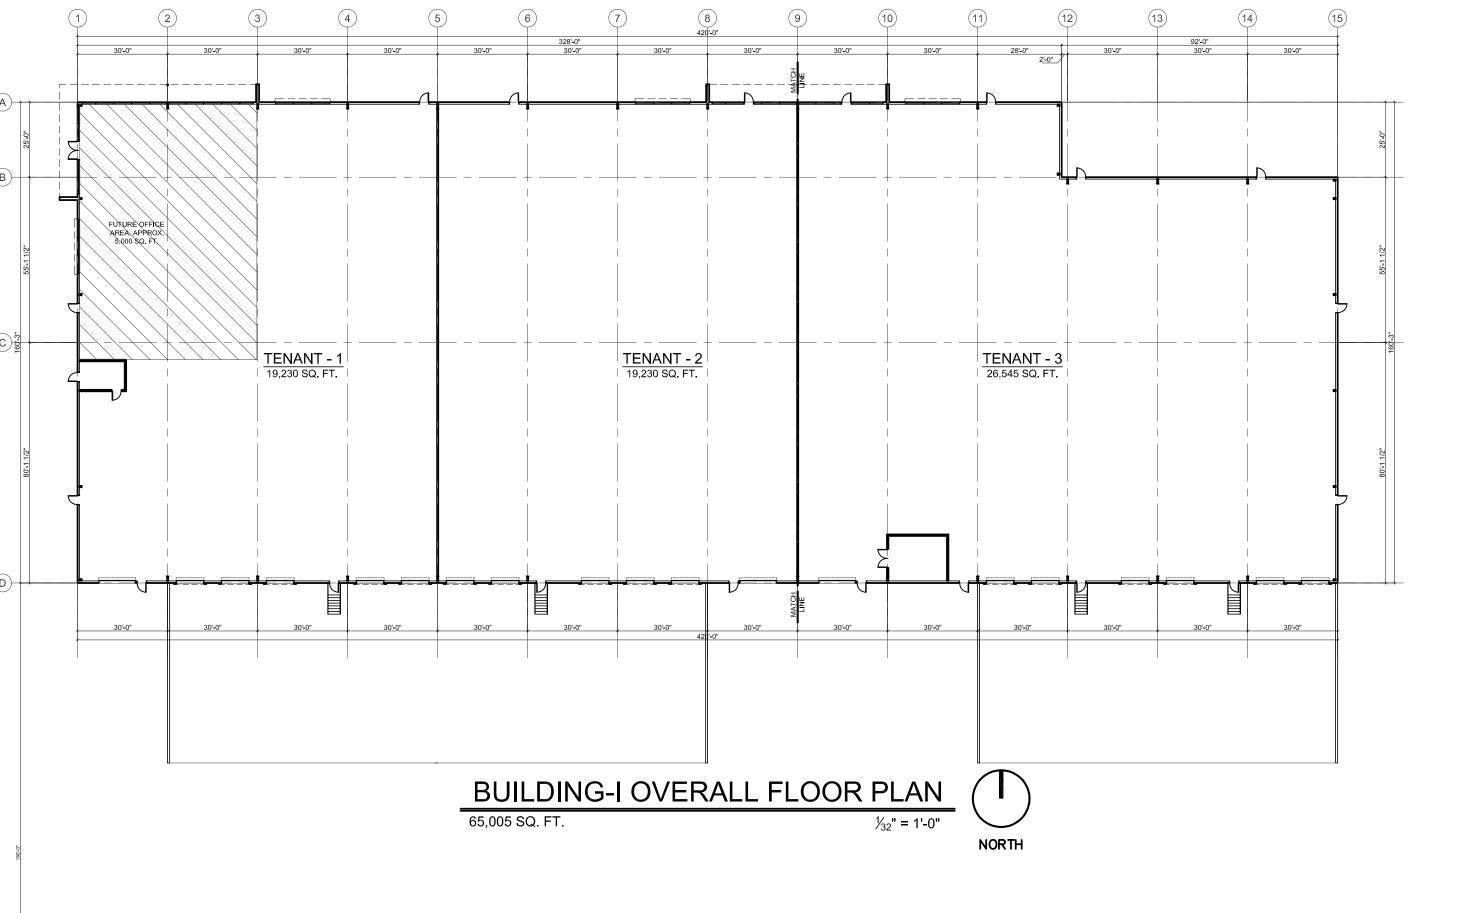

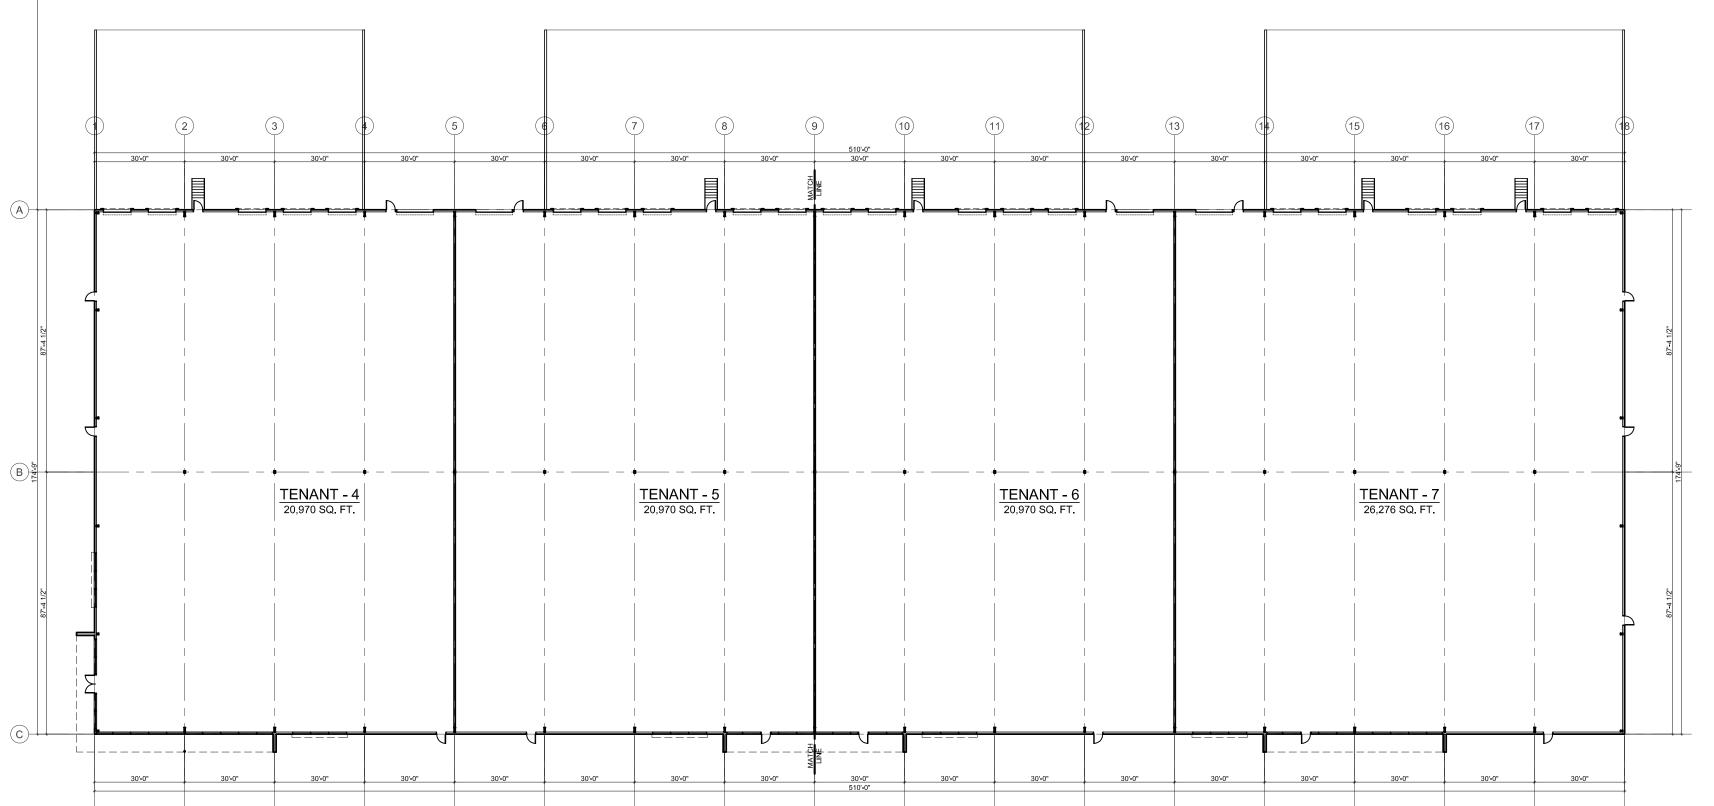

BUILDING-II OVERALL FLOOR PLAN
89,186 SQ. FT.

NORTH

Owner:
WB\_COMMERCE
100,\_LLC
WB\_COMMERCE
5000,\_LLC

Project:
WOODBURN
TWO
BUILDINGS

• Woodburn,\_oregon

Sheet Title:

OVERALL

FLOOR

PLAN

Revisions:

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Date: 6-2-2023

Drawn by: Checked by:

Job Number:
Sheet

= A2

13 Bernini Court Lake Oswego, Oregon 97035 p: 503.781.7068 3.16Architecture@gmail.com

6 30'-0" 30'-0" 30'-0" 30'-0" 30'-0" 30'-0" 30'-0" 30'-0" B Owner: WB\_COMMERCE FUTURE OFFICE AREA, APPROX. 5,000 SQ. FT. TWO C 160-13 TENANT - 1 19,230 SQ. FT. TENANT - 2 19,230 SQ. FT. ELEC. RM. Sheet Title: Revisions: **D**-Drawn by: 30'-0" 30'-0" 30'-0" 30'-0" 30'-0" 30'-0" 30'-0" 30'-0" Job Number: PARTIAL FLOOR PLAN <sup>3</sup>/<sub>32</sub>" = 1'-0"

100,\_LLC WB\_COMMERCE 5000,\_LLC

WOODBURN BUILDINGS

WOODBURN,\_OREGON


PARTIAL FLOOR\_PLAN (BUILDING-I)

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Checked by:

A2.1

13 Bernini Court Lake Oswego, Oregon 97035 p: 503.781.7068 3.16Architecture@gmail.com

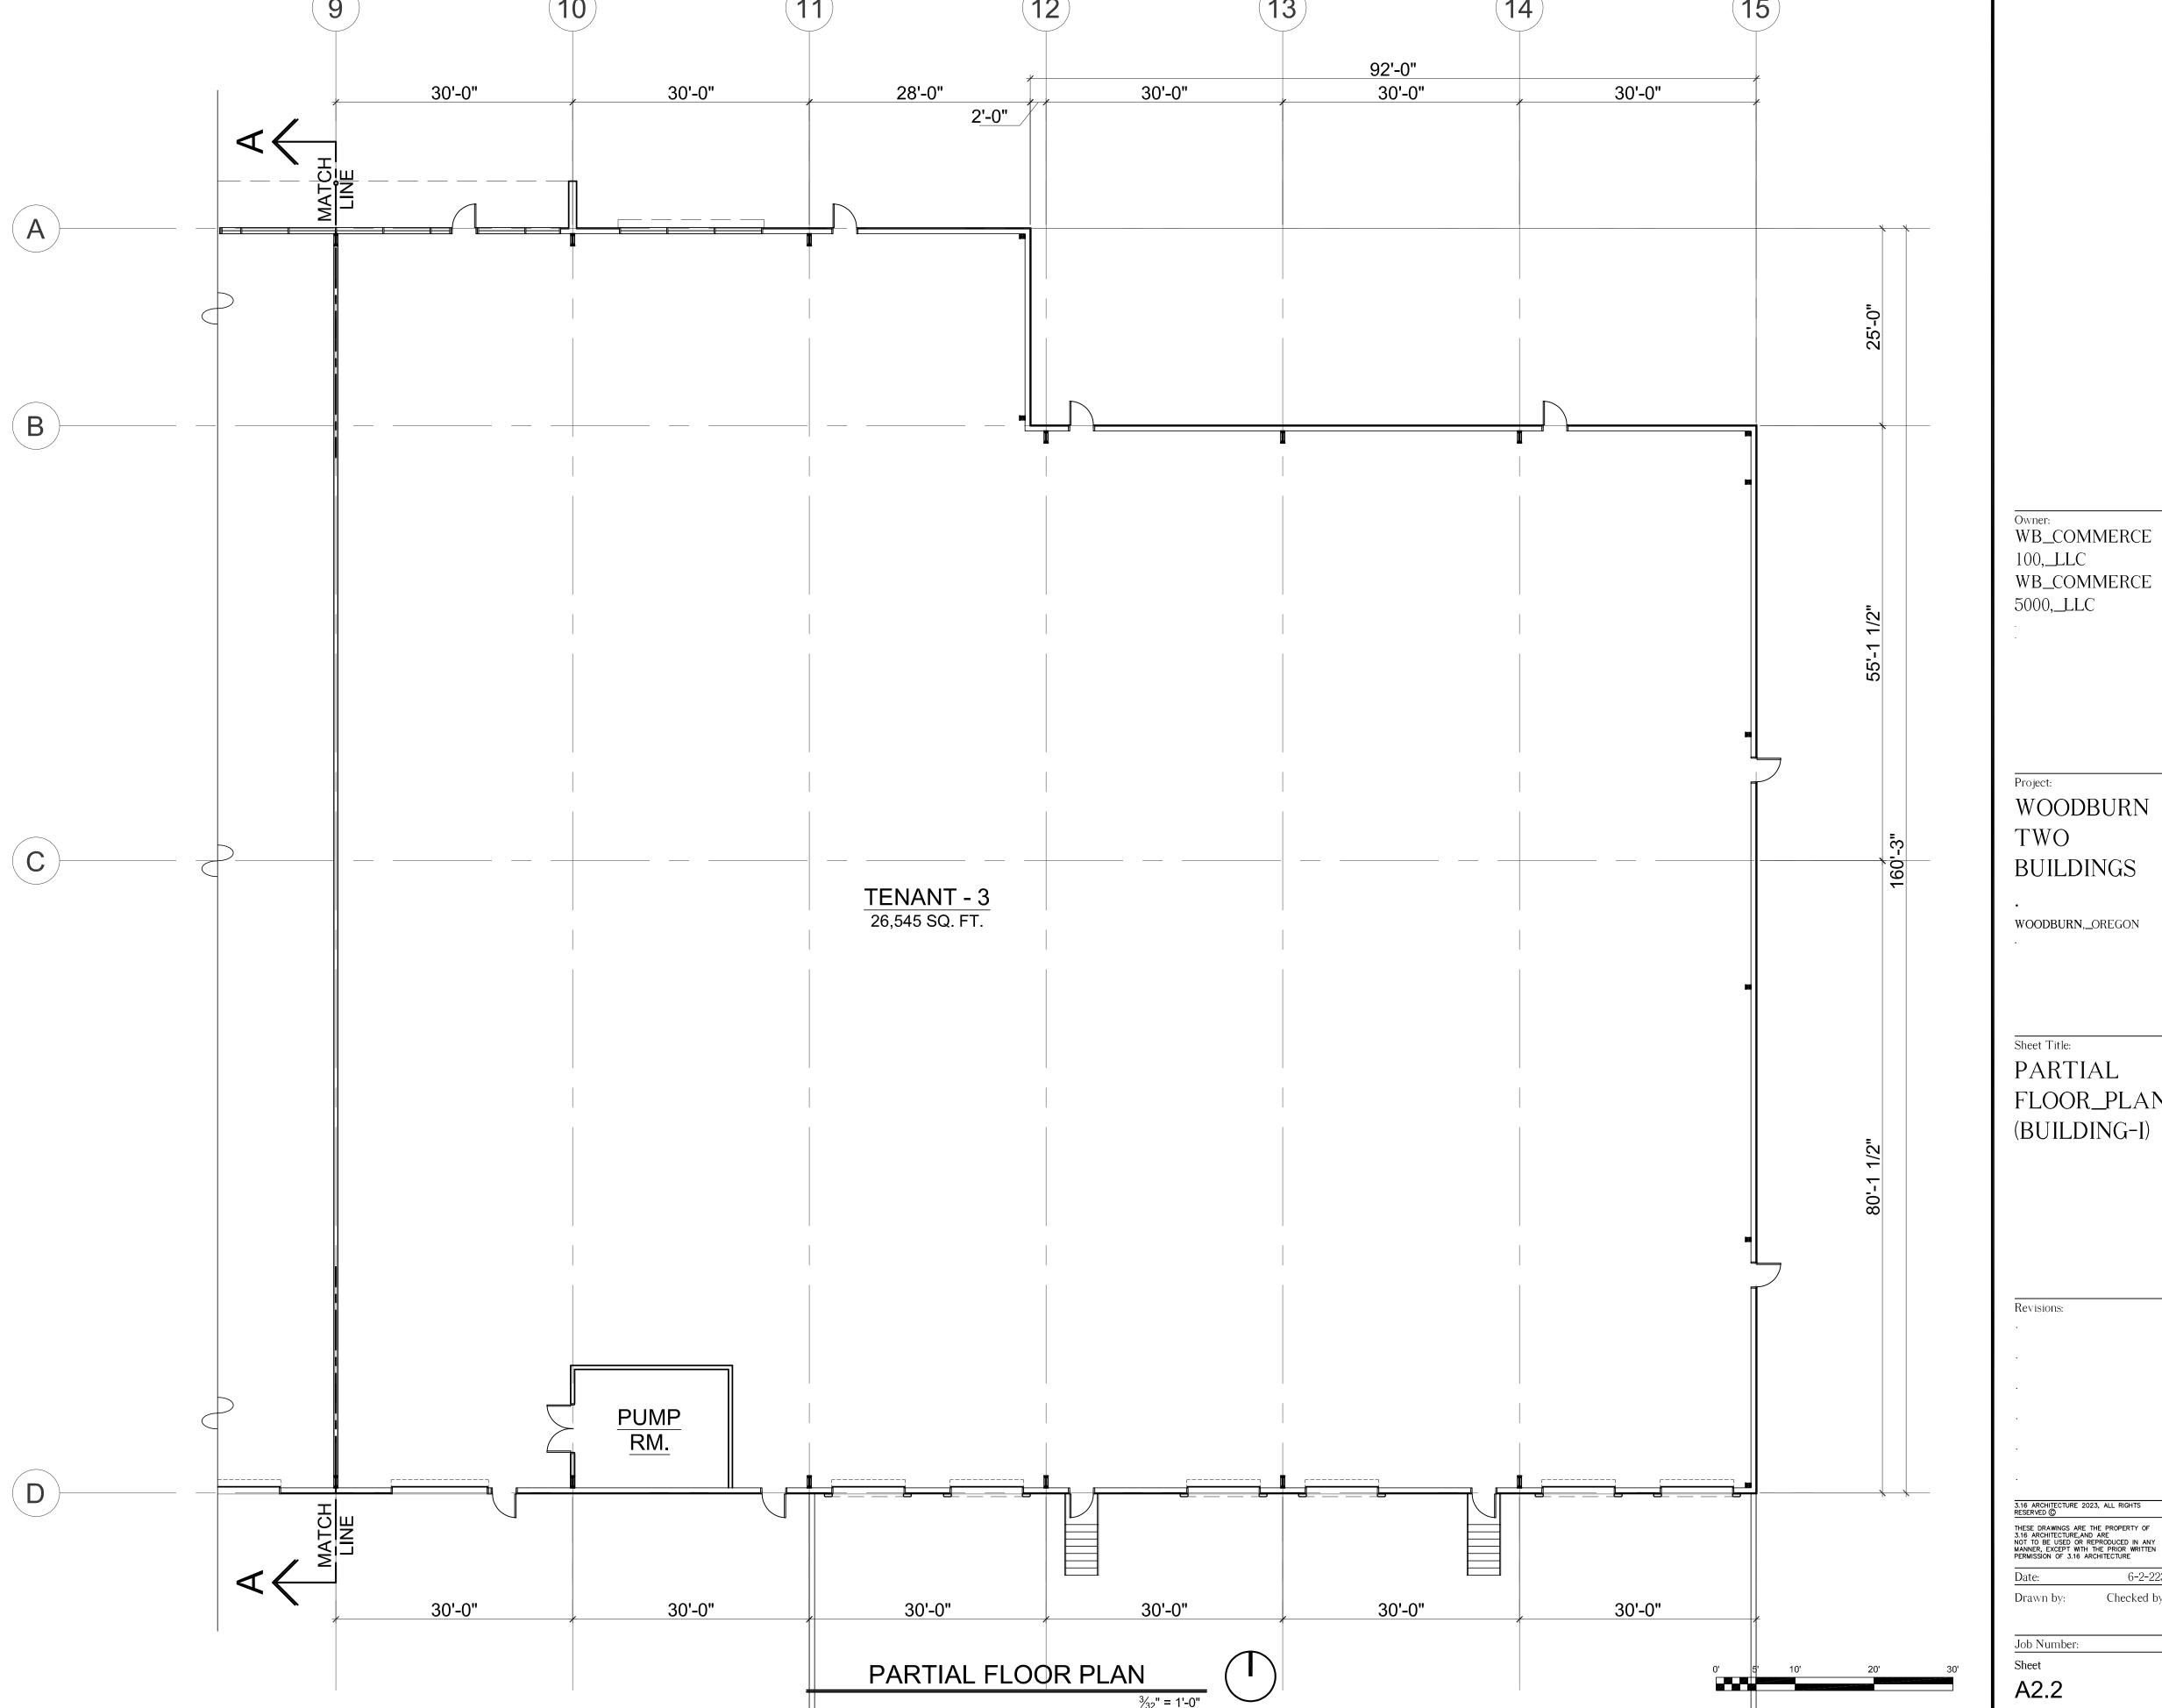

<sup>3</sup>/<sub>32</sub>" = 1'-0"

WB\_COMMERCE


WOODBURN BUILDINGS

FLOOR\_PLAN (BUILDING-I)

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Checked by:



WB\_COMMERCE

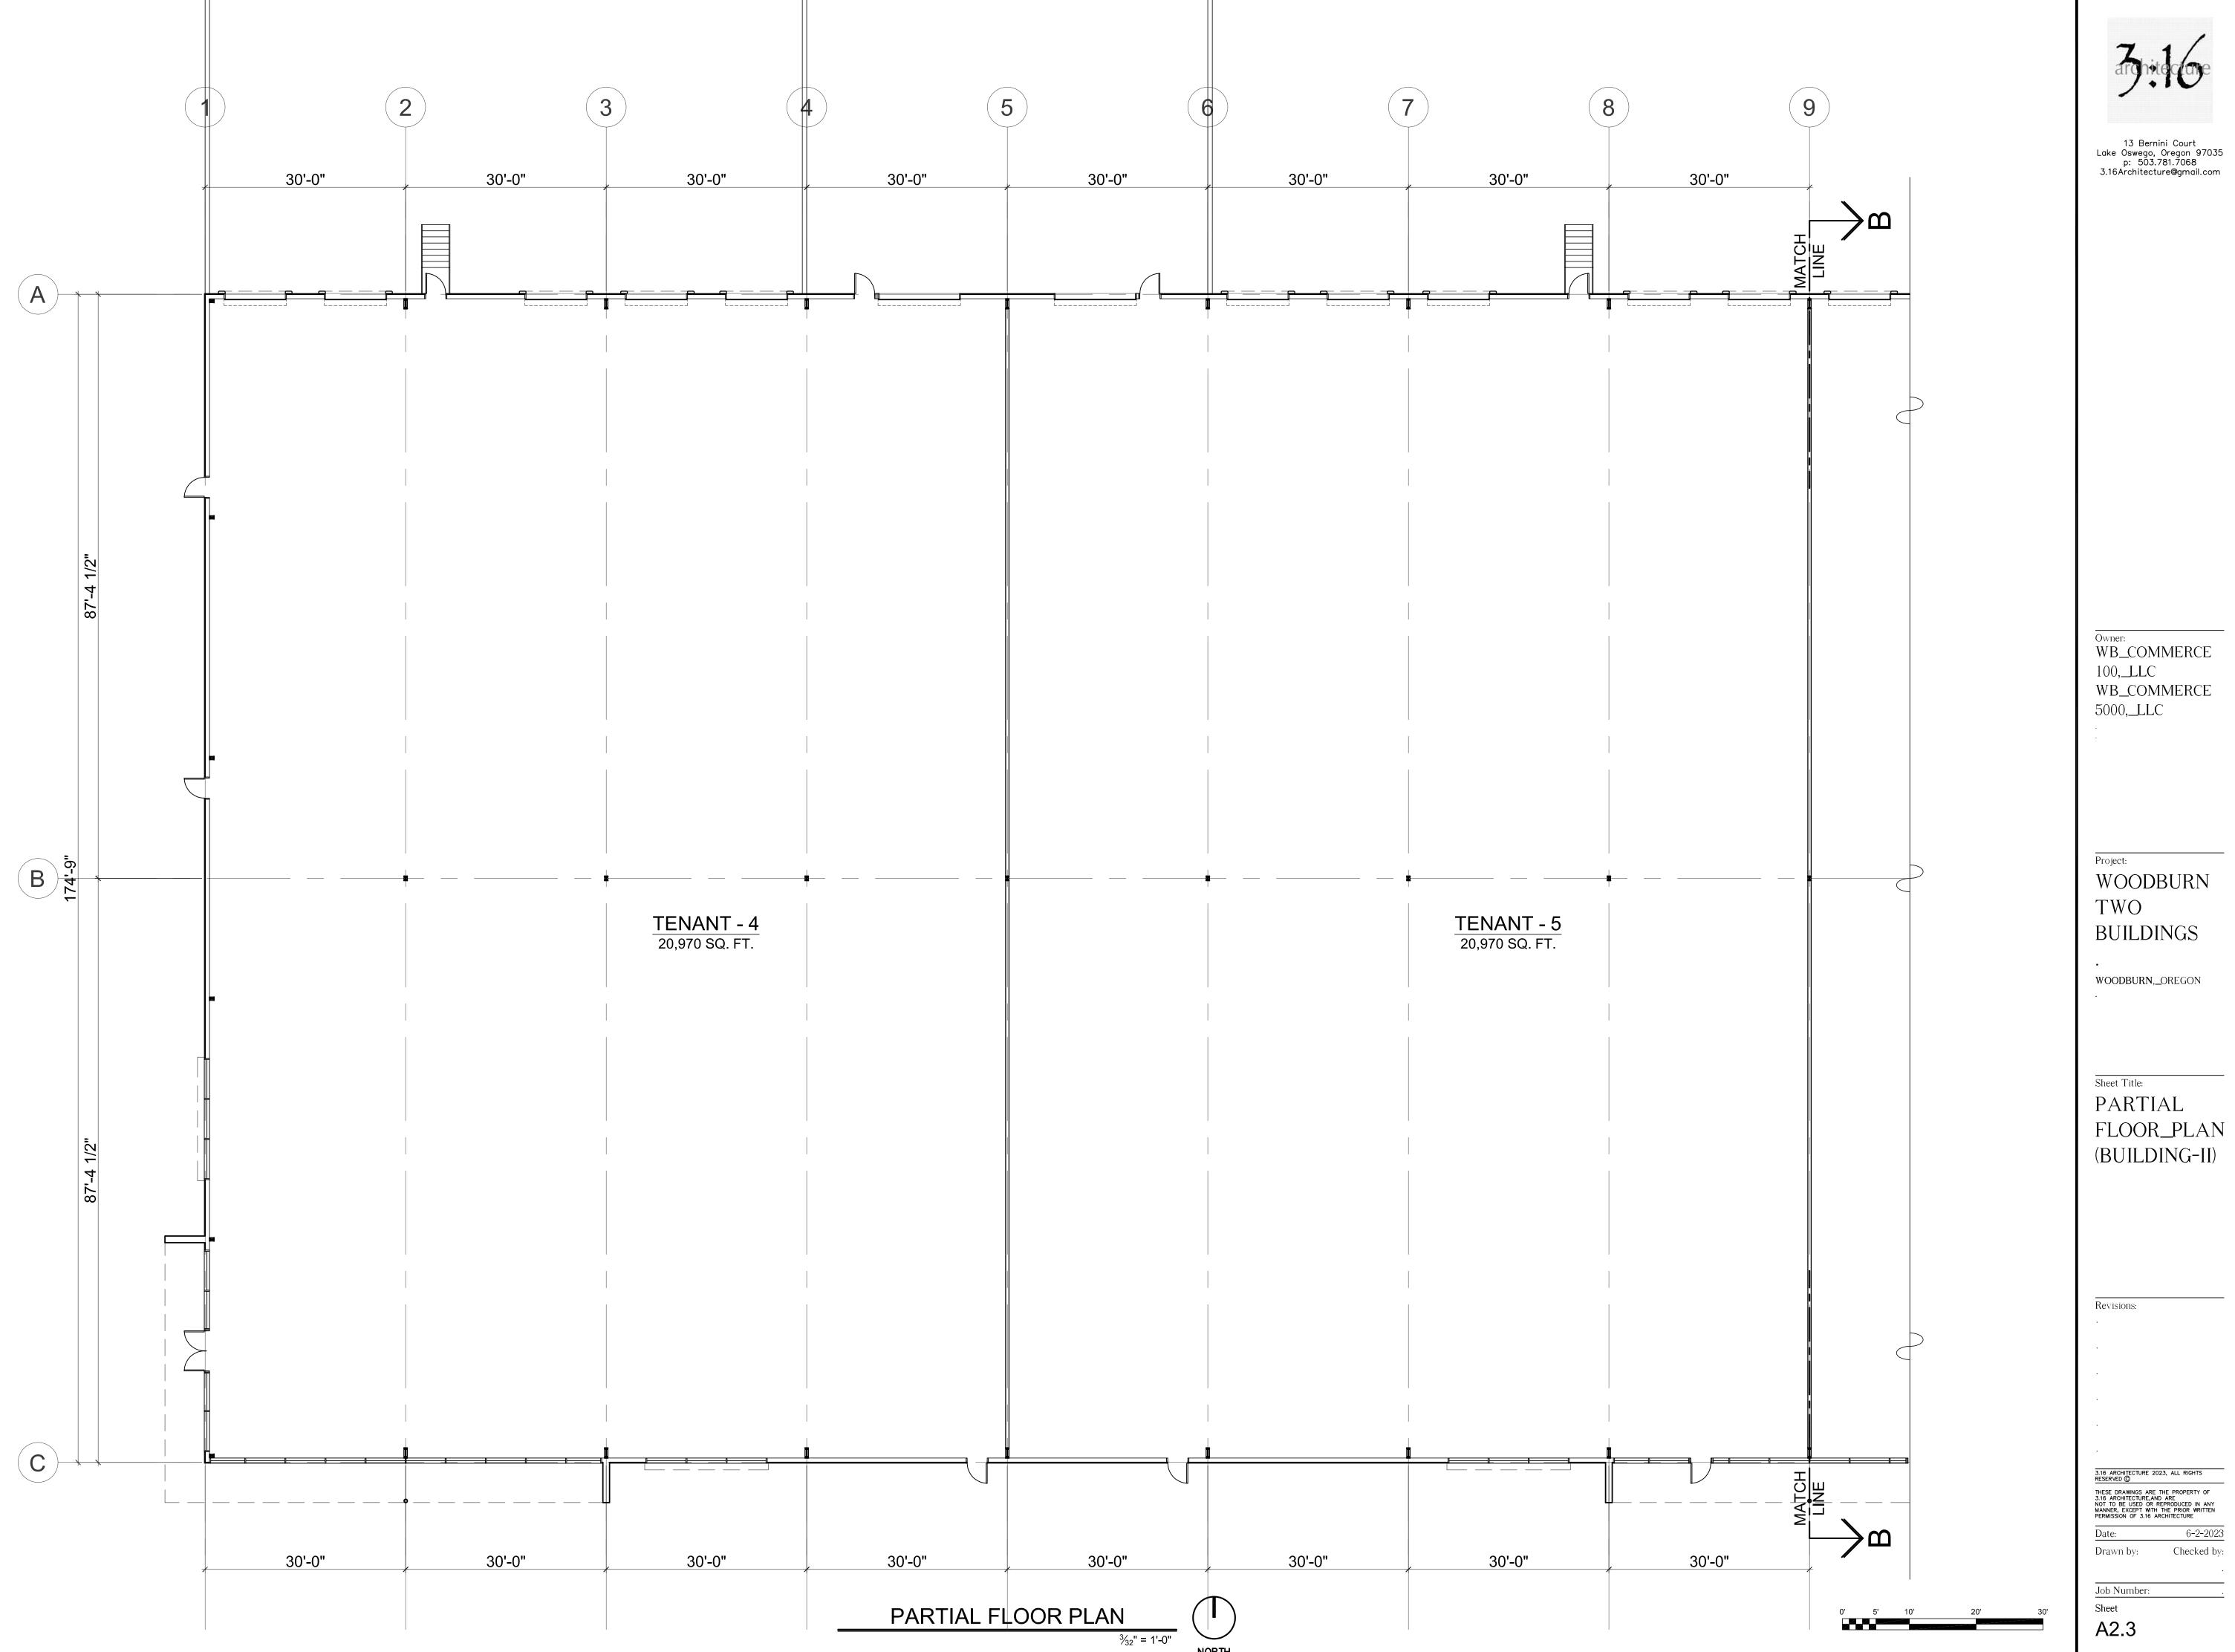WOODBURN BUILDINGS


WOODBURN,\_OREGON

FLOOR\_PLAN

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Checked by:




FLOOR\_PLAN

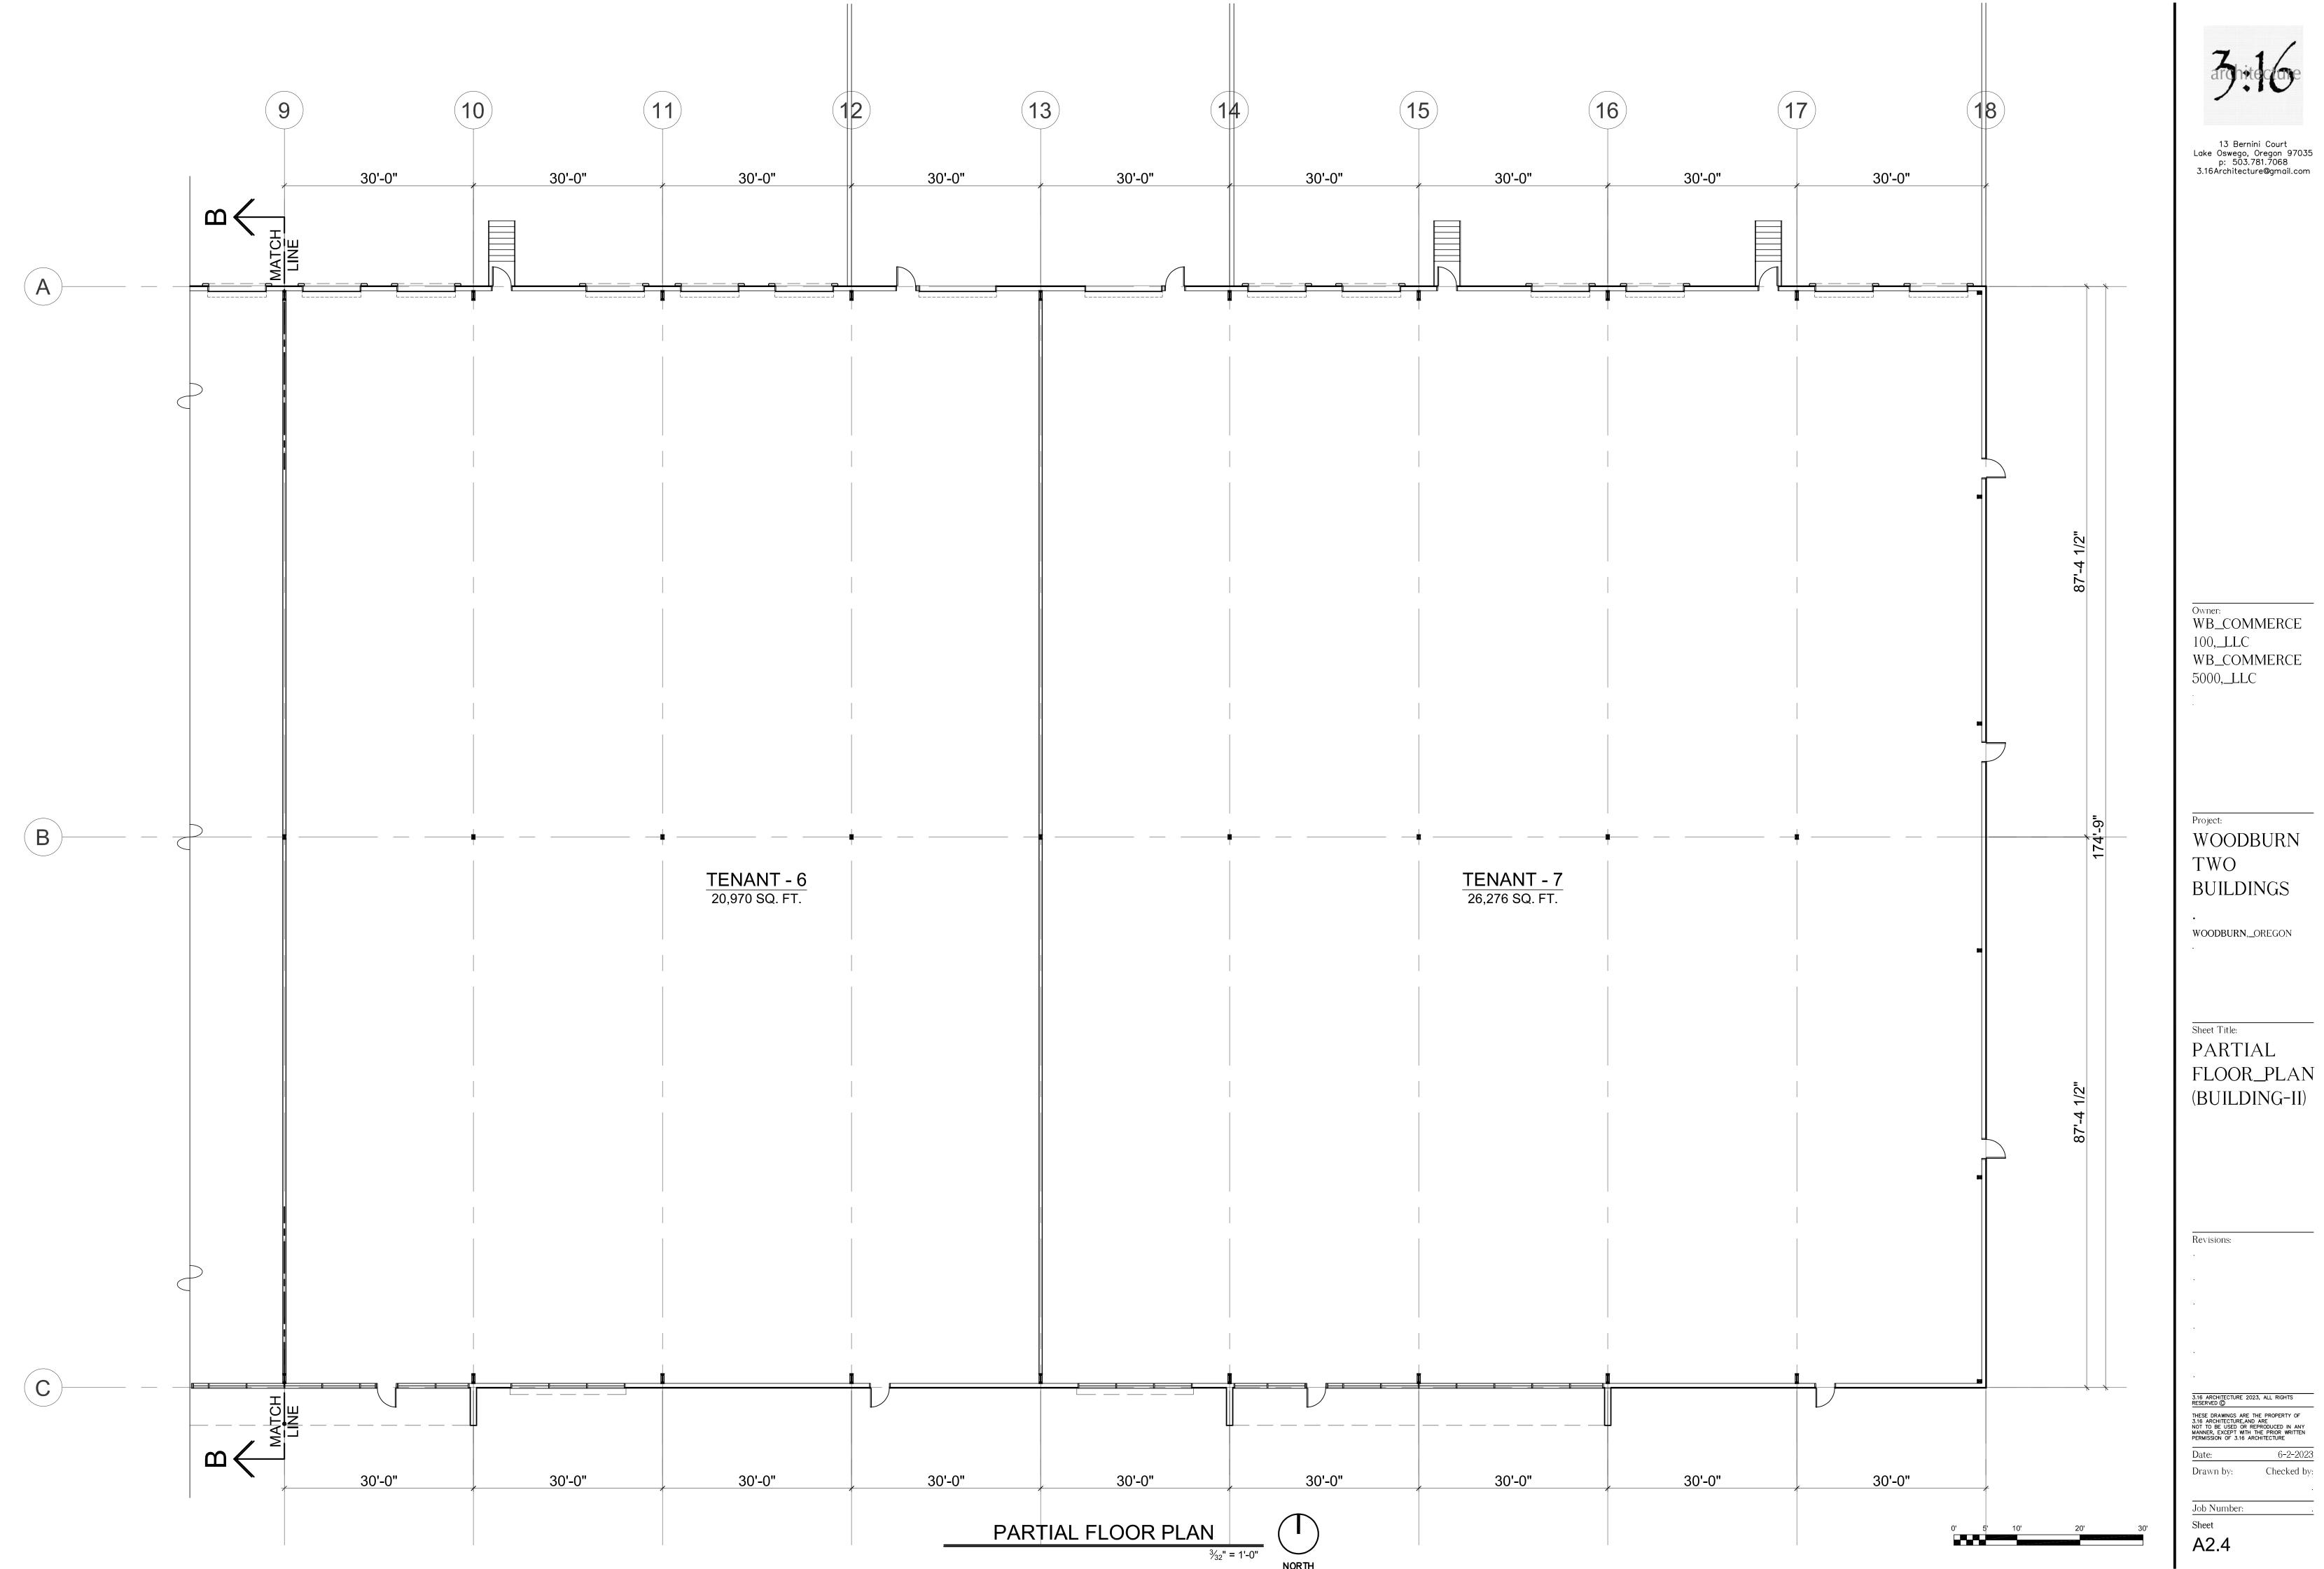
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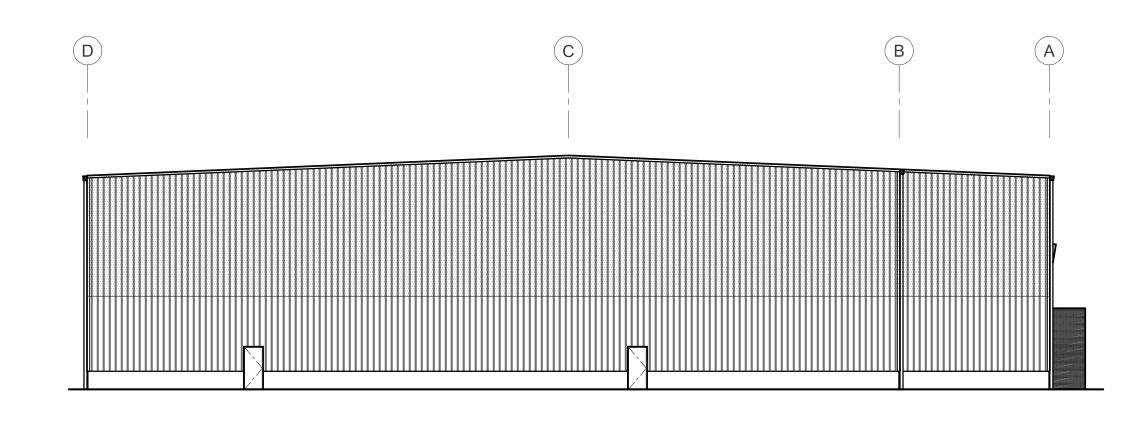
KEY NOTES:

1. RED METAL CANOPY 2. BLACK ANODIZED STOREFRONT 3. DARK GRAY METAL PANEL 4. LIGHT GRAY METAL PANEL 5. LIGHT GRAY PAINTED CONCRETE WAINSCOT 6. DARK GRAY METAL ROOF 7. DOCK SEAL & BUMPER8. DARK GRAY PAINTED DRIVE-IN DOOR 9. DARK GRAY PAINTED DOCK HIGH DOOR 10. RED GUTTER

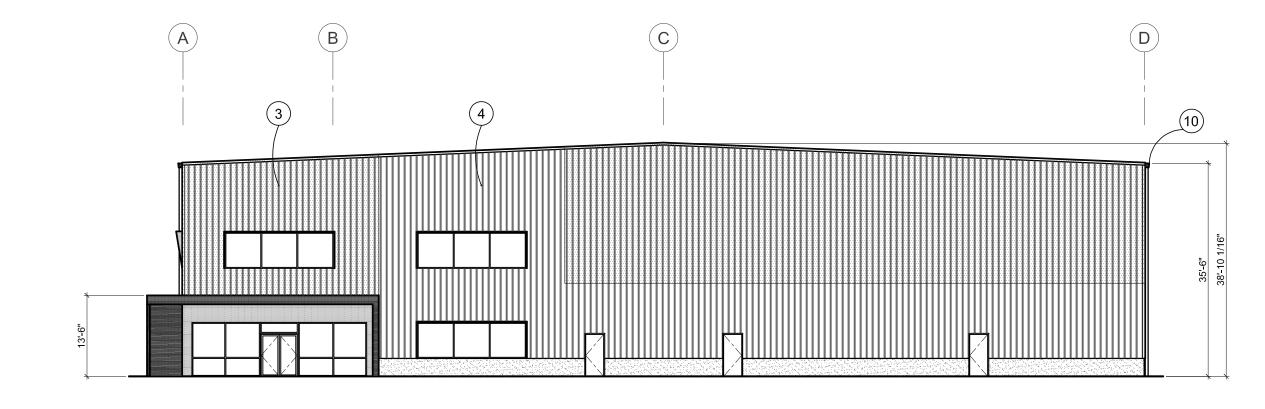


## **BUILDING-I WEST ELEVATION**



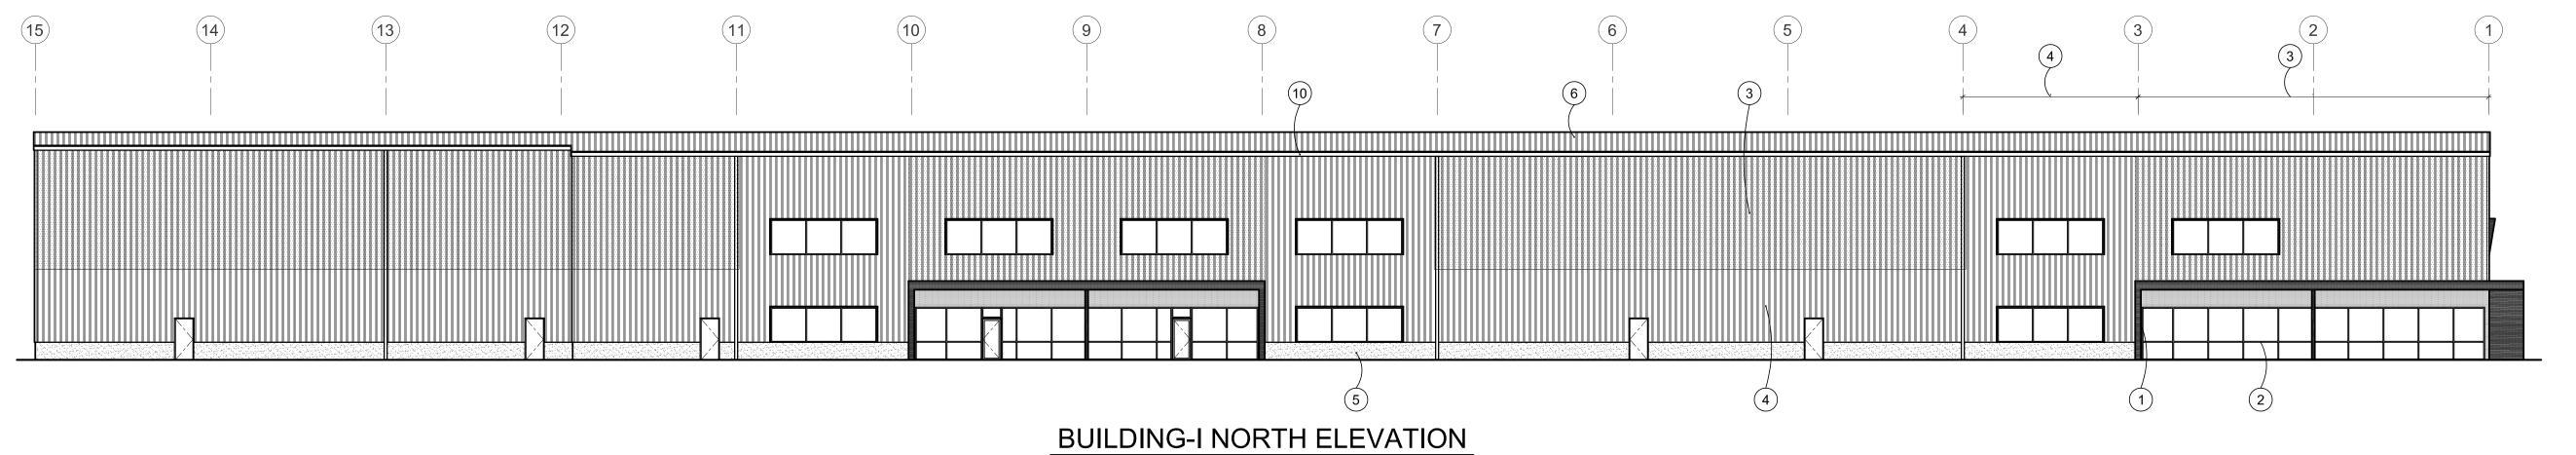

## **BUILDING-I EAST ELEVATION**

½16" = 1'-0"

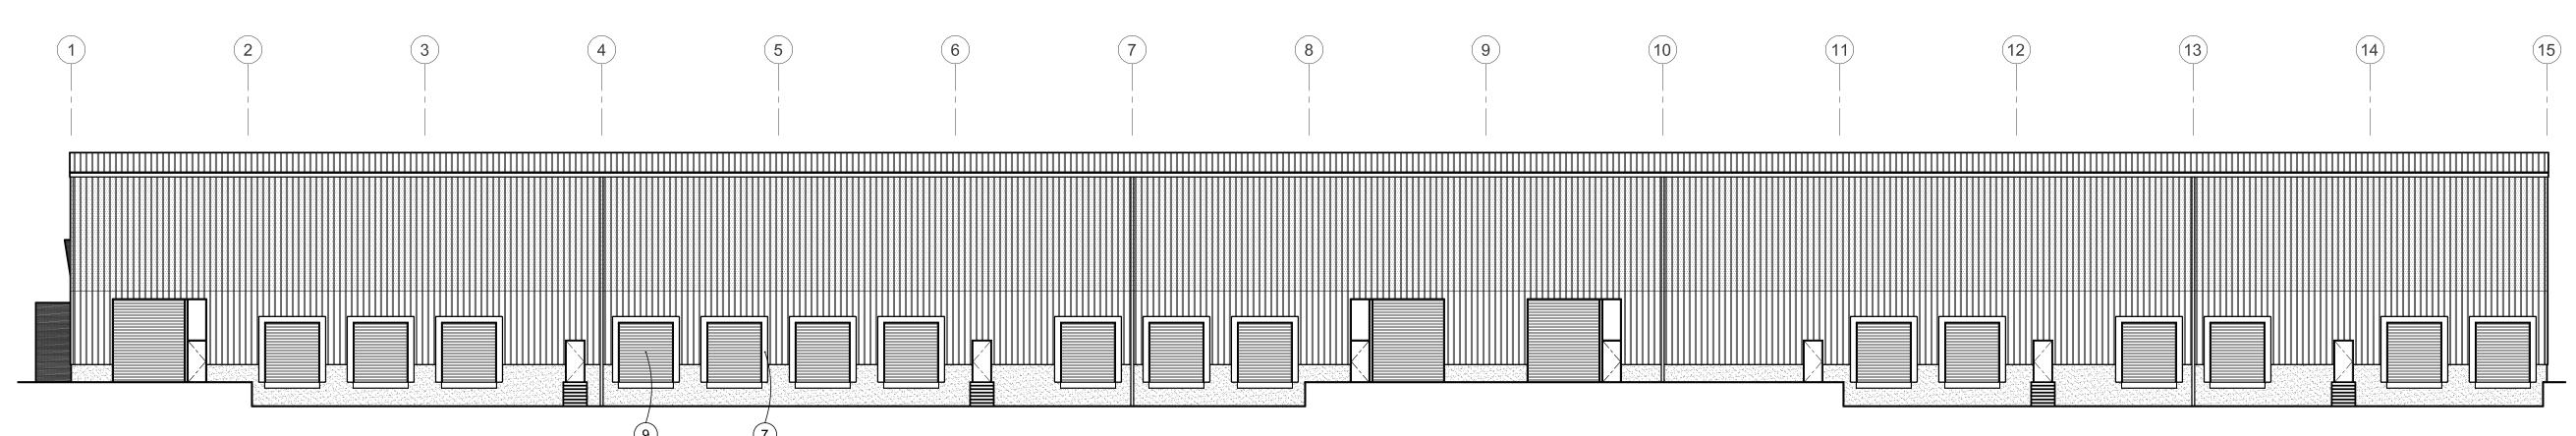

BUILDING-I SOUTH ELEVATION

1/16" = 1'-0"

A3.1

13 Bernini Court Lake Oswego, Oregon 97035 p: 503.781.7068 3.16Architecture@gmail.com

Owner: WB\_COMMERCE 100,\_LLC WB\_COMMERCE 5000,\_\_LLC

WOODBURN TWO BUILDINGS

WOODBURN,\_OREGON


Sheet Title: **EXTERIOR** 

ELEVATIONS (BUILDING-I)


Checked by: Drawn by:

Job Number: Sheet

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## **BUILDING-II WEST ELEVATION** ½<sub>16</sub>" = 1'-0"

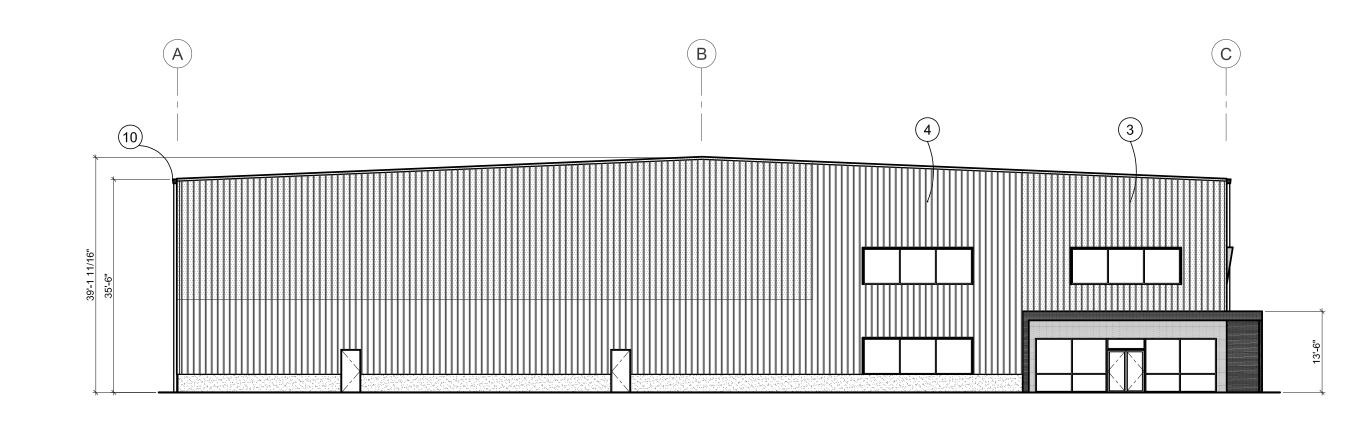

KEY NOTES:

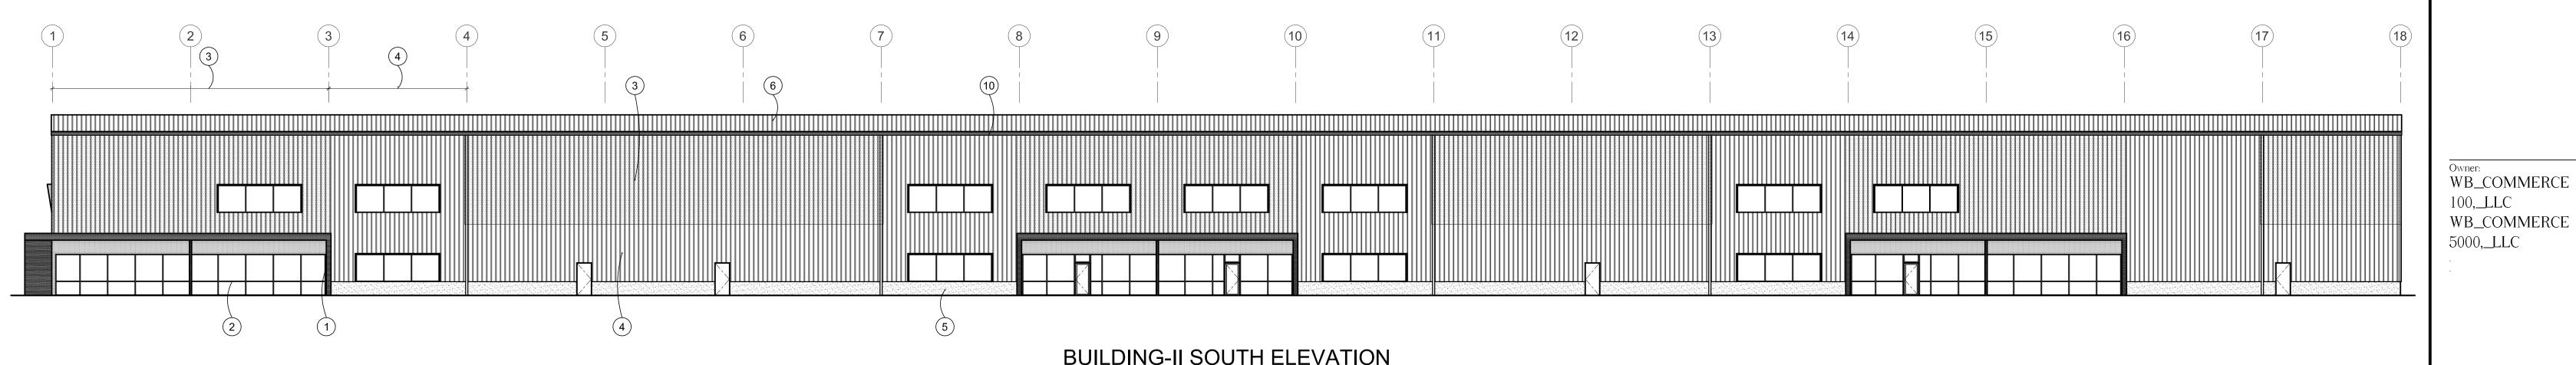1. RED METAL CANOPY

3. DARK GRAY METAL PANEL

4. LIGHT GRAY METAL PANEL

6. DARK GRAY METAL ROOF 7. DOCK SEAL & BUMPER


10. RED GUTTER

2. BLACK ANODIZED STOREFRONT

5. LIGHT GRAY PAINTED CONCRETE WAINSCOT

8. DARK GRAY PAINTED DRIVE-IN DOOR 9. DARK GRAY PAINTED DOCK HIGH DOOR

## **BUILDING-II SOUTH ELEVATION**

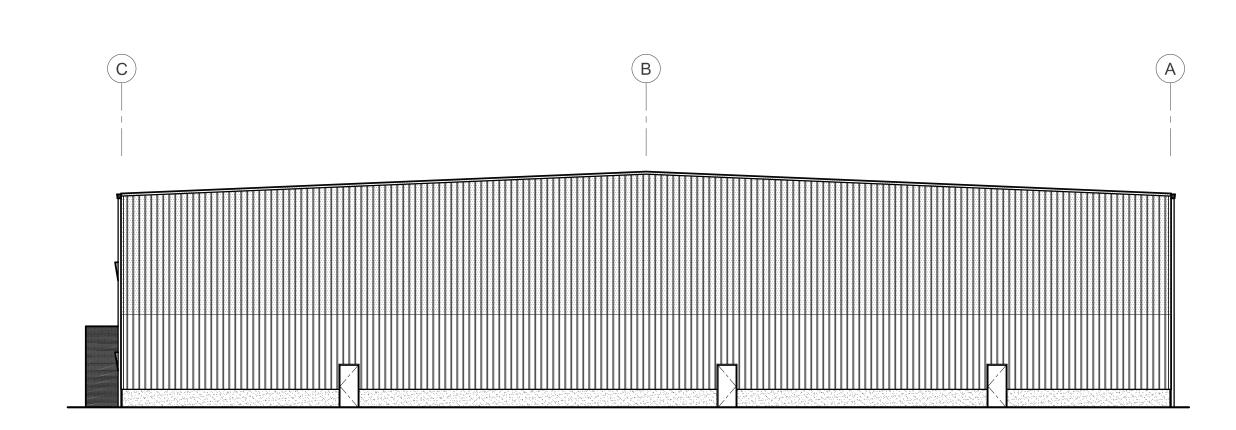

## BUILDING-II EAST ELEVATION

**BUILDING-II NORTH ELEVATION** 

WOODBURN

TWO BUILDINGS

WOODBURN,\_OREGON


Sheet Title: EXTERIOR ELEVATIONS (BUILDING-II)

Job Number: Sheet

Drawn by:


KEY NOTES:


1. COBALT BLUE METAL CANOPY
2. BLACK ANODIZED STOREFRONT
3. DARK GRAY METAL PANEL
4. LIGHT GRAY METAL PANEL
5. LIGHT GRAY PAINTED CONCRETE WAINSCOT
6. DARK GRAY METAL ROOF
7. DOCK SEAL & BUMPER
8. DARK GRAY PAINTED DRIVE-IN DOOR
9. DARK GRAY PAINTED DOCK HIGH DOOR
10. COBALT BLUE GUTTER

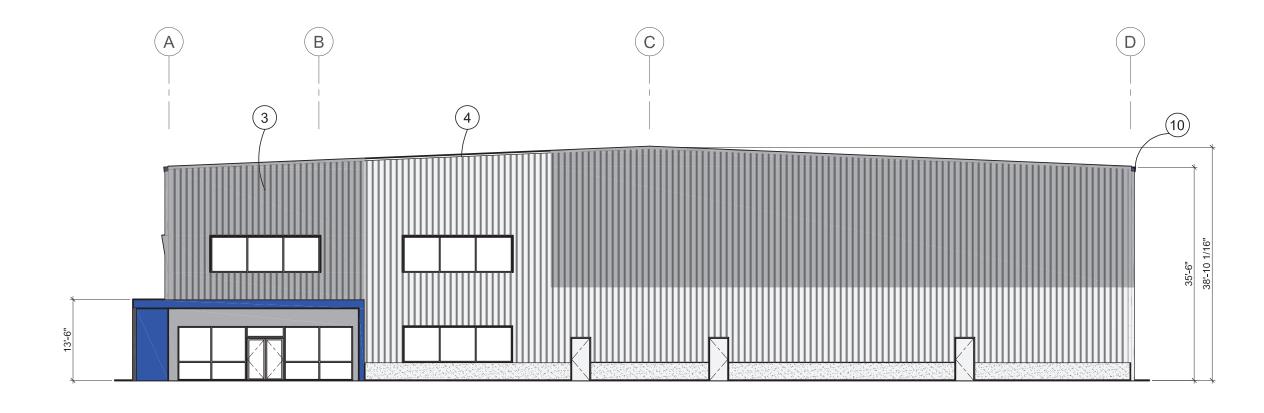

## BUILDING-I WEST ELEVATION


½<sub>16</sub>" = 1'-0"

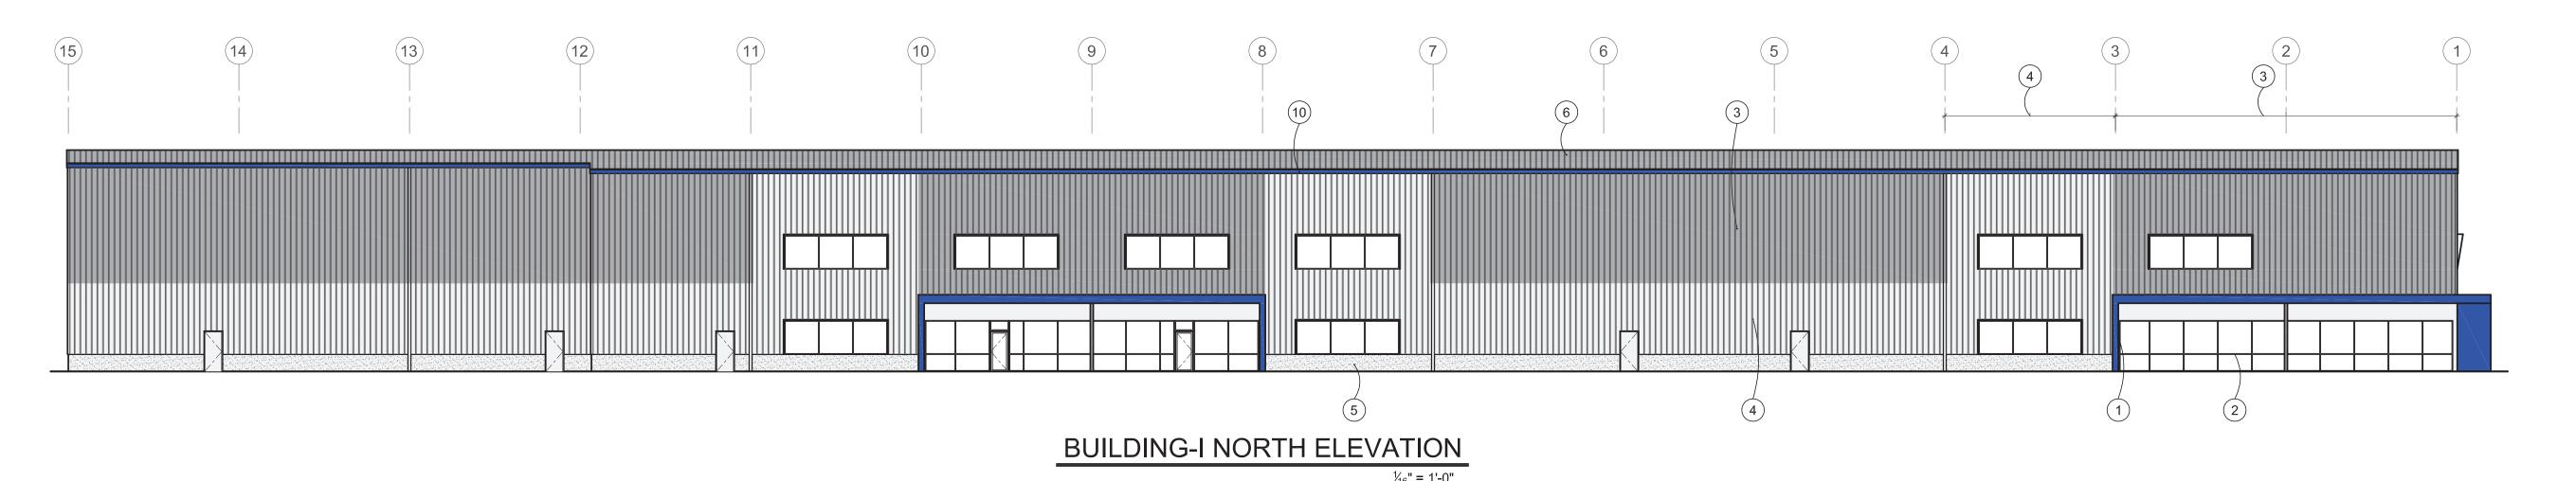

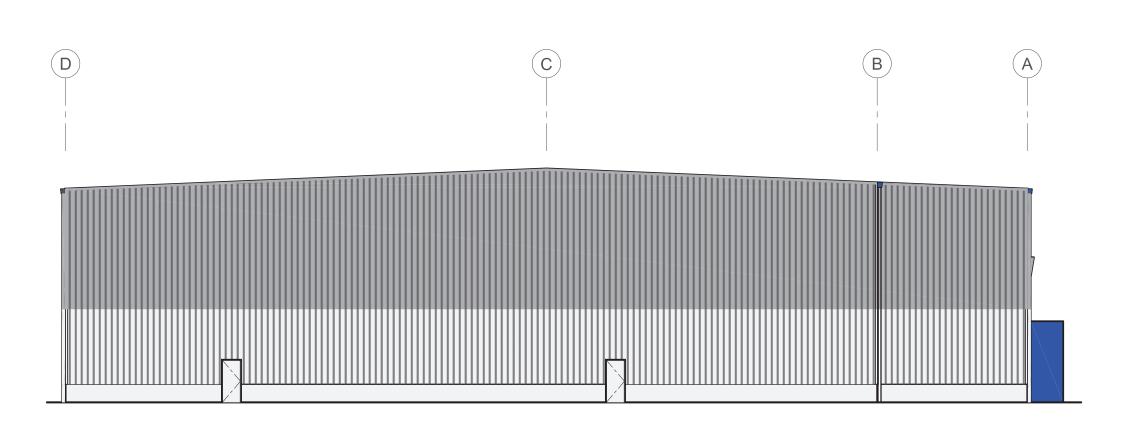

## BUILDING-I EAST ELEVATION

½<sub>16</sub>" = 1'-0"

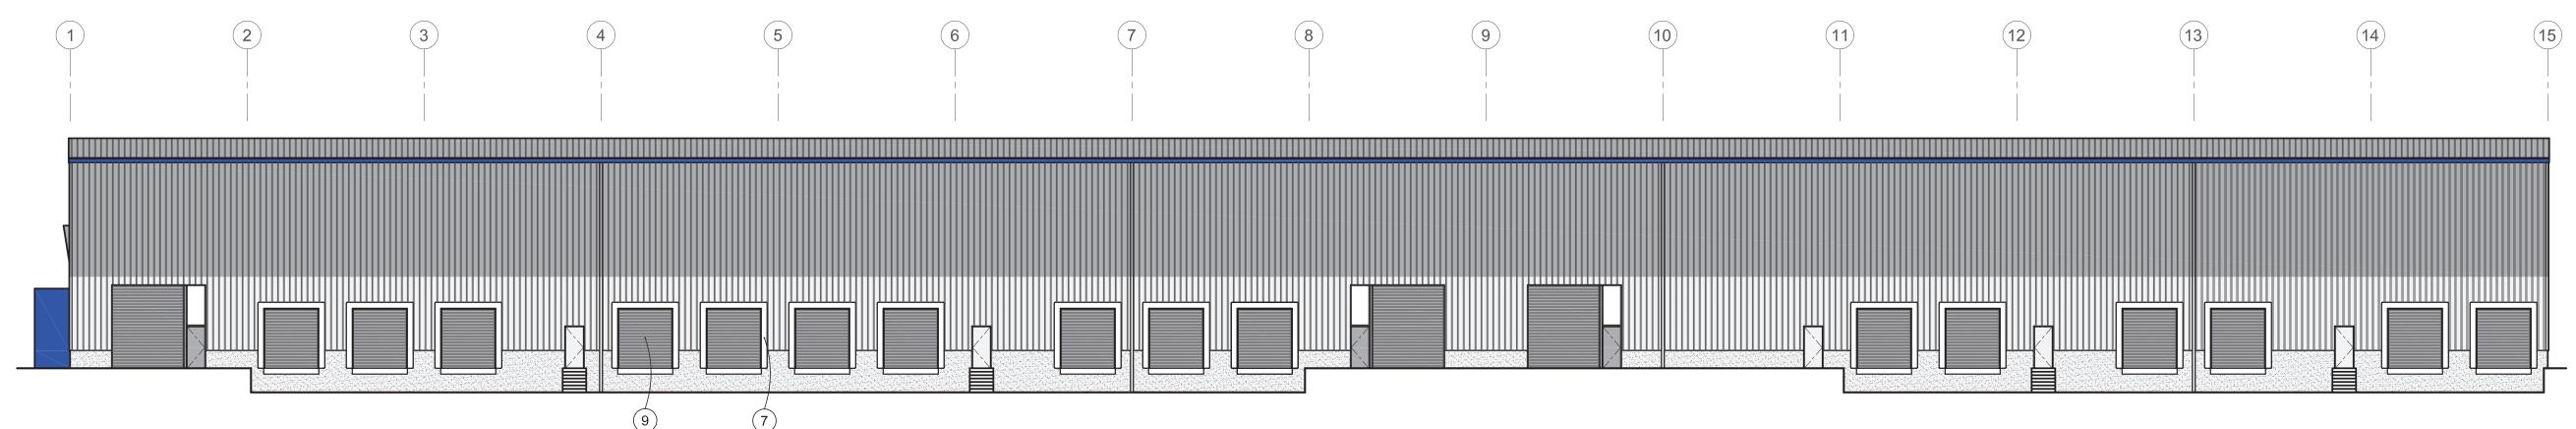

**BUILDING-I SOUTH ELEVATION** 

0' 5' 10' 20'

A3.1

Drawn by:

arghitector

13 Bernini Court Lake Oswego, Oregon 97035 p: 503.781.7068 3.16Architecture@gmail.com

WB\_COMMERCE 100,\_LLC WB\_COMMERCE 5000,\_LLC

Project:
WOODBURN
TWO
BUILDINGS

WOODBURN,\_OREGON

Sheet Title:

EXTERIOR

ELEVATIONS (BUILDING-I)

Revisions:

PERMISSION OF 3.16 ARCHITECTURE

Date: 8-22-2

Checked by:

Job Number:
Sheet

**KEY NOTES:** 1. COBALT BLUE METAL CANOPY 2. BLACK ANODIZED STOREFRONT 3. DARK GRAY METAL PANEL 13 Bernini Court Lake Oswego, Oregon 97035 p: 503.781.7068 3.16Architecture@gmail.com 4. LIGHT GRAY METAL PANEL 5. LIGHT GRAY PAINTED CONCRETE WAINSCOT 6. DARK GRAY METAL ROOF 7. DOCK SEAL & BUMPER 8. DARK GRAY PAINTED DRIVE-IN DOOR 9. DARK GRAY PAINTED DOCK HIGH DOOR 10. COBALT BLUE GUTTER **BUILDING-II WEST ELEVATION** ½<sub>16</sub>" = 1'-0" Owner: WB\_COMMERCE 100,\_LLC WB\_COMMERCE 5000,\_LLC **BUILDING-II SOUTH ELEVATION** TWO BUILDINGS WOODBURN,\_OREGON Sheet Title: EXTERIOR BUILDING-II EAST ELEVATION Job Number: Sheet **BUILDING-II NORTH ELEVATION** 

WOODBURN

ELEVATIONS (BUILDING-II)







Optional VC Lens and Uplight Skirt Preserve night skies and enhance visual comfort with optional uplight skirt and prismatic glass refractor

TYPE C: cutoff skirt for Dark Sky Compliance





TYPE D: Full Cutoff Wallpack

1. Readings shown are based on a total LLF of as shown at grade. Data the extrapolated performance projections in a 25c ambient based on 10,000 hrs

LED testing (per IESNA LM-80-08 and projected per IESNA TM-21-11). 2. Please refer to thelight fixture symbol for mounting heights. 3. Product information can be obtained at www.Acuity Brands.com

Statistics					
Description	Symbol	Avg	Max	Min	Max/Min
Building Perimeter 1	Ж	0.7 f	3.8 fc	0.1 fc	15.2:1
Building Perimeter 2	Ж	0.6 f	3.6 fc	0.1 fc	16.6:1
Parking Area 1	Ж	1.0 fc	2.6 fc	0.1 fc	16.0:1
Parking Area 2	Ж	1.0 fc	2.9 fc	0.1 fc	14.3:1
Spill Light Summary	+	0.0 fc	0.0 fc	0.0 fc	N/A

Schedule									
Symbol	Label	QTY	Catalog Number	Description		Lumens per Lamp	LLF	Wattage	Polar Plot
$\hat{\Box}$	D	15	HLWPC2 P40 40K XX T4M	Wallpack Full Cutoff LED, LED Performance Package P10, 4000 series CCT, Voltage, Type IV Medium	1	9882	0.9	95	Max: 7420cd
	С	7	MGLEDM P5 40K XXXXX WR	Mongoose Medium, P5 Performance Package, 4000K, Wide Roadway	1	30309	0.9	206.21	Max: 17338cd

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| 0.0 | 0.0 | 0.0 

4.5 2.4

**D-5** @ .8' | 0.1 | 0.0 | 0.0 
This application design is not a professional engineering drawing and the design, including reported data and calulated results, is provided for informational purposes only, without any warrenty as to accuracy, completeness, safety or otherwise. The design is the result of calculations made using Visual lighting application software, photometric/radiometric data measured in a labrarory, and certian computational and modeling assumptions. Far-field photometric/radiometric data may have been used to perform one or more calculations. Photometric/radiometric data is typically collected under far-field performance. These assumptions may result in significant inaccuracies in individual calculated luminous and/or radiant power quantities in areas where a source is in close proximity to a particular surface or pont.

The modeling of radiant flux exchange used in the Visual software requires a uniform exitance gradiant. Practical restrictions, due to computer hardware limitations, may prevent the subdivision procedure from subdividing surfaces with high exitance gradients into subsurfaces with sufficiently uniform exitance gradients, introducing potential discretization error into the calculated values.

Calulations performed by Visual softwarw assume that all reflected flux is reflected in a perfectly diffuse (Lambertian) and spectrally uniform manner accross the spectral range being analyzed. If actual reflected in a perfectly diffuse (Lambertian) and spectrally uniform manner accross the spectral range being analyzed. If actual reflected in a perfectly diffuse (Lambertian) and spectrally uniform manner accross the spectral range being analyzed. If actual reflected flux is reflected in a perfectly diffuse (Lambertian) and spectral range being analyzed. If actual reflected flux is As a result of the computional limitations and simplifying modeling assumptions described above, and/or variations in actual product performance from tested product samples, the accuracy of calculated outut values identifying expected.

It is the obligation of the end-user to consult with appropriately qualified Proffesional Engineer (s) to determine whether this application design meets the application. In no event will Acuity Brands Lighting be responsible for any loss resulting from any use of this design.

In addition, the accuracy of the application design may be adversely affected if information about the physical space provided to Acuity Brands Lighting is incomplete, inaccurate, outdated or not in the required format (includiing but not limited to floor plans, space layout, reflected ceiling plans, space layout, reflected ceiling plans, physical structures, electrical design or specifications) if incomplete, inaccurate, outdated or not in the required format (includiing but not limited to floor plans, space layout, reflected ceiling plans, physical structures, electrical design or specifications) if incomplete, inaccurate, outdated or not in the required format (includiing but not limited to floor plans, space layout, reflected ceiling plans, physical structures, electrical design or specifications) if incomplete, inaccurate, outdated or not in the required format (includiing but not limited to floor plans, space layout, reflected ceiling plans, physical structures, electrical design or specifications. field performance may differ from performance calculated using laboratory measurement as a result in performance over time that differs performance calculated using a new lamp. Light loss factors may have been used in the application, but flaws in these estimates may also result in performance over time that differ from the calculated performance.

8/8/2023 Scale As Shown Drawing No. 228628-5 A1 Summary

R.A. MCILRATH

Date