

LANDSCAPE PLANTING LEGEND

BOTANICAL NAME / COMMON NAME

E=169.01 FVL 13 N IE=169.11 CMP 24" W IE=169.06

DRAINAGE DITCH

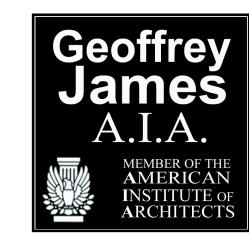
SSMH [RIM 182.58] PVC 8" N IE=168.34 PVC 10" E IE=168.24 PVC 10" W IE=168.14

CB [RIM 181.63]
DIP 15" E IE=177.03
RCP 12" W IE=177.72

CONTAINER SIZE SPACING QTY P.U.'S

[℃]182.63

| | BOTANICAL NAME / COMMON NAME | CONTAINER | SIZE | SPACING | QTY | P.U.'S |
|--|---|-----------------------------|-------------------|--------------------|----------------------------|-------------------------|
| | Pyrus calleryana "Glen's Form" TM / Calley Pear | | 1.5" cal. | 40" o.c. | 13 | 26 |
| TREES | BOTANICAL NAME / COMMON NAME | CONTAINER | SIZE | SPACING | QTY | P.U.'S |
| Manufacture of the second of t | Ginkgo biloba Presidential Gold / Presidential Gold Ginkgo | | 1.5" cal. | as shown | 1 | 2 |
| | Sequoiadendron giganteum / Giant Sequoia | | 1.5" cal. | as shown | | |
| 2 · R | Betula Nigra "Heritage" / Heritage Birch | | 1.5" cal. | as shown | | |
| | Thuja plicata / Western Red Cedar | B & B | 5' - 6' | as shown | | |
| | Acer Rubrum "Armstrong" Armstrong Red Maple | B & B | 5' - 6' | as shown | 10 | 20 |
| SHRUBS | BOTANICAL NAME / COMMON NAME | CONTAINER | SIZE | SPACING | QTY | P.U.'S |
| \otimes | Viburnum davida / David Viburnum | 2 gal | 15" - 18" | 3' o.c. | 25 | 25 |
| | Polystichum munitum / Western Sword Fern | | | as shown | | |
| | Calamagrostis x acutiflora "Avalanche / Feather Reed Grass | 1 gal | 15" - 18" | 3' o.c. | | |
| | Calamagrostis x acutiflora "Avalanche / | 1 gal | 10" - 15" | 4' o.c. | | |
| | Feather Reed Grass | | | | | |
| GROUND COVER | | CONTAINER | | SPACING | QTY | P.U.'S |
| GROUND COVER | | CONTAINER | | SPACING 3' o.c. | QTY 3015 | P.U.'S 75 |
| GROUND COVER SOD / SEED | BOTANICAL NAME / COMMON NAME Cotoneaster dammen / Bearberry Coloneaster | CONTAINER | SIZE 10" - 12" | | | |
| | BOTANICAL NAME / COMMON NAME Cotoneaster dammen / Bearberry Coloneaster | CONTAINER 1 gal | 10" - 12" | 3' o.c. | 3015 | 75 P.U.'S 100 |
| | BOTANICAL NAME / COMMON NAME Cotoneaster dammen / Bearberry Coloneaster BOTANICAL NAME / COMMON NAME Native seed mix / Butterfly Flower Mix Short Forbs & Grass Propriety seed blend by Heritage Seedlings and Liners, Inc. 503-585-9835 | CONTAINER 1 gal | 10" - 12" | 3' o.c. | 3015 QTY | 75 P.U.'S |
| SOD / SEED | BOTANICAL NAME / COMMON NAME Cotoneaster dammen / Bearberry Coloneaster BOTANICAL NAME / COMMON NAME Native seed mix / Butterfly Flower Mix Short Forbs & Grass Propriety seed blend by Heritage Seedlings and Liners, Inc. 503-585-9835 | CONTAINER 1 gal CONTAINER | 10" - 12" | 3' o.c. | 3015 QTY 4020 | 75 P.U.'S 100 |
| SOD / SEED RAIN GARDENS | BOTANICAL NAME / COMMON NAME Cotoneaster dammen / Bearberry Coloneaster BOTANICAL NAME / COMMON NAME Native seed mix / Butterfly Flower Mix Short Forbs & Grass Propriety seed blend by Heritage Seedlings and Liners, Inc. 503-585-9835 BOTANICAL NAME / COMMON NAME Water Quality Rain Gardens & Bioswales | CONTAINER 1 gal CONTAINER | 10" - 12" | 3' o.c. SPACING | 3015 QTY 4020 QTY | 75 P.U.'S 100 P.U.'S 62 |

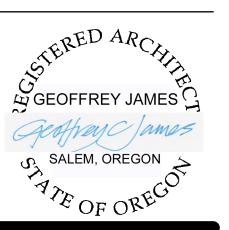


Geoffrey James A.I.A.

A R C H I T E C T

Architecture & Planning

TELEPHONE: 503-931-4120 gjamesarchitect@gmail.com



OWNER:
CHECKPOINT 217

CONTRACTOR

Scott Martin Construction LLC

Checkpoint 211 FOOD PAVILION

WOODBURN

2010 MOLALLA RD WOODBURN

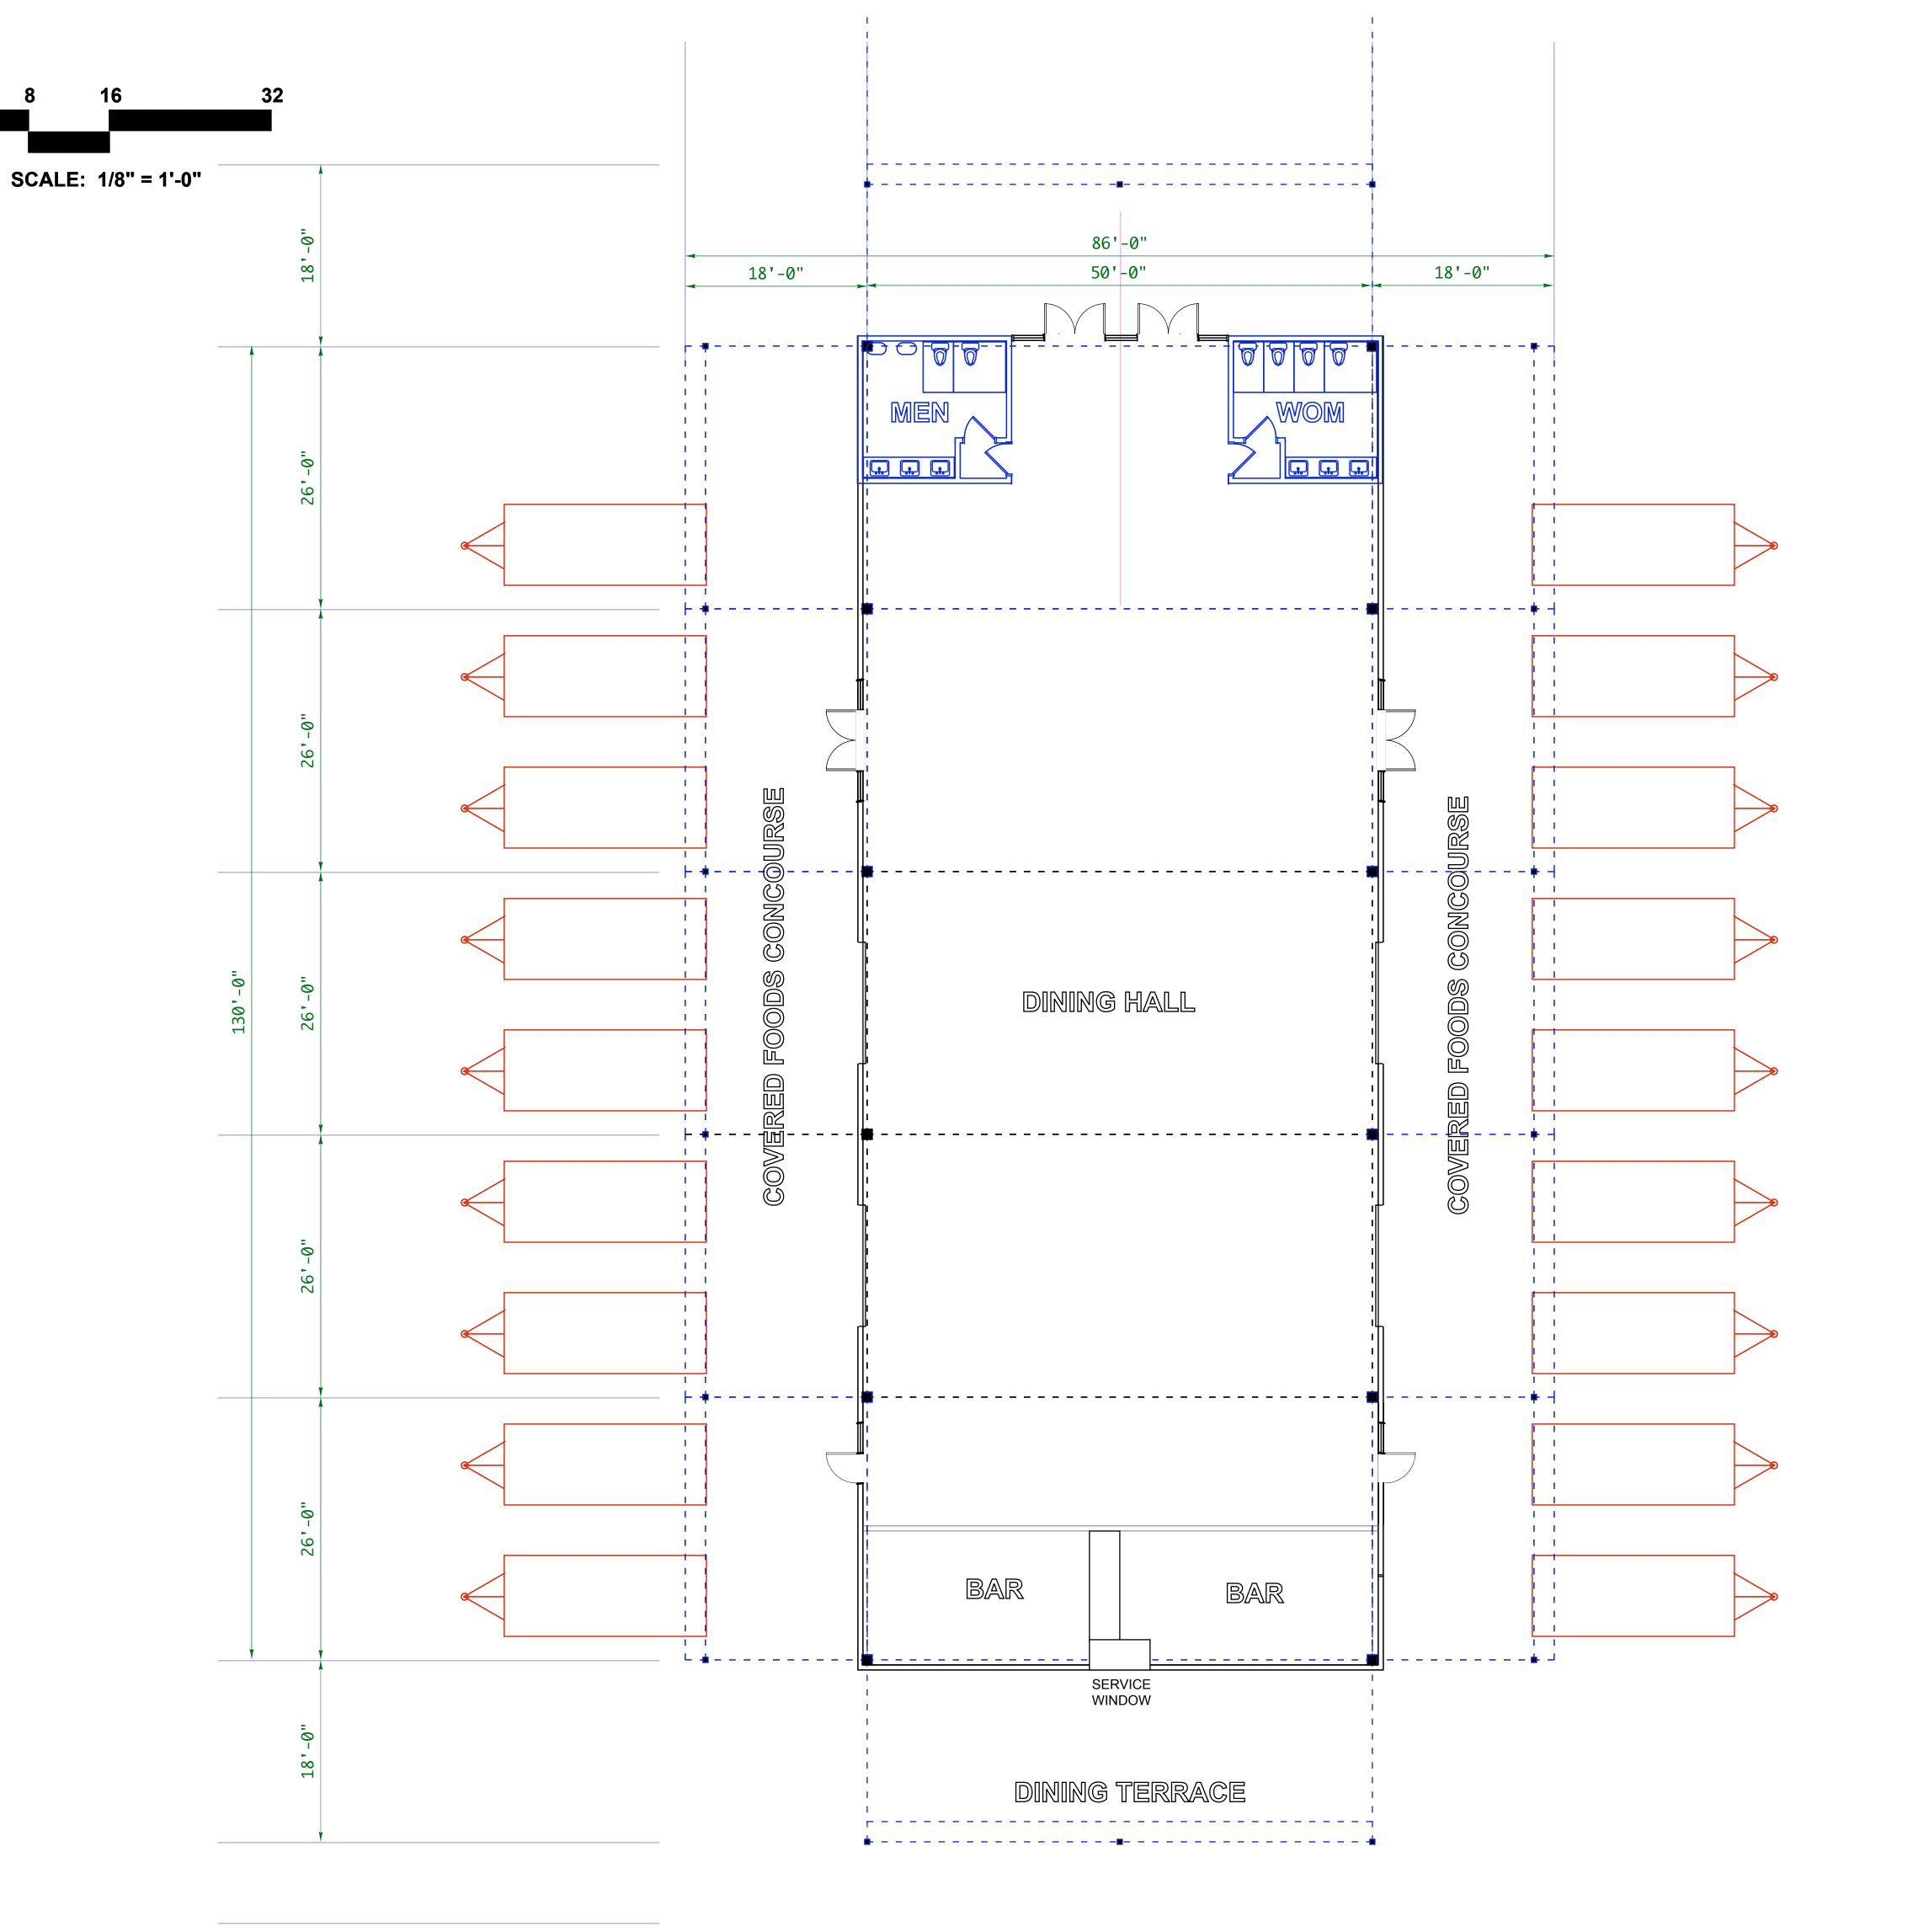
REVISIONS

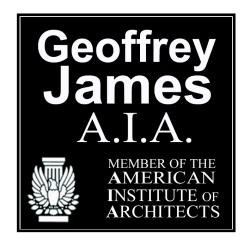
ATTACHMENT 106

DATE: 03-06-2025

SHEET NUMBER

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OWNER:
CHECKPOINT 217
LLC



Checkpoint 211 FOOD PAVILION

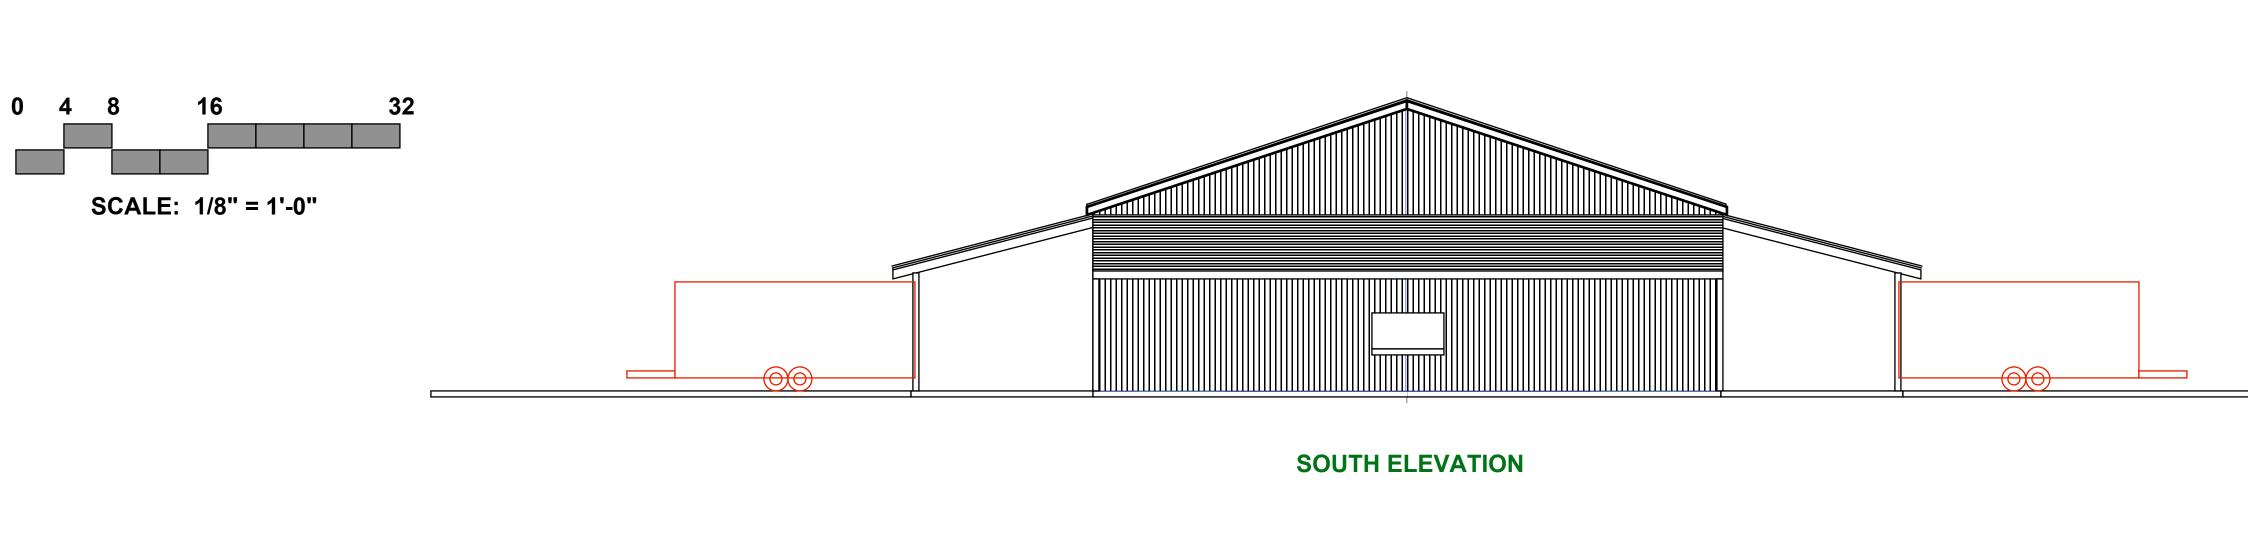
WOODBURN

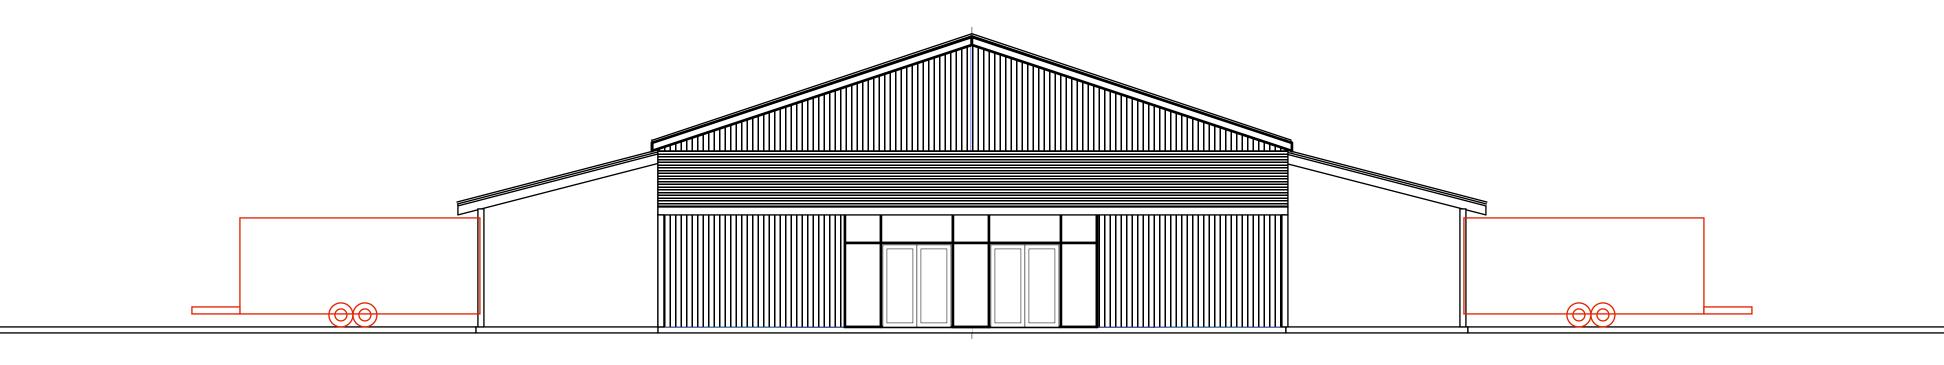
2010 MOLALLA RD WOODBURN

REVISIONS

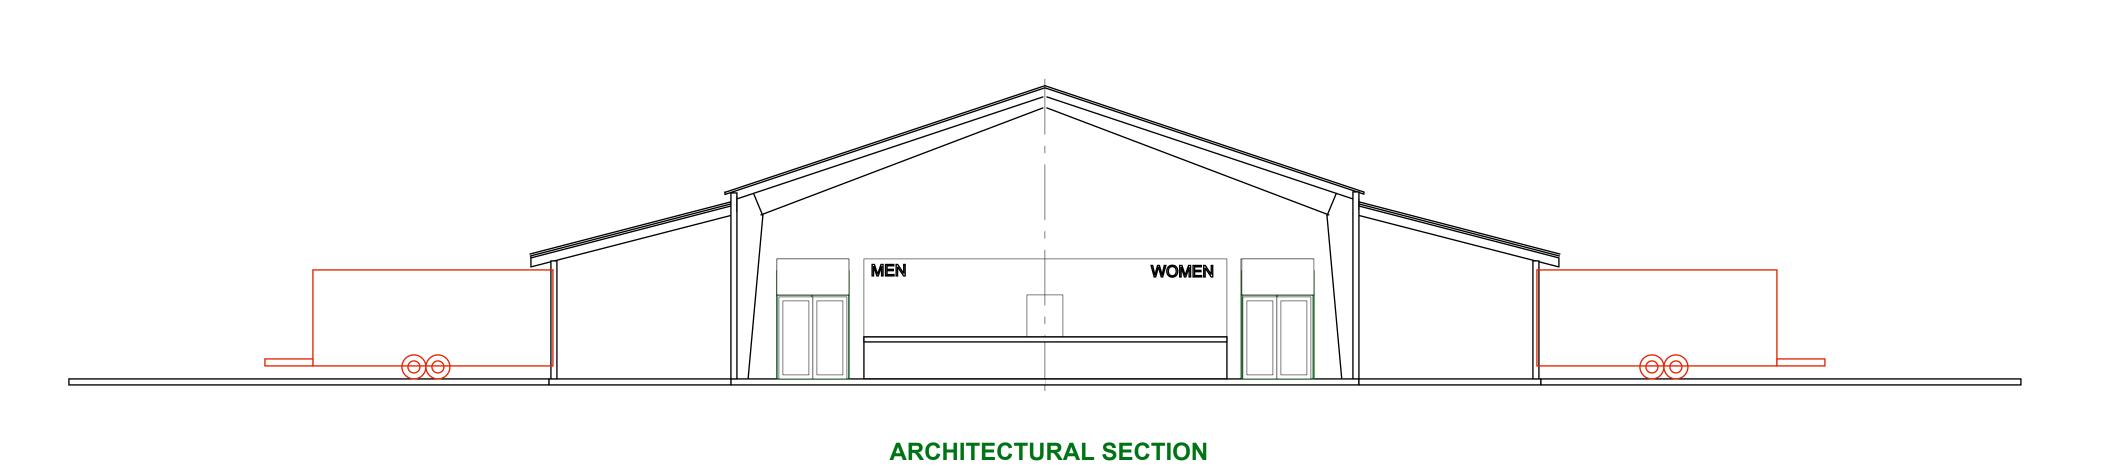
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WEST ELEVATION

Geoffrey James A.I.A.

MEMBER OF THE AMERICAN INSTITUTE OF ARCHITECTS

Geoffrey James A.I.A.

ARCHITECT

Architecture & Planning

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OWNER: CHECKPOINT 217 LLC



Checkpoint
211
FOOD PAVILION

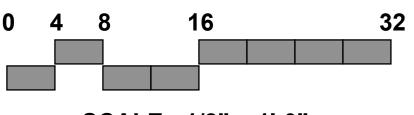
WOODBURN

2010 MOLALLA RD WOODBURN

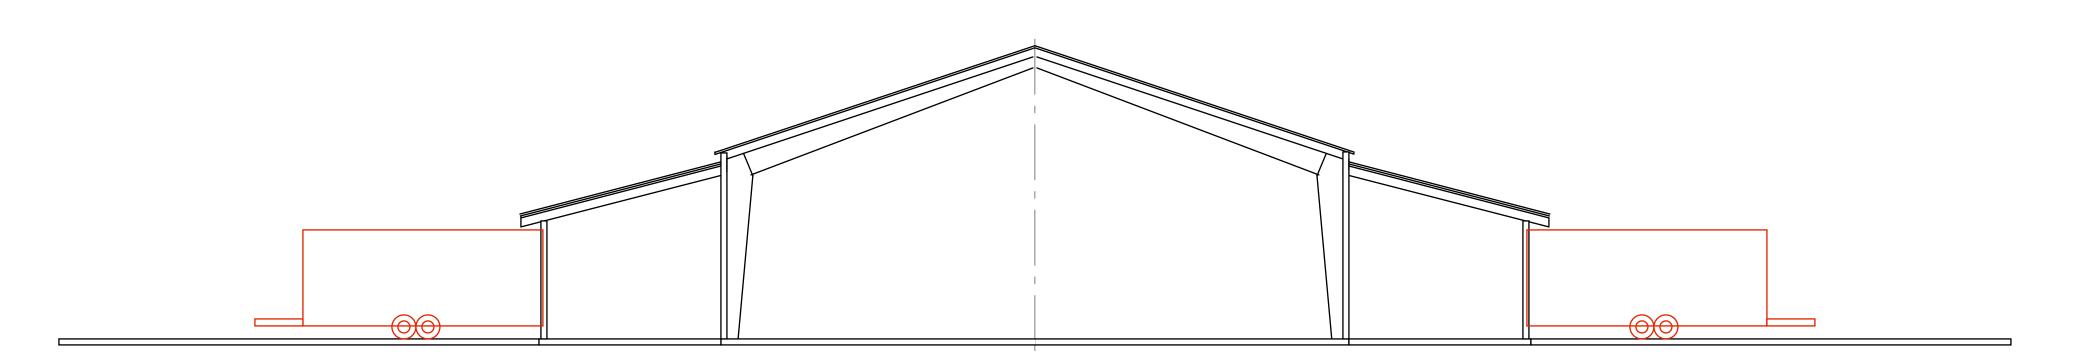
REVISIONS

DATE: 01-18-2025

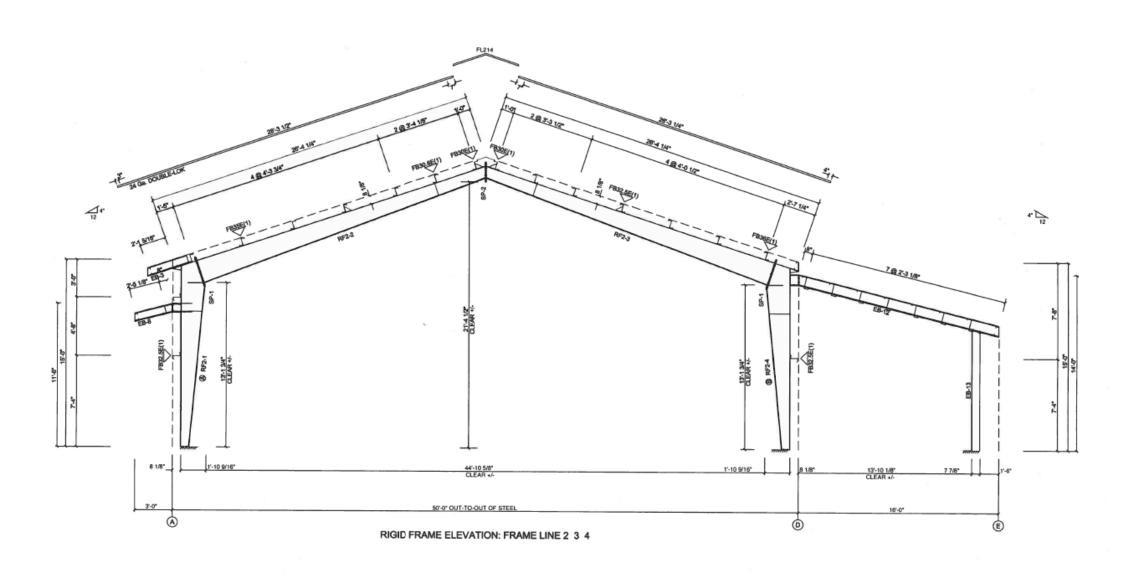
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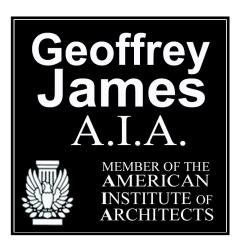
SCALE: 1/8" = 1'-0"



ARCHITECTURAL SECTION



STEEL STRUCTURE SECTION



Geoffrey James A.I.A.

ARCHITECT

Architecture & Planning

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OWNER:
CHECKPOINT 217
LLC



Checkpoint
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FOOD PAVILION

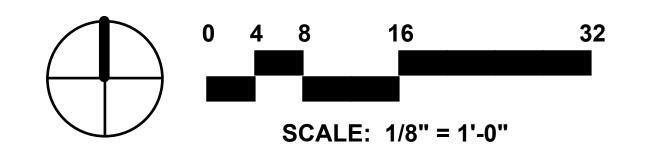
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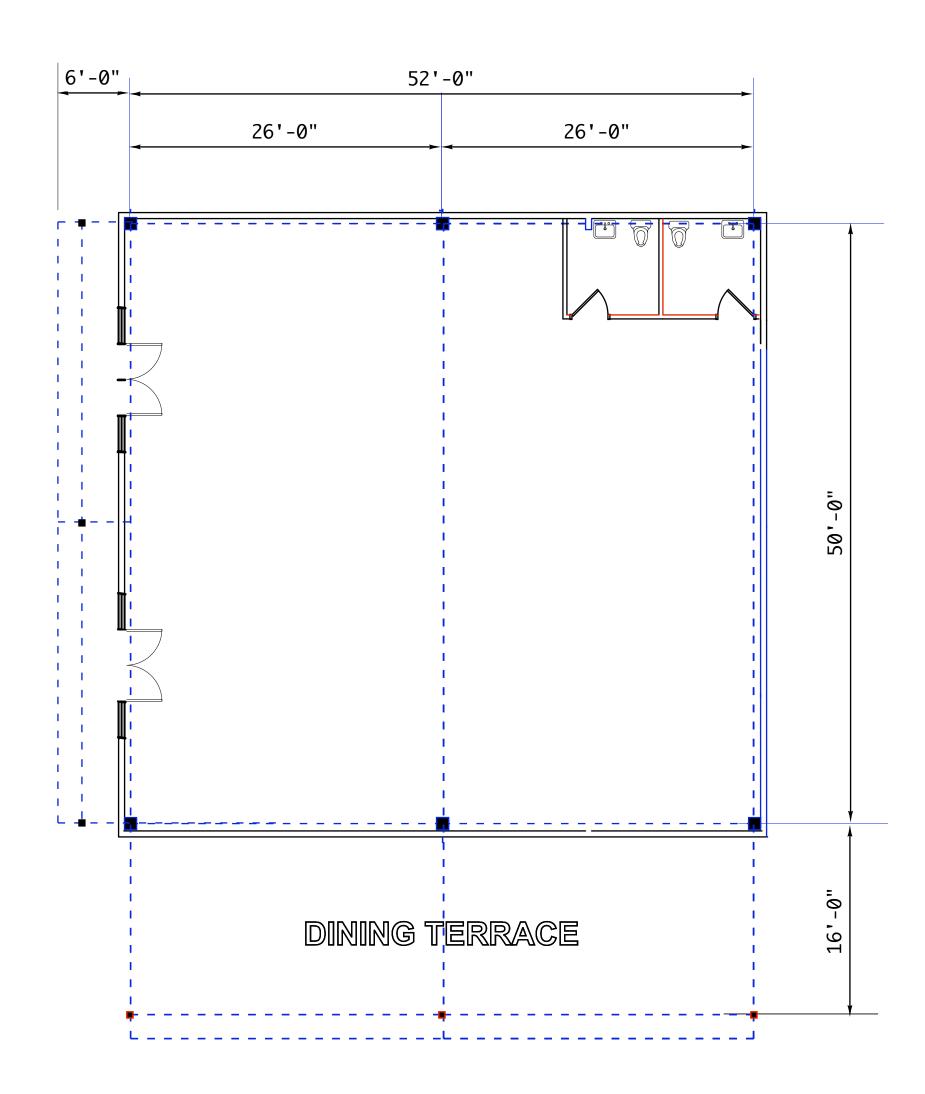
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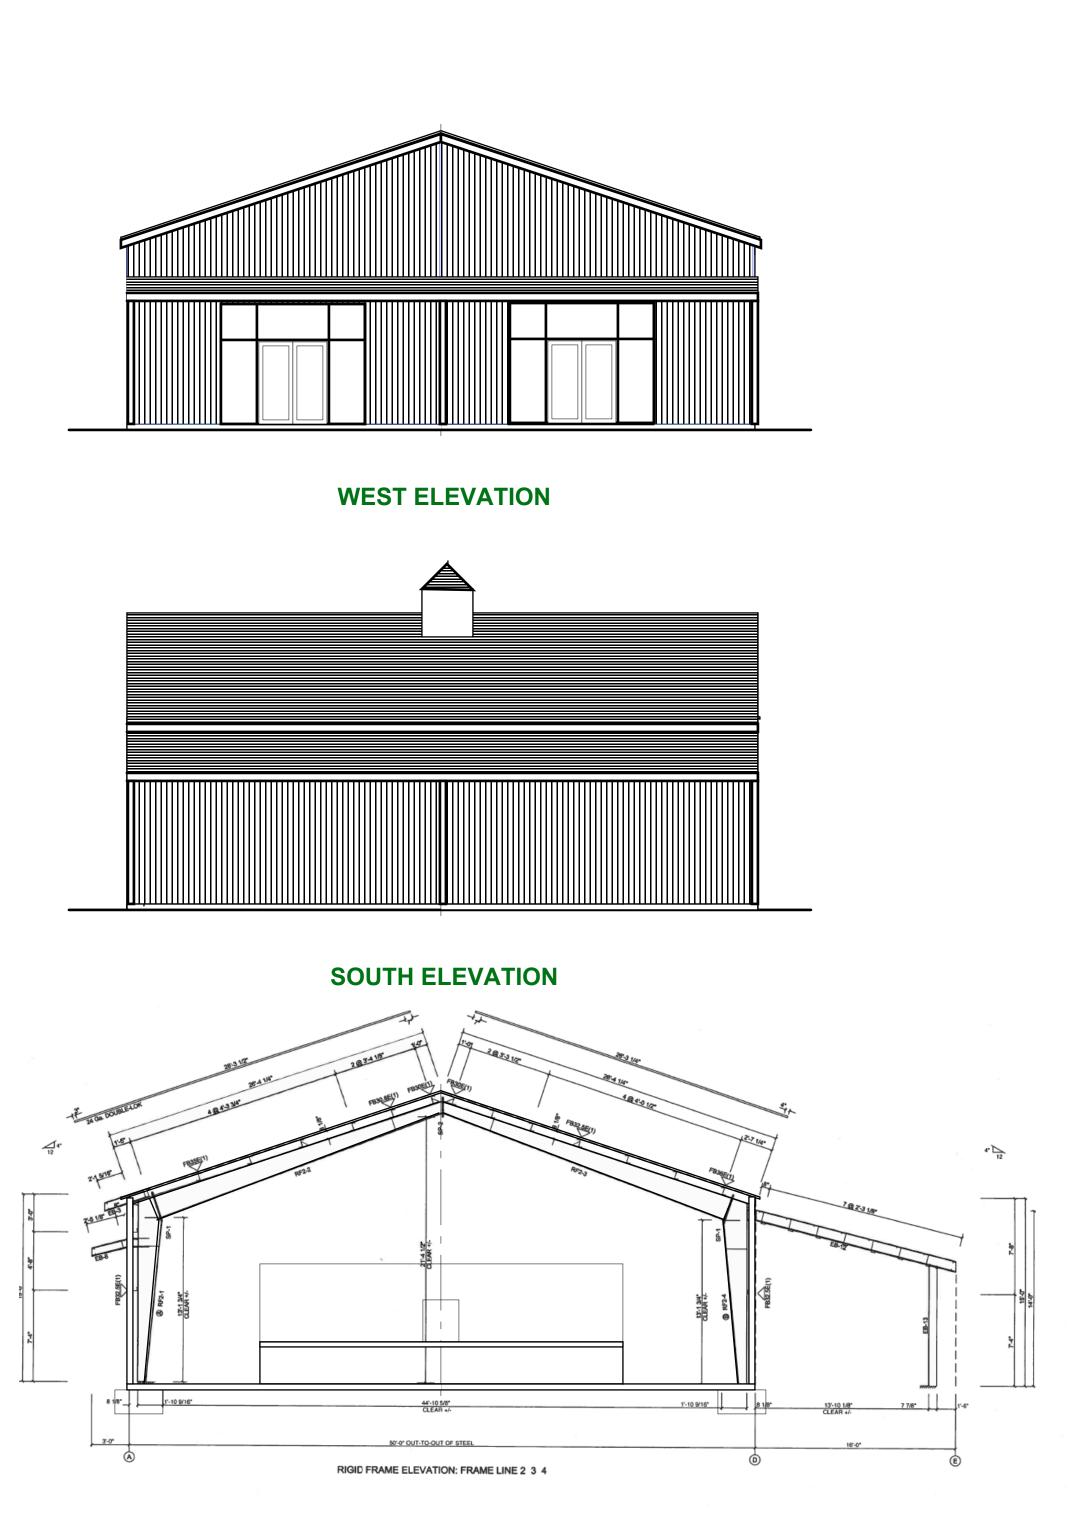
REVISIONS

DATE: 01-18-2025

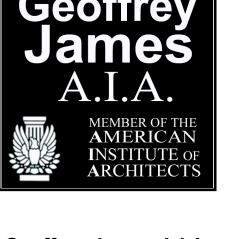
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SECTION



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OWNER:
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Checkpoint 211 FOOD PAVILION

WOODBURN

2010 MOLALLA RD WOODBURN

REVISIONS

DATE: 01-18-2025

SHEET NUMBER:

GENERAL NOTES:

- 1. ALL CONSTRUCTION, MATERIALS, AND WORKMANSHIP SHALL CONFORM TO THE LATEST STANDARDS AND PRACTICES OF THE CITY OF WOODBURN, THE OREGON STRUCTURAL SPECIALITY CODE (BUILDING CODE), OREGON PLUMBING SPECIALITY (PLUMBING CODE), AND THE OREGON FIRE CODE (FIRE CODE), LATEST EDITIONS.
- ALL PERMIT AND LICENSES NECESSARY FOR THE EXECUTION AND COMPLETION OF THE WORK SHALL BE SECURED BY THE CONTRACTOR PRIOR TO COMMENCING CONSTRUCTION.
- 3. ALL EXCAVATORS MUST COMPLY WITH THE RULES ADOPTED BY THE OREGON UTILITY NOTIFICATION CENTER, INCLUDING NOTIFICATION OF ALL OWNERS OF UNDERGROUND UTILITIES AT LEAST 48 BUSINESS HOURS. BUT NOT MORE THAN 10 BUSINESS DAYS, BEFORE COMMENCING AN EXCAVATION. THOSE RULES ARE SET FORTH IN OAR 952-001-0010 THROUGH
- 4. THE LOCATION OF EXISTING UNDERGROUND UTILITIES SHOWN ON THE PLAN IS FOR INFORMATION ONLY AND IS NOT GUARANTEED TO BE ACCURATE. CONTRACTOR SHALL VERIFY ELEVATIONS OF ALL UNDERGROUND UTILITY CONNECTION POINTS PRIOR TO COMMENCING WITH CONSTRUCTION AND SHALL BRING ANY DISCREPANCIES TO THE ATTENTION OF 7 OAKS ENGINEERING, INC. POTHOLE ALL CROSSINGS AS NECESSARY BEFORE CONSTRUCTION TO PREVENT GRADE AND ALIGNMEN'
- 5. 7 OAKS ENGINEERING, INC. ASSUMES NO RESPONSIBILITY FOR ANY DISCREPANCIES ENCOUNTERED BETWEEN THE CURRENT FIELD CONDITIONS AND THE INFORMATION SHOWN ON THE SURVEY MAP (PERFORMED BY BARKER SUREVYING, SEPTEMBER 20 2024). THE CONTRACTOR IS RESPONSIBLE FOR REPORTING ANY DISCREPANCIES TO THE OWNER'S REPRESENTATIVE.

GRADING AND PAVING NOTES:

- ALL SURFACES SHALL HAVE A MINIMUM 1.0% SLOPE UNLESS OTHERWISE NOTED ON THE PLANS. ALL SURFACES SHALL MEET EXISTING GRADES SMOOTHLY AND EVENLY AND MAINTAIN CONSTANT SLOPES UNLESS OTHERWISE NOTED ON THE PLANS. 2. THE CONTRACTOR SHALL NOTIFY 7 OAKS ENGINEERING, INC. IF THE GRADING PLAN DOES NOT PROVIDE POSITIVE DRAINAGE
- OR IF SLOPE CALLOUTS DO NOT MATCH SPOT GRADES. 3. THE CONTRACTOR IS RESPONSIBLE FOR MAINTAINING EXISTING SITE AND DRAINAGE PATTERNS AND THE PROTECTION OF
- 4. THE CONTRACTOR SHALL REPLACE AND RESTORE AREAS NOT SCHEDULED FOR CONSTRUCTION TO THEIR ORIGINAL CONDITION
- 5. THE CONTRACTOR SHALL EXERCISE EXTREME CAUTION WHEN WORKING IN AREAS ADJACENT TO EXISTING TREES IN ORDER TO MINIMIZE DISTURBANCES TO THE ROOTS. THE CONTRACTOR SHALL INSTALL TREE PROTECTION FENCING PER CITY OF ALBANY
- 6. THE CONTRACTOR SHALL BE RESPONSIBLE FOR DEMOLITION AND DISPOSAL OF EXISTING AC, CURBS, SIDEWALKS, AND OTHER SITE ELEMENTS WITHIN THE LIMITS OF DEMOLITION., UNLESS OTHERWISE NOTED ON PLANS. DISPOSE OF DEMOLISHED ITEMS
- 7. ACTUAL LINES AND GRADES OF EXCAVATION SHALL BE STAKED BY A QUALIFIED SURVEYOR. BASED ON THE INFORMATION SHOWN ON THE PLANS. THE CONTRACTOR SHALL RETAIN A SURVEYOR LICENSED IN OREGON.
- 8. ADJUST ALL INCIDENTAL STRUCTURES, MANHOLE LIDS, VALVE BOXES, ETC. TO FINISH GRADE.
- 9. PAVING WILL NOT BE ALLOWED DURING WET OR COLD WEATHER.
- 10. ALL CONSTRUCTION WITHIN THE CITY RIGHT-OF-WAY SHALL HAVE AN APPROVED TRAFFIC CONTROL PLAN.
- 11. ALL CONSTRUCTION WITHIN THE CITY RIGHT-OF-WAY SHALL BE PERMITTED UNDER SEPARATE PERMIT. 12. PRIOR TO THE PLACEMENT OF AGGREGATE BASE MATERIALS RELATED TO SITE PAVING, A GEOTECHNICAL ENGINEER SHOULD BE PRESENT TO OBSERVE AND EVALUATE THE SUBGRADE SOIL CONDITIONS, AS OUTLINED IN THE GEOTECHNICAL REPORT.

UTILITY NOTES:

- MATERIALS SHALL BE NEW. THE USE OF MANUFACTURER'S NAMES, MODELS, AND NUMBERS IS INTENDED TO ESTABLISH STYLE, QUALITY, APPEARANCE, AND USEFULNESS. PROPOSED SUBSTITUTIONS WILL REQUIRE WRITTEN APPROVAL FROM CITY ENGINEER PRIOR TO INSTALLATION.
- 2. ALL TRENCH BACKFILL SHALL BE SHOWN ON THE PIPE BEDDING AND BACKFILL DETAIL. FLOODING OR JETTING THE BACKFILLED TRENCHES WITH WATER IS NOT PERMITTED.
- CONNECTIONS TO EXISTING UTILITIES SHALL CONFORM WITH THE CITY'S ENGINEERING DESIGN MANUAL AND STANDARD PLANS.
- ALL WATER AND FIRE PROTECTION PIPE SHALL HAVE A MINIMUM 36-INCH COVER TO FINISHED GRADE. ALL WATER LINES SHALL BE THOROUGHLY FLUSHED, CHLORINATED AND TESTED IN ACCORDANCE WITH OREGON STATE HEALTH DEPARTMENT PRIOR TO ANY METER HOOK-UP SERVICE.
- 6. BEGIN LAYING STORM AND SANITARY SEWER PIPE AT THE LOW POINT OF THE SYSTEM TRUE TO GRADE AND ALIGNMENT INDICATED WITH UNBROKEN CONTINUITY OF INVERT. ESTABLISH LINE AND GRADE FOR THE STORM AND SANITARY SEWER PIPE
- 7. CONTRACTOR SHALL MAINTAIN A MINIMUM 5' HORIZONTAL AND 18" VERTICAL SEPARATION BETWEEN ALL EXISTING AND PROPOSED WATER AND SANITARY SEWER LINES.
- 8. FOR CROSSINGS OF WATER LINES AND SANITARY SEWER LINES, THE OREGON STATE HEALTH DEPARTMENT CRITERIA SHALL
- 9. EXISTING STORM OR SANITARY LATERALS TO BE UTILIZED FOR NEW SYSTEM MUST BE VIDEO INSPECTED WITH CITY INSPECTOR PRESENT PRIOR TO CONNECTION.
- 10. ALL NEW DRYWELLS MUST BE ACCESSIBLE PER OREGON DEPARTMENT OF ENVIRONMENTAL SERVICES QUALITY REQUIREMENTS. 11. THE CONTRACTOR SHALL VACUUM OUT ALL TRAPPED INLETS, MANHOLES, AND DRYWELLS AT THE END OF CONSTRUCTION.
- 12. CONTRACTOR SHALL EXERCISE CARE IN ALL OPERATIONS TO PROTECT EXISTING UNDERGROUND UTILITIES, ANY DAMAGE RESULTING FROM THIS WORK MUST BE RESTORED AT THE CONTRACTOR'S EXPENSE TO THE APPROVAL OF THE OWNER'S
- 13. PER ORS 92.044(7): UTILITY INFRASTRUCTURES MAY NOT BE PLACED WITHIN 1-FT OF A SURVEY MONUMENT LOCATION NOTED ON A SUBDIVISION OR PARTITION PLAT.

FEMA:

PROJECT IS LOCATED WITHIN MINIMAL FLOOD HAZARD ZONE 'X' PER MAP 41047C0139G EFFECTIVE. 01/19/2000.

SURVEY NOTES:

BENCHMARK UTILIZED: CITY OF WOODBURN #9

ELEVATION: 182.82' NGVD 29

MARK IS A 3&3" BRASS DISK IN 1'X1' CONCRETE BLOCK STAMPED "US GEOLOGICAL SURVEY", APPROXIMATELY 17' EAST OF THE EASTERNMOST RAILROAD TRACK NORTHEAST OF THE INTERSECTION OF FRONT STREET AND YOUNG STREET, APPROXIMATELY 100' NORTH OF THE INTERSECTION, UNDER OVERHEAD WIRES.

EARTHWORK:

STATEMENT OF QUANTITIES:

RAW CUT: 479 CY 1800 CY RAW FILL: 1321 CY RAW IMPORT:

NUMBERS ABOVE ASSUME ANY REMOVAL AND OVEREXCAVATED SOILS WILL BE RECYCLED FOR THE SITE, AS PROVIDED PER ANY GEOTECHNICAL GUIDELINES. THESE ARE RAW NUMBERS AND DO NOT CONSIDER UTILITY TRENCHES, ETC.

NOTE: THE QUANTITIES ARE SHOWN HEREON ARE FOR PERMIT AND/OR BONDING PURPOSES ONLY. THE GRADING CONTRACTOR SHALL BE RESPONSIBLE FOR VERIFICATION OF QUANTITIES PRIOR TO THE START OF GRADING AND ACCOUNT FOR DISTURBING ANY EXCESS MATERIAL OR SUPPLYING ANY DEFICIENCIES TO BRING SITE TO DESIGN GRADE. THE ABOVE CUT AND FILL FIGURES REPRESENT PURE VOLUME FIGURES ONLY. THERE IS NO CONSIDERATION TAKEN FOR SHRINKAGE, SUBSIDENCE, OR ANY OTHER LOSS FACTOR. THE CONTRACTOR'S BID WILL BE THE SOLE BASIS FOR ALL PAYMENTS FOR WORK DONE. PRIOR TO START OF CONSTRUCTION, CONTRACTOR/OWNER SHALL LOCATE TOE AND TOP OF SLOPES BY FIELD MEASUREMENTS AND VERIFY PAD ELEVATIONS.

NOTICE TO EXCAVATORS:

ATTENTION: OREGON LAW REQUIRES YOU TO FOLLOW RULES ADOPTED BY THE OREGON UTILITY NOTIFICATION CENTER. THOSE RULES ARE SET FORTH IN OAR 952-001-0010 THROUGH OAR 952-001-0090. YOU MAY OBTAIN COPIES OF THE RULES BY CALLING THE CENTER.

(NOTE: THE TELEPHONE NUMBER FOR THE OREGON UTILITY NOTIFICATION CENTER IS 503-232-1987).

POTENTIAL UNDERGROUND FACILITY OWNFRS

Dig Safely.

Call the Oregon One-Call Center DIAL 811 or 1-800-332-2344

ENGINEER'S NOTICE TO CONTRACTOR:

THE EXISTENCE AND LOCATION OF ANY UNDERGROUND UTILITIES OR STRUCTURES SHOWN IN THESE PLANS ARE OBTAINED BY A SEARCH OF AVAILABLE RECORDS, AND TO THE BEST OF OUR KNOWLEDGE, THERE ARE NOT EXISTING UTILITIES EXCEPT THOSE SHOWN ON THESE PLANS. THE CONTRACTOR IS REQUIRED TO TAKE ALL PRECAUTIONARY MEASURES TO PROTECT THE UTILITIES SHOWN, AND ANY OTHER LINES OR STRUCTURES NOT SHOWN ON THESE PLANS, AND IS RESPONSIBLE FOR THE PROTECTION OF ANY DAMAGE TO THESE LINES OR STRUCTURES.

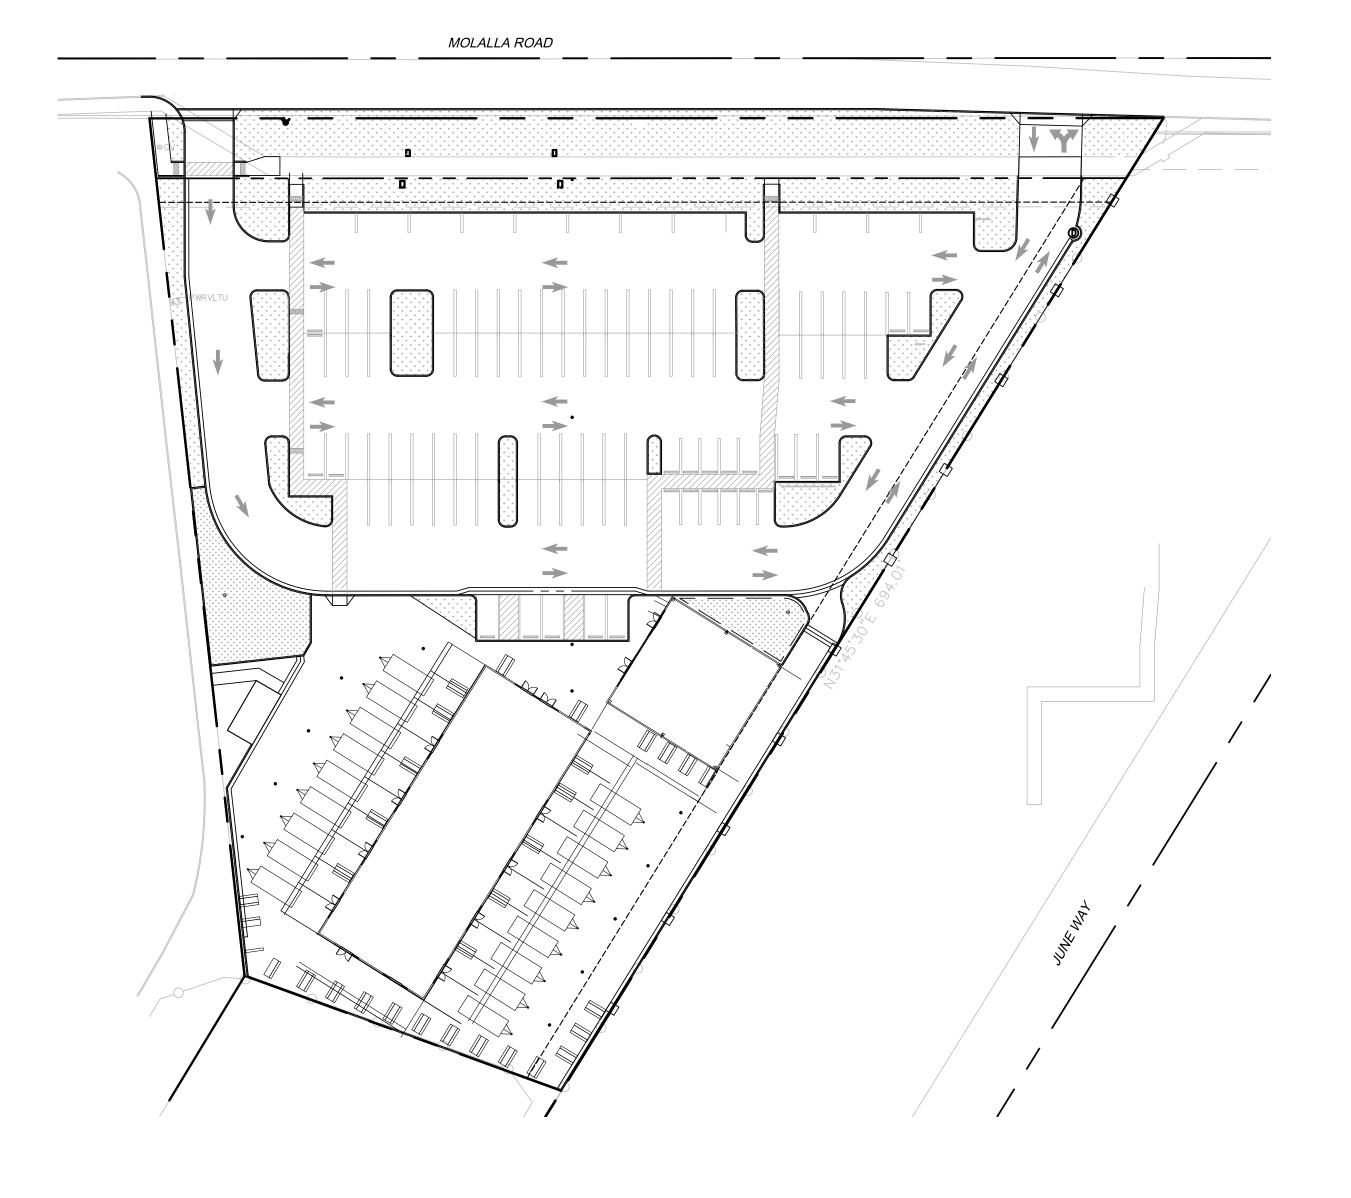
CONSTRUCTION CONTRACTOR AGREES THAT IN ACCORDANCE WITH GENERALLY ACCEPTED CONSTRUCTION PRACTICES, CONSTRUCTION CONTRACTOR WILL BE REQUIRED TO ASSUME SOLE AND COMPLETE RESPONSIBILITY FOR JOB SITE CONDITIONS DURING THE COURSE OF CONSTRUCTION FOR THE PROJECT, INCLUDING SAFETY OF ALL PERSONS AND PROPERTY; THAT THIS REQUIREMENTS SHALL BE MADE TO APPLY CONTINUOUSLY AND NOT BE LIMITED TO NORMAL WORKING HOURS, AND CONSTRUCTION CONTRACTOR FURTHER AGREES TO DEFEND, INDEMNIFY, AND HOLD HARMLESS THE CITY, ITS EMPLOYEES, AND AGENTS FROM ANY AND ALL LIABILITY, REAL OR ALLEGED, IN CONNECTION WITH THE PERFORMANCE OF WORK ON THIS PROJECT.

THE CONTRACTOR SHALL BE RESPONSIBLE TO REPORT DISCREPANCIES IN PLANS AND/OR FIFI D CONDITIONS IMMEDIATELY TO THE DESIGN ENGINEER FOR RESOLUTION PRIOR TO CONSTRUCTION, AND SHALL BE RESPONSIBLE FOR DISCREPANCIES NOT SO REPORTED AND

PRELIMINARY ENGINEERING PLANS FOR:

US CHECKPOINT 211

AT 2010 MOLALLA AVENUE WOODBURN, OREGON 97071



ABBREVIATIONS:

MIN.

SQ.FT

INV.

CFS

SCH.

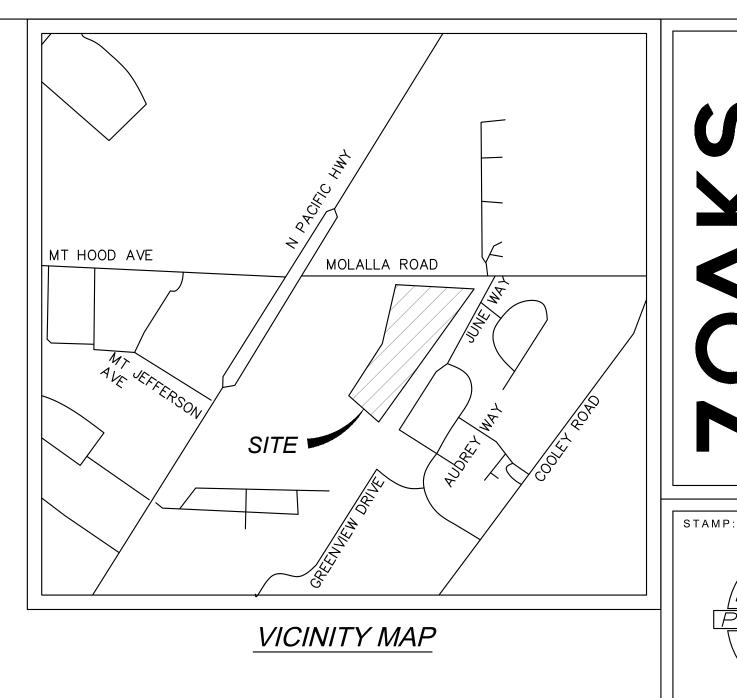
PVC

SDR

CB

| PL FF TC | PROPERTY LINE FINISHED FLOOR TOP OF CURB |
|----------------|--|
| FS | FINISHED SURFACE |
| FL | FLOW LINE |
| FG GB | FINISHED GRADE GRADF BRFAK |
| CL | CENTERLINE |
| R | RIDGE LINE |
| R/W | RIGHT OF WAY |
| WV | WATER VALVE |
| PR. | PROPOSED |
| NAP | NOT A PART |
| FT | FEET |
| EV | ELECTRIC VEHICLE |
| CAV | CLEAN AIR VEHICLE |
| STD. | STANDARD |
| AC. | ACRES |
| CUP EX. | CONDITIONAL USE PERMIT FXISTING |
| TAD | TOP OF AREA DRAIN |
| יהט | TOT OF AINLY DIVING |

TYPICAL MINIMUM SANITARY SEWER STORM DRAIN CURB FACE WATER METER FIRE DEPARTMENT CONNECTION ACCESSOR'S PARCEL MAP SQUARE FEET INVFRT BACKFLOW CUBIC FEET PER SECOND SCHEDULE POLYVINYL CHLORIDE SPECIAL DRAWING RIGHT POUNDS PER SQUARE INCH NATIONAL FIRE PREVENTION ASSOCIATION CATCH BASIN VITRIFIED CLAY PIPE



SHEET INDEX:

C1.0 - TITLE SHEET C2.0 - PRELIMINARY GRADING PLAN C3.0 - PRELIMINARY GRADING PLAN C4.0 - PRELIMINARY WET UTILITY PLAN C5.0 - PRELIMINARY WET UTILITY PLAN C6.0 - PRELIMINARY STORMWATER PLAN

PROJECT DIRECTORY:

ARCHITECT:

GEOFFREY JAMES A.I.A. ARCHITECTURE & PLANNING 4115 FRASER LANAE SE, SALEM, OR. 97302 503.931.4120 GJAMESARCHITECT@GMAIL.COM

SURVEY:

BARKER SURVEYING 3657 KASHMIR WAY SE SALEM. OR. 97317 PH:503.588.8800 FAX:503.363.2469 GREG@BARKERWILSON.COM

CIVIL ENGINEER:

7 OAKS ENGINEERING, INC. KIM JOHNSON, P.E. 345 WESTFIELD ST. #107 SILVERTON, OR. 97381 503.308.8520 KIM@70AKSENGINEERING.COM

GEOTECH:

GEOPACIFIC ENGINEERING, INC. 14835 SW 72ND AVENUE PORTLAND, OR 97224 503.598.8445

UTILITY PURVEYORS:

WATER:

CITY OF WOODBURN 770 NW 17TH AVE WOODBURN, OR. 97071 503.982.5222

WOODBURN, OR. 97071 503.982.8450

SEWER: CITY OF WOODBURN 770 NW 17TH AVE WOODBURN, OR. 97071 503.982.5222

ELECTRIC:

PORTLAND GENERAL ELECTRIC 2079 PROGRESS WAY WOODBURN, OR. 97071 503.464.7777

CITY OF WOODBURN 770 NW 17TH AVE

NATURAL GAS: NORTHWEST NATURAL GAS COMPANY

STORM DRAIN:

220 NW 2ND AVE. PORTLAND, OR. 97365 800.422.4012

> SHEET TITLE: TITLE SHEET

Z

RENEWS BY: 06/30/2025

NO CHANGES, MODIFICATIONS OR REPRODUCTIONS TO BE MADE TO THESE DRAWINGS WITHOUT WRITTEN AUTHORIZATION FROM THE DESIGN ENGINEER.

THESE DRAWINGS MAY HAVE BEEN REPRODUCED AT A SIZE DIFFERENTLY THAN ORIGINALLY DRAWN. OWNER AND ENGINEER ASSUME NO RESPONSIBILITY FOR USE OF INCORRECT SCALE.

CONTRACTOR SHALL VERIFY ALL EXISTING CONDITIONS PRIOR TO PROCEEDING WITH CONSTRUCTION AND NOTIFY ARCHITECT IMMEDIATELY OF ANY DISCREPANCIES OR CONFLICTS.

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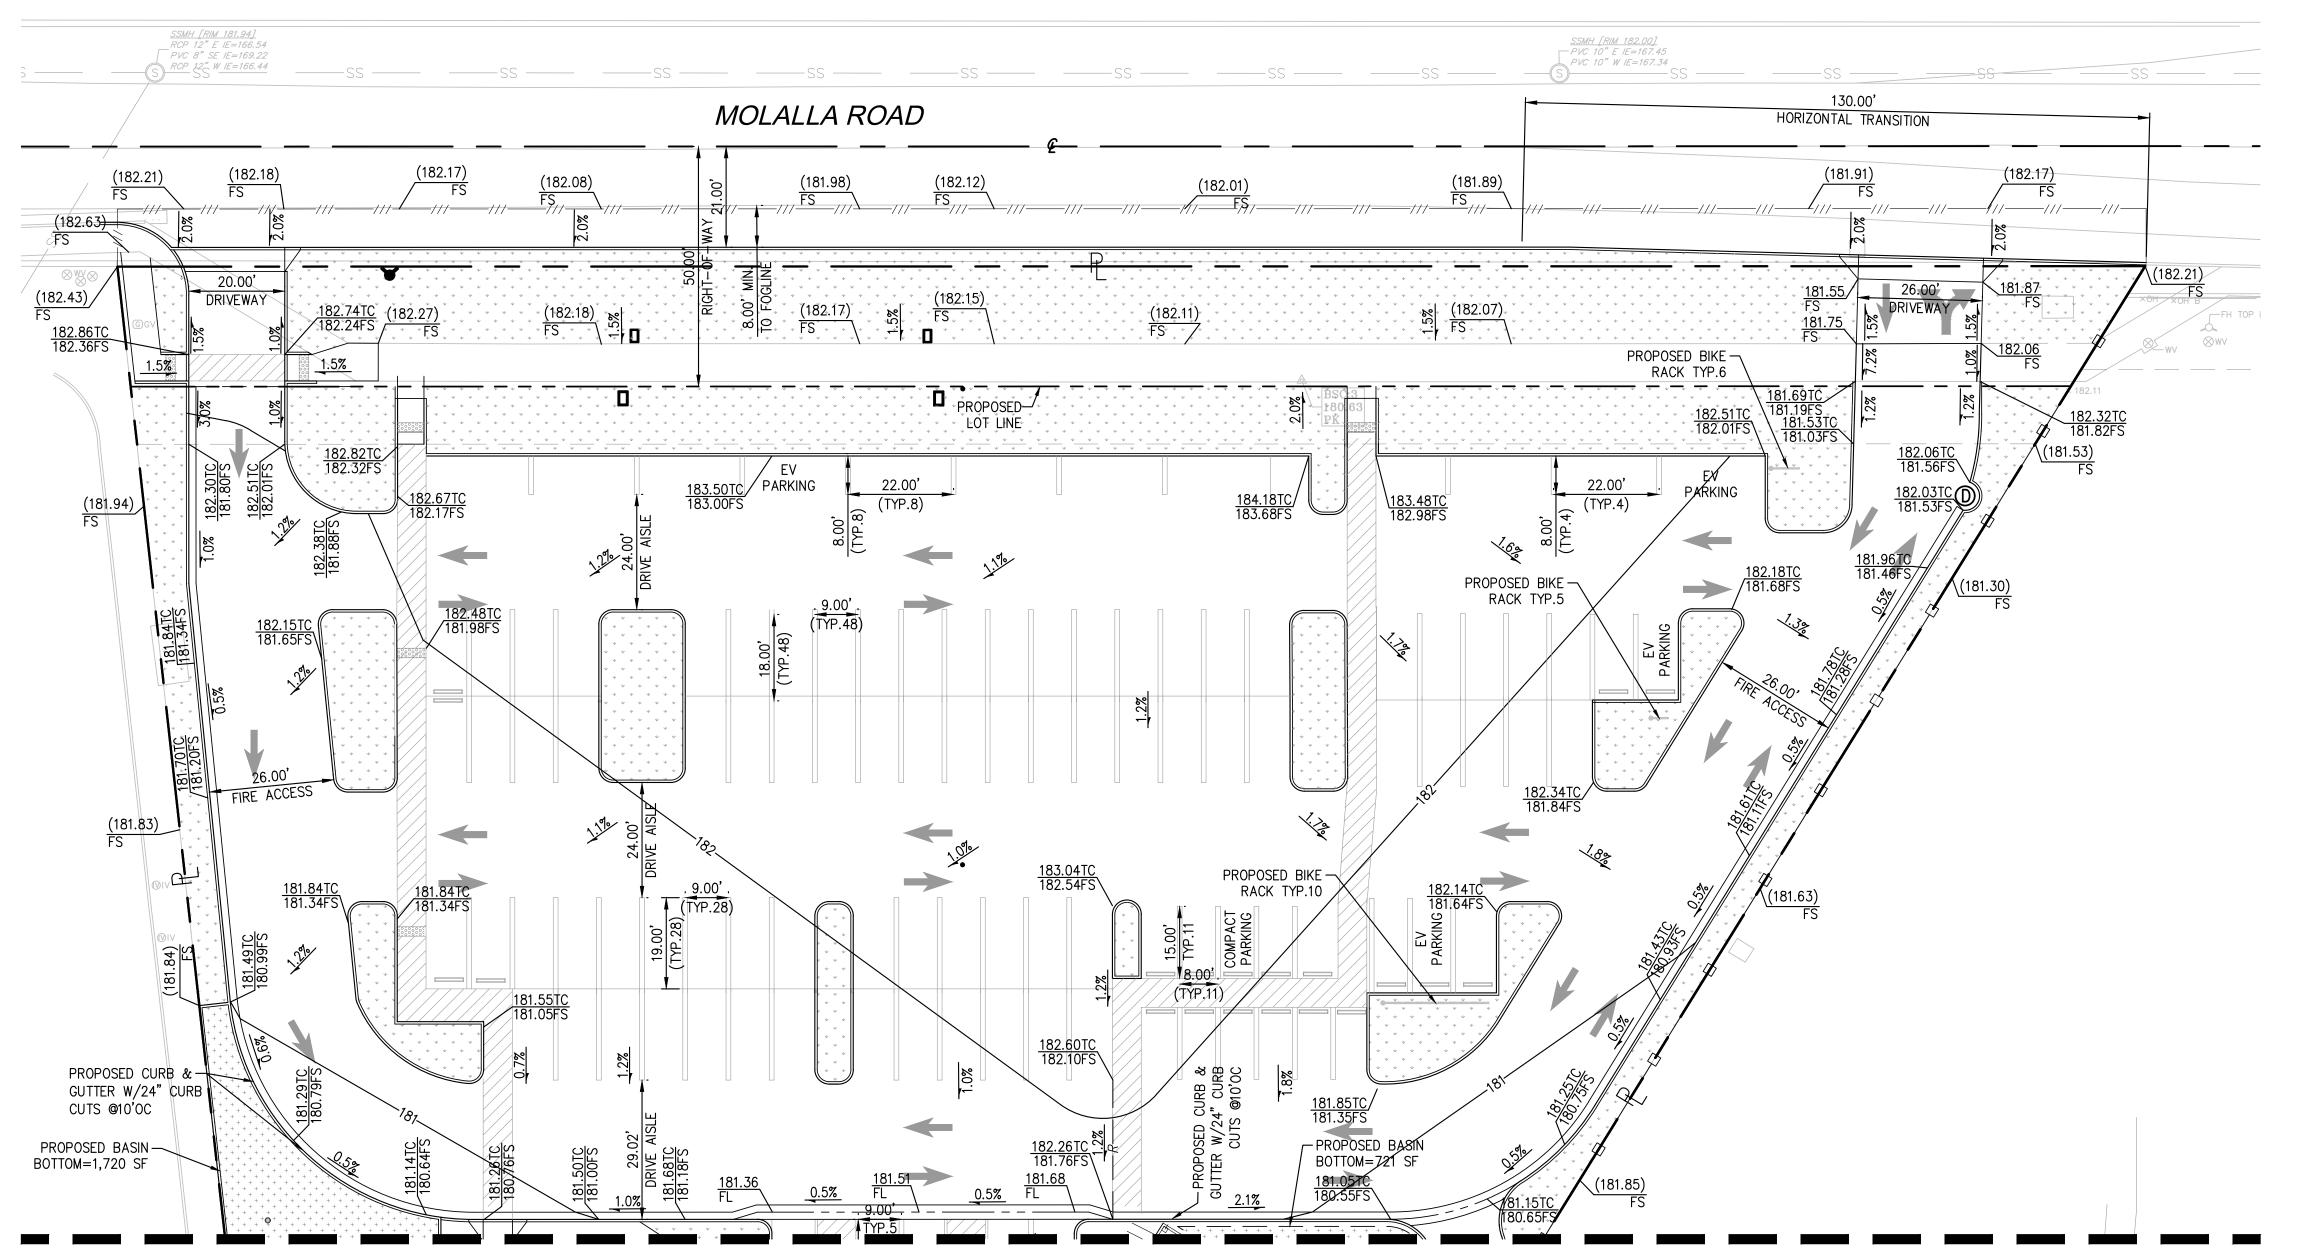
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DATE | ISSUE DESCRIPTION

SHEET NUMBER:

DA 7

JOB #00342



MATCHLINE - SEE SHEET C3.0

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(NOTE: THE TELEPHONE NUMBER FOR THE OREGON UTILITY NOTIFICATION CENTER IS 503-232-1987).

POTENTIAL UNDERGROUND FACILITY OWNERS

Dig Safely.

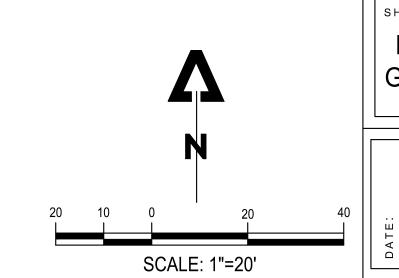
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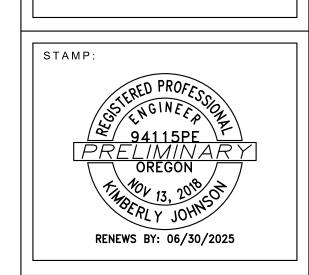
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ISSUE DESCRIPTION

DATE

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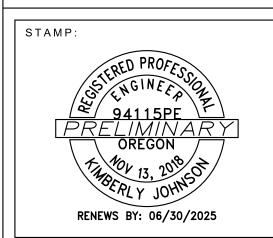
CHECKPOINT 211 FOOD
PAVILION
2010 MOLALLA AVE
WOODBURN, OR 97071

PRELIMINARY
GRADING PLAN

SHEET NUMBER:

JOB #00342

MATCHLINE - SEE SHEET C2.0 PAVILION 2,808 SF FF=182.00 182.00FS PAVILION 6,500 SF FF=182.00 182.00FS (181.55)TC (181.30)FS 2.2% PROPOSED GRADING—ON ADJACENT LOT



| NO | DATE | ISSUE DESCRIPTION |
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NO CHANGES, MODIFICATIONS OR REPRODUCTIONS TO BE MADE TO THESE DRAWINGS WITHOUT WRITTEN AUTHORIZATION FROM THE DESIGN ENGINEER. THESE DRAWINGS MAY HAVE BEEN REPRODUCED AT A SIZE DIFFERENTLY THAN ORIGINALLY DRAWN. OWNER AND ENGINEER ASSUME NO RESPONSIBILITY FOR USE OF INCORRECT SCALE. CONTRACTOR SHALL VERIFY ALL EXISTING CONDITIONS PRIOR TO PROCEEDING WITH CONSTRUCTION AND NOTIFY ARCHITECT IMMEDIATELY OF ANY DISCREPANCIES OR CONFLICTS.

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SHEET TITLE: PRELIMINARY GRADING PLAN

SCALE: 1"=20'

SHEET NUMBER:

NOTICE TO EXCAVATORS:

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(NOTE: THE TELEPHONE NUMBER FOR THE OREGON UTILITY NOTIFICATION CENTER IS 503-232-1987).

POTENTIAL UNDERGROUND FACILITY OWNERS

Dig | Safely.

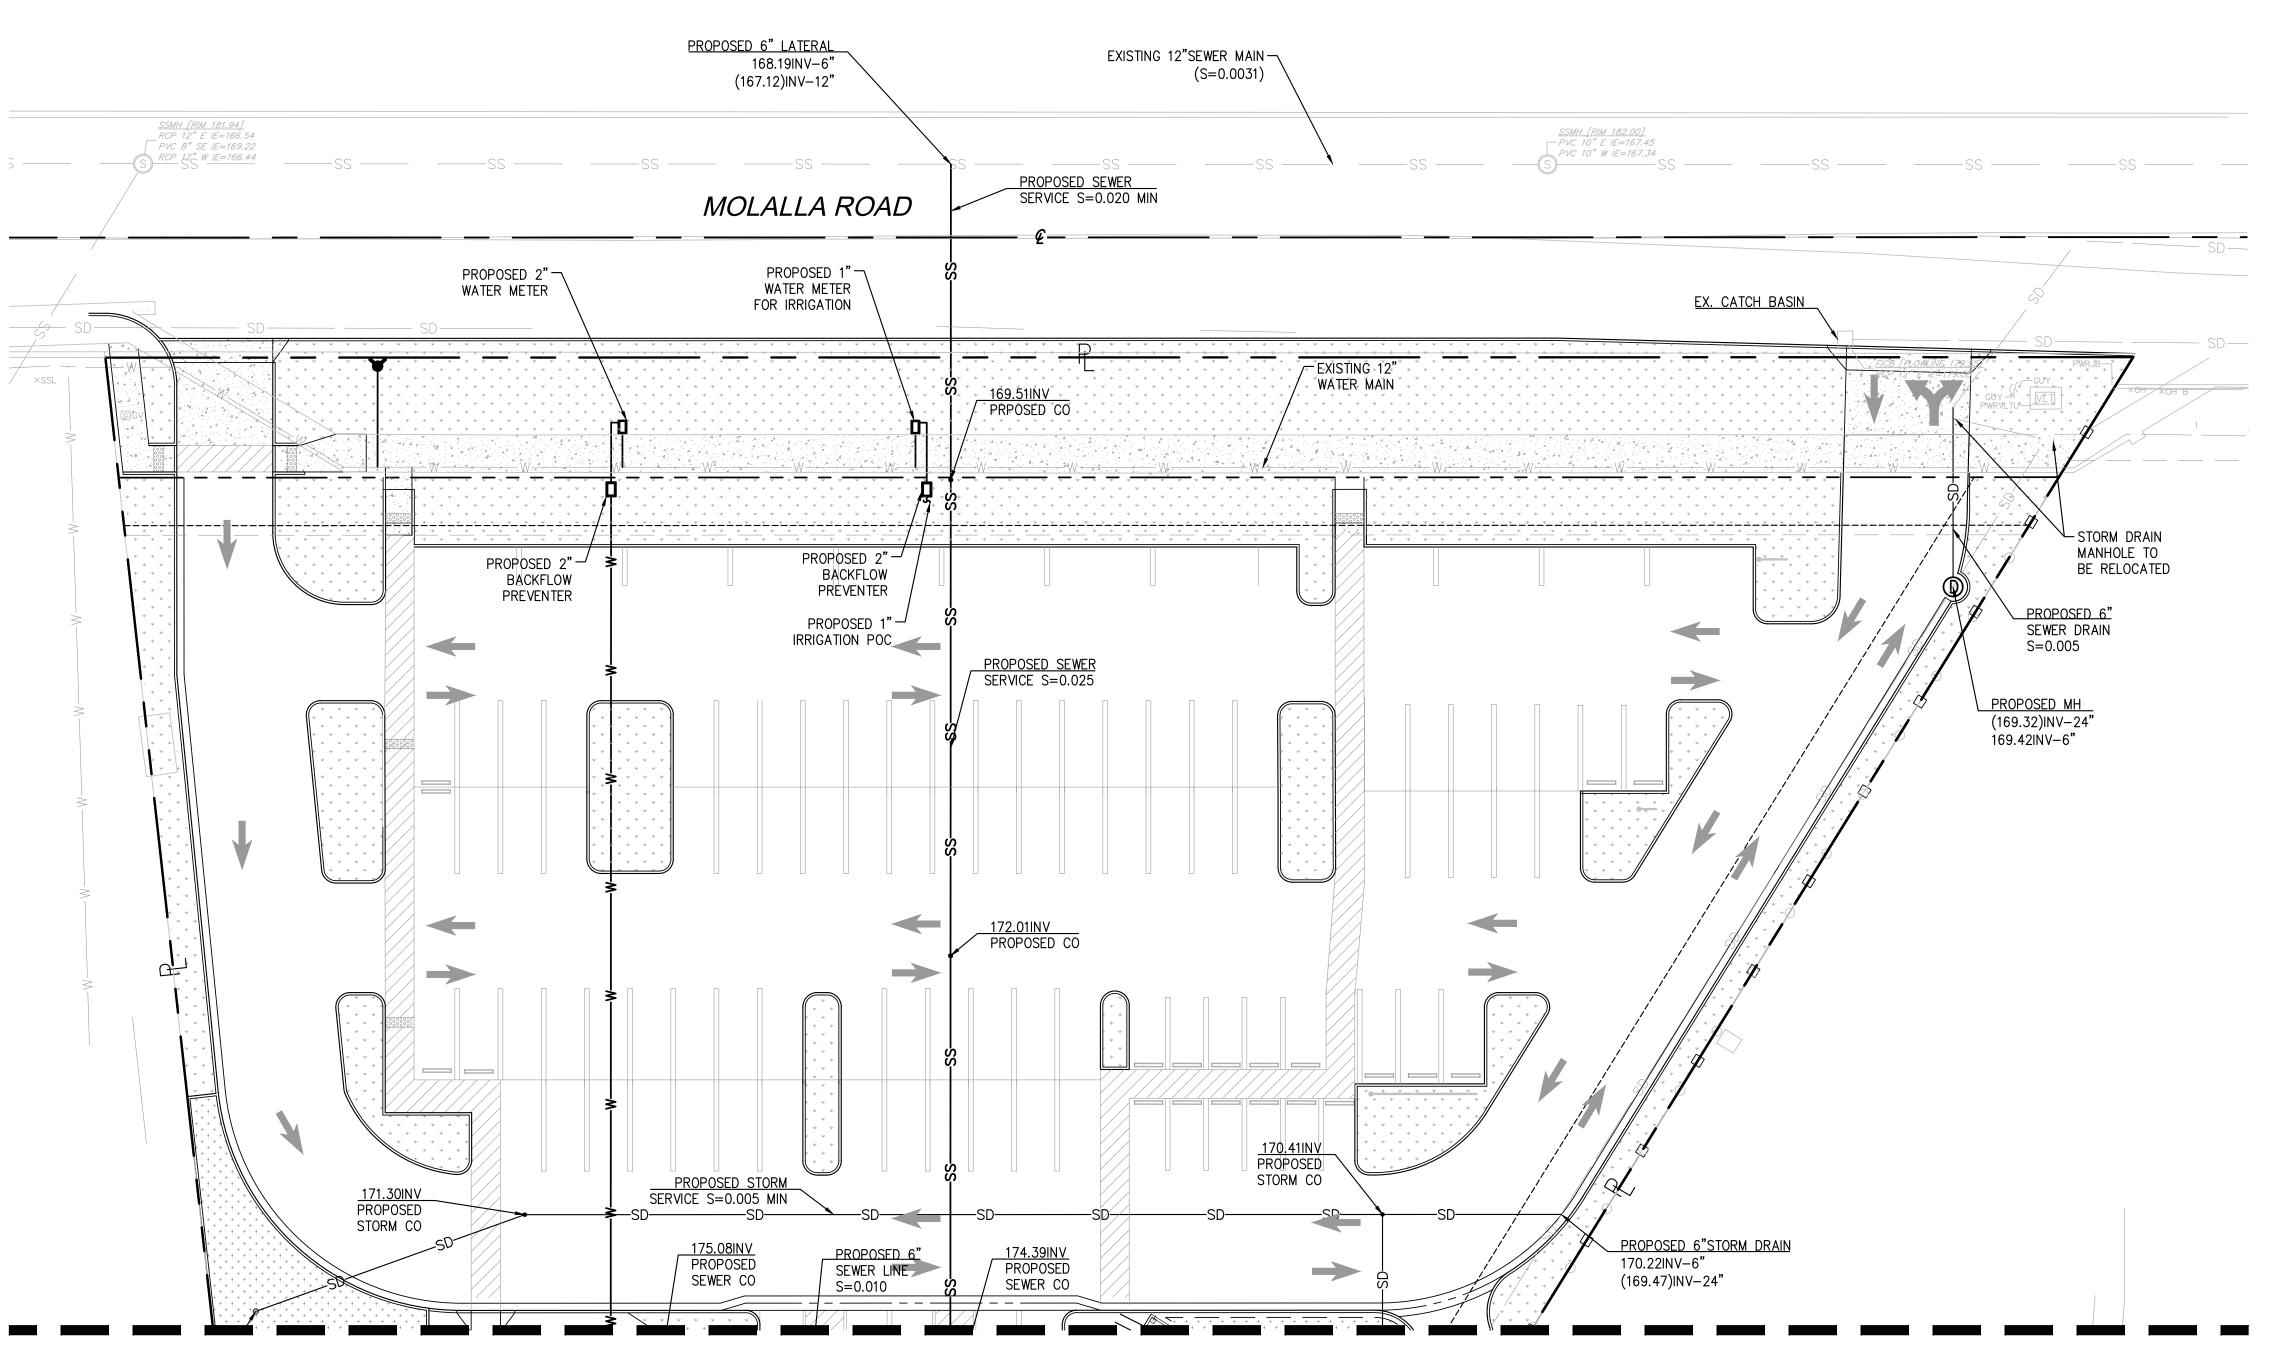
Call the Oregon One-Call Center DIAL 811 or 1-800-332-2344

ENGINEER'S NOTICE TO CONTRACTOR:

THE EXISTENCE AND LOCATION OF ANY UNDERGROUND UTILITIES OR STRUCTURES SHOWN IN THESE PLANS ARE OBTAINED BY A SEARCH OF AVAILABLE RECORDS, AND TO THE BEST OF OUR KNOWLEDGE, THERE ARE NOT EXISTING UTILITIES EXCEPT THOSE SHOWN ON THESE PLANS. THE CONTRACTOR IS REQUIRED TO TAKE ALL PRECAUTIONARY MEASURES TO PROTECT THE UTILITIES SHOWN, AND ANY OTHER LINES OR STRUCTURES NOT SHOWN ON THESE PLANS, AND IS RESPONSIBLE FOR THE PROTECTION OF ANY DAMAGE TO THESE LINES OR STRUCTURES.

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MATCHLINE - SEE SHEET C5.0

LEGEND: SD PROPOSED DRAIN LINE SS PROPOSED SEWER PROPOSED WATER APPROXIMATE LIMITS OF UTILITY REMOVAL PROPOSED AREA DRAIN PROPOSED SEWER CLEANOUT PROPOSED WATER METER

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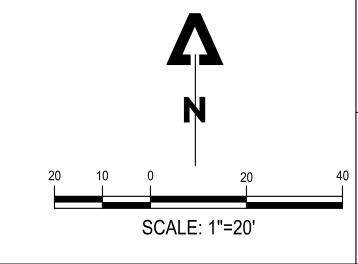
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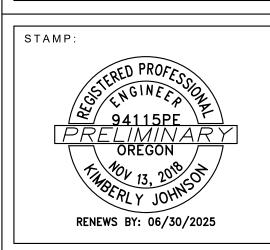
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DATE ISSUE DESCRIPTION

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DRAWINGS WITHOUT WRITTEN
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DIMENSIONS AND NOTES TAKE
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KPOINT 211 FOOD
ION
WOLALLA AVE
BURN, OR 97071

PRELIMINARY
WET UTILITY
PLAN

TE: 104/2025 C 4 .

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MATCHLINE - SEE SHEET C4.0 PROPOSED 6" 171.60INV PROPOSED SEWER LINE S=0.010 PROPOSED WATER POC STORM INLET PROPOSED STORM INLET 175.34 INV , PAVILION 174.87INV PROPOSED SEWER CO 176.00INV PROPOSED SEWER CO 175.48INV PROPOSED 6 SEWER CO 2,808 SF FF=182.00 PROPOSED 6" SEWER LINE S=0.010 PROPOSED WATER POC TYP.11 176.00INV PROPOSED SEWER CO 175.74INV PROPOSED SEWER CO 176.26INV PROPOSED SEWER CO PAVILION 6,500 SF FF=182.00 175.67INV PROPOSED SEWER CO PROPOSED 4" SEWER LATERAL S=0.010 MIN

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176.18INV PROPOSED SEWER CO

176.44NV PROPOSED SEWER CO

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SD—— PROPOSED DRAIN LINE

PROPOSED DRAIN LINE

PROPOSED SEWER

PROPOSED WATER

PROPOSED AREA DRAIN

PROPOSED SEWER CLEANOUT

PROPOSED WATER METER

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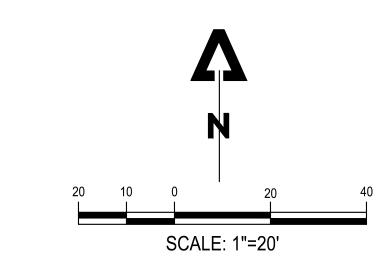
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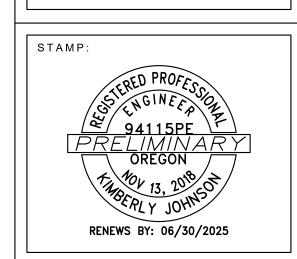
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CHECKPOINT 211 FOOD
PAVILION
SROJECT ADDRESS:
2010 MOLALLA AVE
WOODBURN, OR 97071

PRELIMINARY
WET UTILITY
PLAN

3/04/2025 3/04/2025 C 5 10-10-11 81-92-11 17 29 182-42 182-82-11 17 17

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LEGEND:

—SD——— PROPOSED DRAIN LINE

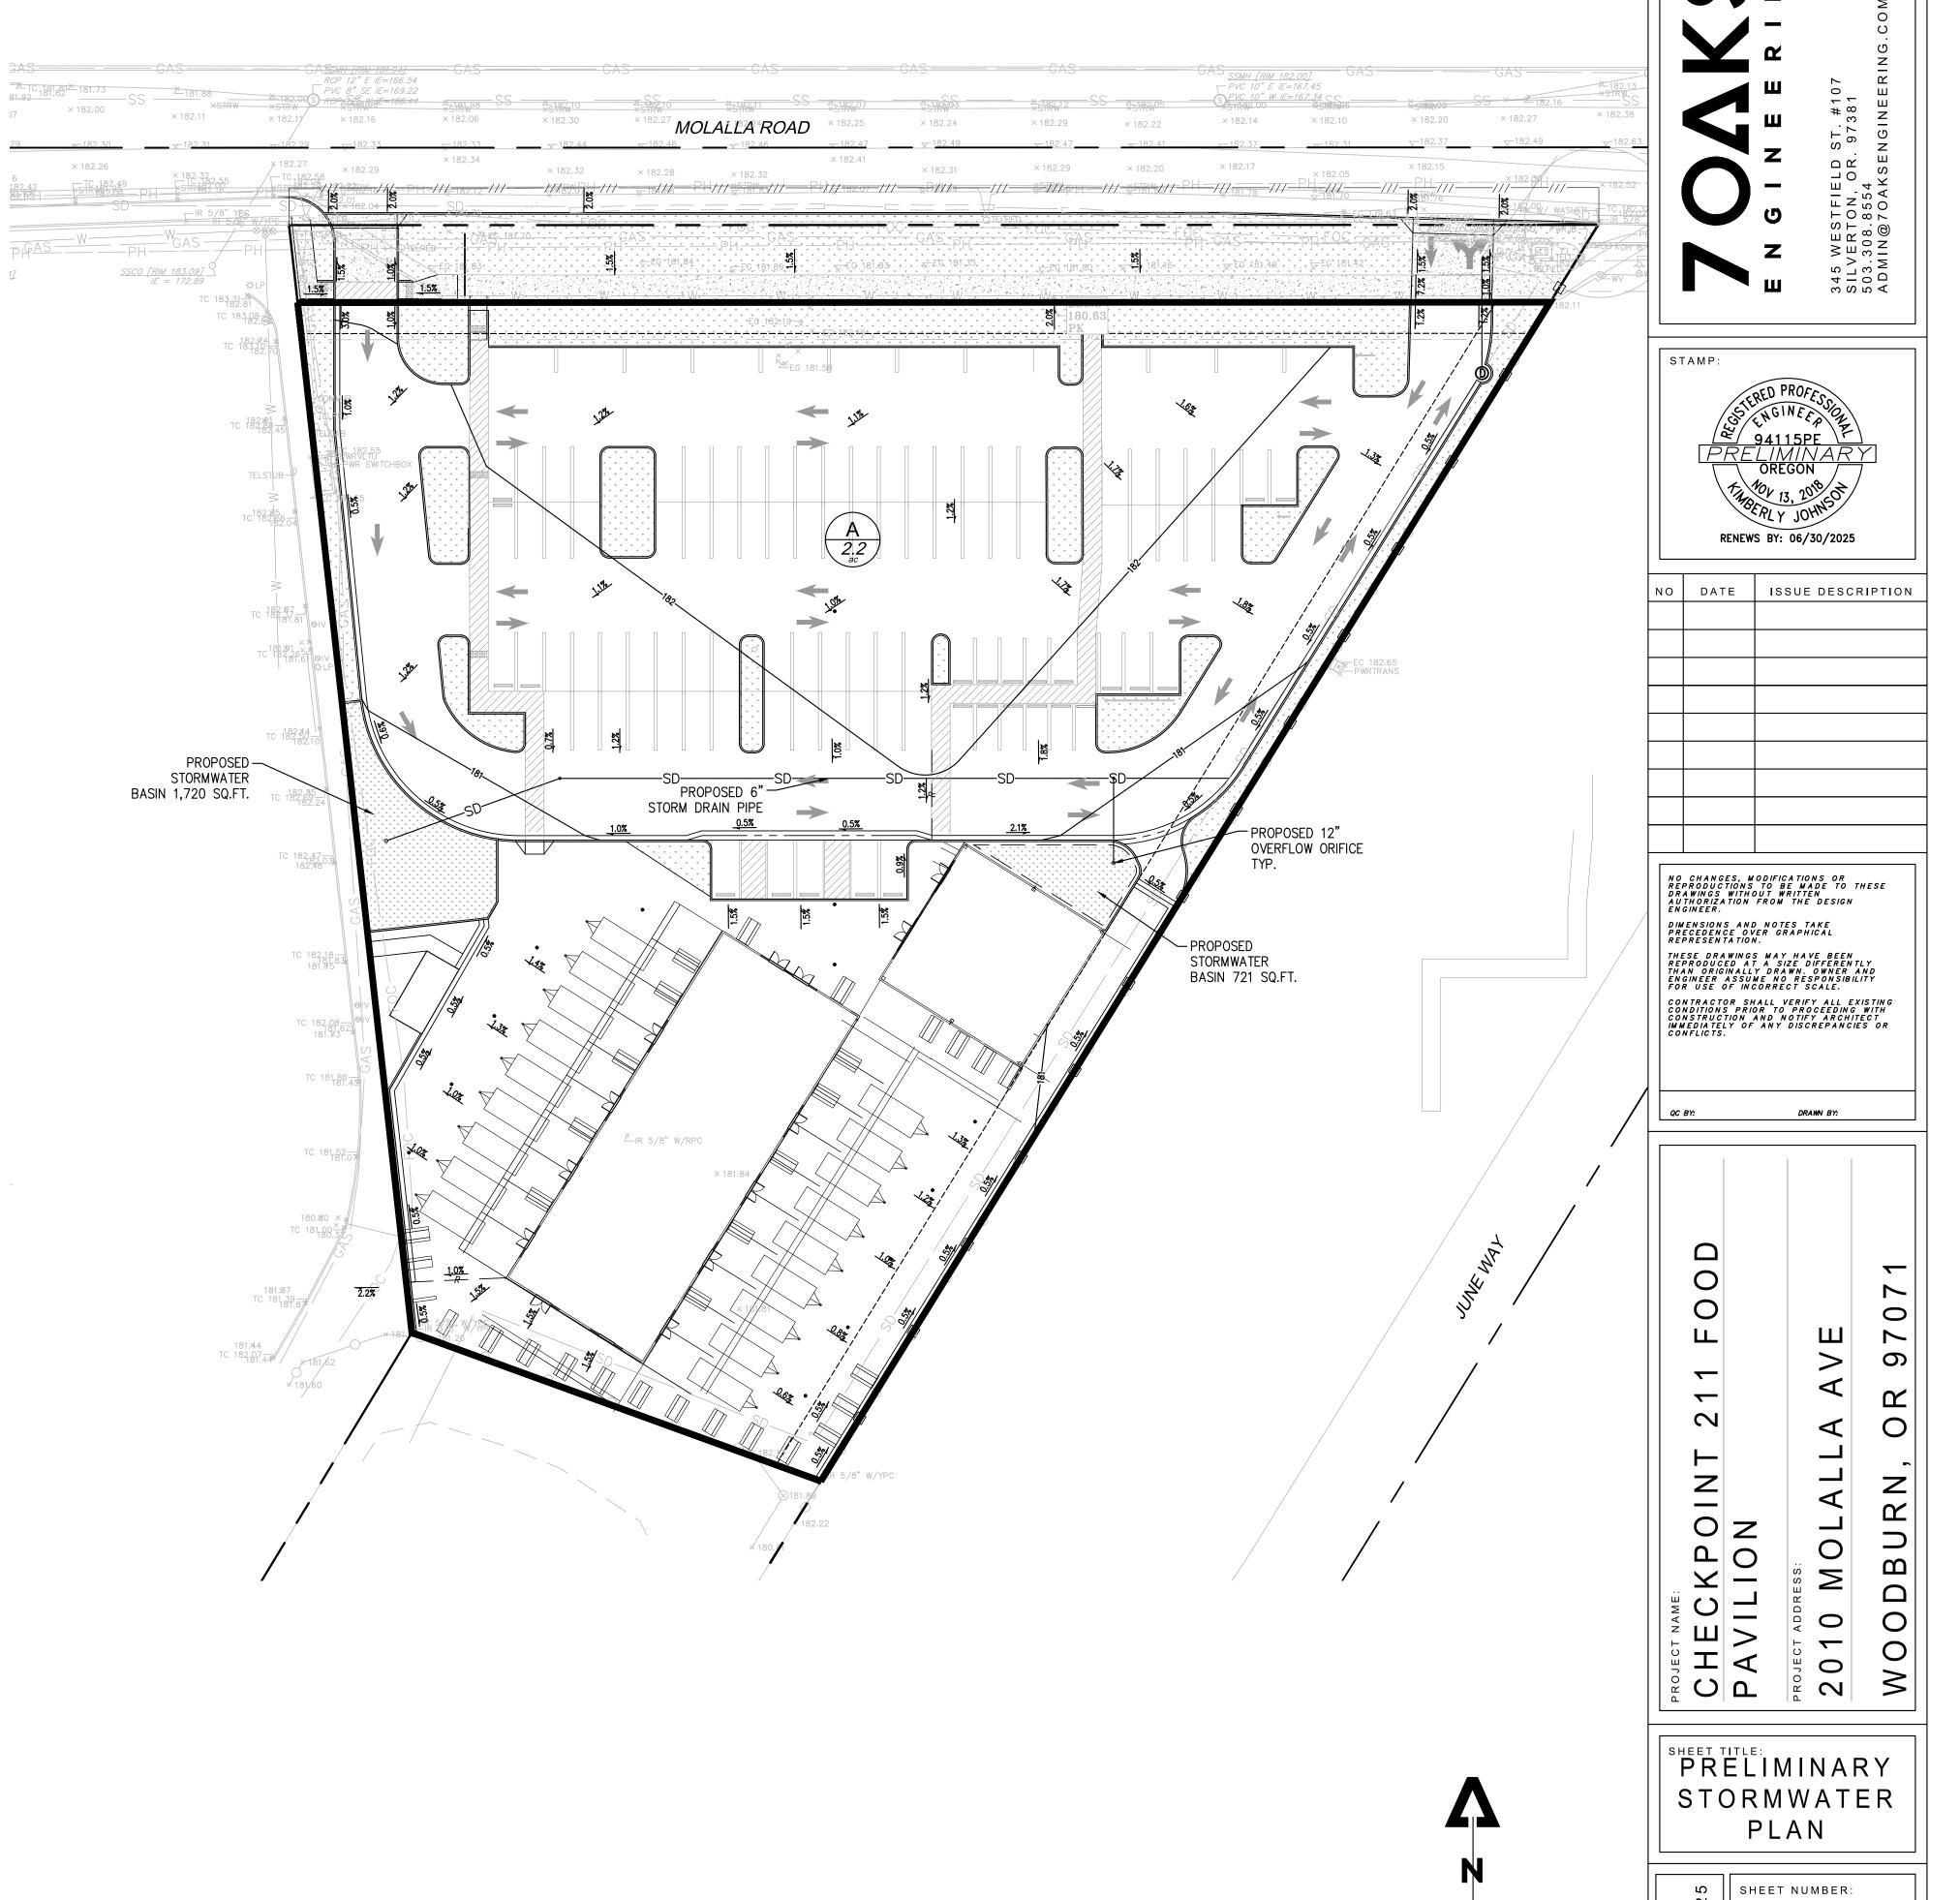
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PROPOSED AREA DRAIN

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SCALE: 1"=30'