

Woodburn Museum / Theater Renovation

455 N. Front St., Woodburn, OR 97071

PERMIT SET 08/12/2021

PERMIT REVISION

09/27/2021



deca architecture.inc 935 SE Alder Street : Portland Oregon 97214 tel 503 239 1987 fax 503 239 6558 deca-inc.com

ABBREVIATIONS

ADDREVIATION	5
2	ANGLE
ç.	CENTERLINE
-	
@ Ø	AT DIAMETER or ROUND
1	PERPENDICULAR SQUARE
	SQUARE
AB	ANCHOR BOLT
AC	AIR CONDITIONING
ACCES	ACCESSORY(IES)
ACOUS	ACOUSTICAL
AD	AREA DRAIN
ADJ	ADJUST(ABLE), ADJACENT
AFF	ABOVE FINISHED FLOOR
AL, ALUM	ALUMINUM
ANOD	ANODIZED
APPR(OX)	APPROXIMATE
ARCH	ARCHITECTURAL
BCS	BABY CHANGING STATION
BCS	BOARD
BLDG	BUILDING
BLKG	BLOCKING
B.O.	BOTTOM OF
B.O.S.	BOTTOM OF STRUCTURE
BOT, BOTT	BOTTOM
BRKT	BRACKET
СВ	CATCH BASIN
CG	CLEAR GLASS
CIG	CLEAR INSULATED GLASS
CJ	CONSTRUCTION/CONTROL JOINT
CL	CENTER LINE
CLG, CEIL	CEILING
CLR	CLEAR
CMU	CONCRETE MASONRY UNIT
COL	COLUMN
CONC	CONCRETE
CONN	CONNECTION
	CONNECTION
CONSTR CONT	CONTINUOUS, CONTINUE
CPT	CARPET
CS	CONCRETE-SEALED
CT	
CTG	CERAMIC TILE CLEAR TEMPERED GLASS
CTIG	CLEAR TEMPERED INSULATED GLASS
0110	
D	DRYER
DB	DOOR BUMPER
DEMO	DEMOLITION
DEPT	DEPARTMENT
DF	DRINKING FOUNTAIN
DIA	DIAMETER
DIST	DISTANCE
DIM, DIMS	DIMENSION(S)
DN	DOWN
DR	DOOR
DS	DOWNSPOUT
DTL, DET	DETAIL
DW	DISHWASHER
DWG	DRAWING
E	EAST
EL	ELEVATION
EJ	EXPANSION JOINT
ELEC(T)	ELECTRIC(AL)
ELEG(T) EP	ELECTRIC(AL)
ELEV	ELEVATOR, ELEVATION
EQ	EQUAL
EQPM, EQUIP	EQUIPMENT
(E), EXIST.	EXISTING
EXT, EXTER	EXTERIOR
FA	FIRE ALARM/HORN/STROBE
FD	FLOOR DRAIN
F.D.	
FE FEC	
FEC	FIRE EXTINGUISHER CABINET FINISHED FLOOR
FFL	FINISHED FLOOR LEVEL
FH	FIRE HYDRANT
FIN	FINISH(ED)
FLR	FLOOR
FDN	FOUNDATION
FOC	FACE OF CONCRETE
FOF	FACE OF FINISH
FOM	FACE OF MASONRY
FOS	FACE OF STUD
F.R.	FIRE RETARDANT
FT	FOOT(FEET)
FTG	FOOTING

GAGE,GAUGE GALV GYP BD, GB, GWB GALVANIZED GYPSUM BOARD HOSE BIBB HANDICAP HDWD HARDWOOD HOR(IZ) HORIZONTAL HEATING, VENTILATING & AIR CONDITIONING HVAC INSIDE DIAMETER, IDENTIFY INCH(ES) INFO INFORMATION INSULATION INSUL INT. INTER INTERIOR JANITOR JOINT K.D.F. KNOCK-DOWN FRAME LAVATORY LIQUID PROPANE LIGHT MACH MACHINE MAX MAXIMUM MECH MECHANICAL MECHANICAL, ELECTRICAL, PLUMBING MEP MFG MANUFACTURE(R)(ING) MINIMUM MISC MISCELLANEOUS METAL PANEL MIRROR MTL METAL MULL MULLION NFW NORTH NOT IN CONTRACT NUMBER NOT TO SCALE ON CENTER occ OCCUPANCY OUTSIDE DIAMETER OFCI OWNER FURNISHED-CONTRACTOR INSTALLED OFOI OWNER FURNISHED-OWNER INSTALLED OPPOSITE HAND OVERFLOW ROOF DRAIN ORD OREGON STATE UNIVERSITY OSU PAINT(ED) P, PTD LΡ PLATE PLYWD PLYWOOD PANEL PAIR POUNDS PER SQUARE INCH POUNDS PER SQUARE FOOT PRESSURE TREATED PVC POLYVINYL CHLORIDE RENOVATE(D)(ION) RISER R, RAD RADIUS RUBBER BASE ROOF DRAIN RDOD ROOF DRAIN OVERFLOW DRAIN REF. REFR REFRIGERATOR REINFORCE(D)(ING) REINF REQ, REQ'D REQUIRE(D)(MENTS) REV REVISION(S)/REVISED ROOM ROUGH OPENING SOUTH SOLID CORE SEALED CEMENTITIOUS TOPPING SECT SECTION SHR SHOWER SHEET SIMILAR STAND PIPE SPECS SPECIFICATIONS SS. SST STAINLESS STEEL STD STANDARD STL STEEL STOR STORAGE STRUC(T) STRUCTURAL SQUARE SUSP CLG SUSPENDED CEILING SYMMETRICAL SYM T, TLT TOILET

GA

HB

HC

ID

IN

JAN

JT

LAV

LP

LT

MIN

MP

MR

(N)

Ν

NIC

NO

NTS OC

OD

OH

PNL

PR

PSI

PSF

PT

(R)

RB

RD

RM

RO

s

SC

SCT

SHT


SIM

SP

SQ

TR

TREAD

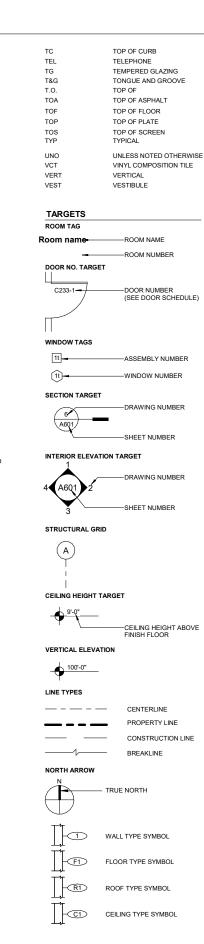

VIF VT	VERIFY IN FIELD VINYL TILE
w	WEST, WASHING MACHINE
W/	WITH
WB	WOOD BASE
WC WCP	WATER CLOSET, WHEELCHAIR WOOD CEILING PANEL
WCV	WALL COVERING
WD	WOOD
WDO WF	WINDOW WOOD FLOOR
W/O	WITHOUT
WP	WOOD PANEL, WATERPROOF
WRB WSF	WATER RESISTANT BARRIER WELDED STEEL FRAME
SYMBOLS	
PLAN VIEW	
7//////////////////////////////////////	NEW FULL HEIGHT WALLS (SEE SHEETS FOR SPECIFIC HATCH)
	EXISTING FULL HEIGHT WALLS
	PARTIAL HEIGHT WALLS
0.0 M	
	ITEMS ABOVE
	ITEM TO BE DEMOLISHED
	AREA DRAIN
	ROOF DRAIN
	OVERFLOW ROOF DRAIN
	CATCH BASIN
0	FLOOR DRAIN
ELEVATION VIEW	
_	
	DUPLEX OUTLET
	SWITCH
	FA PULL STATION
8	TELEPHONE OUTLET
0	THERMOSTAT
	FIRE EXTINGUISHER CABINET
FE	0
	G SYMBOLS
	G SYMBOLS CEILING LUMINAIRE: SURFACE, RECESSED CEILING LUMINAIRE: PENDANT MOUNTED
	G SYMBOLS CEILING LUMINAIRE: SURFACE, RECESSED CEILING LUMINAIRE: PENDANT MOUNTED WALL LUMINAIRE: SURFACE, RECESSED
REFLECTED CEILIN 0 - - ↔ +○ +○ ○+ ○*	G SYMBOLS CEILING LUMINAIRE: SURFACE, RECESSED CEILING LUMINAIRE: PENDANT MOUNTED WALL LUMINAIRE: SURFACE, RECESSED WALL WASHER: SURFACE RECESSED
	G SYMBOLS CEILING LUMINAIRE: SURFACE, RECESSED CEILING LUMINAIRE: PENDANT MOUNTED WALL LUMINAIRE: SURFACE, RECESSED WALL WASHER: SURFACE RECESSED TRACK WITH HEADS LOCATED
REFLECTED CEILIN 0 - - ↔ +○ +○ ○+ ○*	G SYMBOLS CEILING LUMINAIRE: SURFACE, RECESSED CEILING LUMINAIRE: PENDANT MOUNTED WALL LUMINAIRE: SURFACE, RECESSED WALL WASHER: SURFACE RECESSED
REFLECTED CEILIN 0 - - ↔ +○ +○ ○+ ○*	G SYMBOLS CEILING LUMINAIRE: SURFACE, RECESSED CEILING LUMINAIRE: PENDANT MOUNTED WALL LUMINAIRE: SURFACE, RECESSED WALL WASHER: SURFACE RECESSED TRACK WITH HEADS LOCATED
	G SYMBOLS CEILING LUMINAIRE: SURFACE, RECESSED CEILING LUMINAIRE: PENDANT MOUNTED WALL LUMINAIRE: SURFACE, RECESSED WALL WASHER: SURFACE RECESSED TRACK WITH HEADS LOCATED FLUORESCENT LUMINAIRE: SURFACE, RECESSED FLUORESCENT LUMINAIRE: WALL MOUNTED,
	G SYMBOLS CEILING LUMINAIRE: SURFACE, RECESSED CEILING LUMINAIRE: PENDANT MOUNTED WALL LUMINAIRE: SURFACE, RECESSED WALL WASHER: SURFACE RECESSED TRACK WITH HEADS LOCATED FLUORESCENT LUMINAIRE: SURFACE, RECESSED FLUORESCENT LUMINAIRE: WALL MOUNTED, PENDANT LINEAR FLUORESCENT LUMINAIRE: WALL MOUNTED
	G SYMBOLS CEILING LUMINAIRE: SURFACE, RECESSED CEILING LUMINAIRE: PENDANT MOUNTED WALL LUMINAIRE: SURFACE, RECESSED WALL WASHER: SURFACE RECESSED TRACK WITH HEADS LOCATED FLUORESCENT LUMINAIRE: SURFACE, RECESSED FLUORESCENT LUMINAIRE: WALL MOUNTED, PENDANT
	G SYMBOLS CEILING LUMINAIRE: SURFACE, RECESSED CEILING LUMINAIRE: PENDANT MOUNTED WALL LUMINAIRE: SURFACE, RECESSED WALL WASHER: SURFACE RECESSED TRACK WITH HEADS LOCATED FLUORESCENT LUMINAIRE: SURFACE, RECESSED FLUORESCENT LUMINAIRE: WALL MOUNTED, PENDANT LINEAR FLUORESCENT LUMINAIRE: WALL MOUNTED
	G SYMBOLS CEILING LUMINAIRE: SURFACE, RECESSED CEILING LUMINAIRE: PENDANT MOUNTED WALL LUMINAIRE: SURFACE, RECESSED WALL WASHER: SURFACE RECESSED TRACK WITH HEADS LOCATED FLUORESCENT LUMINAIRE: SURFACE, RECESSED FLUORESCENT LUMINAIRE: WALL MOUNTED, PENDANT LINEAR FLUORESCENT LUMINAIRE: WALL MOUNTED
	G SYMBOLS CEILING LUMINAIRE: SURFACE, RECESSED CEILING LUMINAIRE: PENDANT MOUNTED WALL LUMINAIRE: SURFACE, RECESSED WALL WASHER: SURFACE, RECESSED TRACK WITH HEADS LOCATED FLUORESCENT LUMINAIRE: SURFACE, RECESSED FLUORESCENT LUMINAIRE: WALL MOUNTED, PENDANT LINEAR FLUORESCENT LUMINAIRE: WALL MOUNTED FLUORESCENT LUMINAIRE: BARE LAMP POLE LIGHT: LUMINAIRES AS SHOWN
	G SYMBOLS CEILING LUMINAIRE: SURFACE, RECESSED CEILING LUMINAIRE: PENDANT MOUNTED WALL LUMINAIRE: SURFACE, RECESSED WALL WASHER: SURFACE, RECESSED TRACK WITH HEADS LOCATED FLUORESCENT LUMINAIRE: SURFACE, RECESSED FLUORESCENT LUMINAIRE: WALL MOUNTED, PENDANT LINEAR FLUORESCENT LUMINAIRE: WALL MOUNTED FLUORESCENT LUMINAIRE: BARE LAMP POLE LIGHT: LUMINAIRE: AS SHOWN DESIGNATES LIGHT ON EMERGENCY CIRCUIT
	G SYMBOLS CEILING LUMINAIRE: SURFACE, RECESSED CEILING LUMINAIRE: PENDANT MOUNTED WALL LUMINAIRE: SURFACE, RECESSED WALL WASHER: SURFACE, RECESSED TRACK WITH HEADS LOCATED FLUORESCENT LUMINAIRE: SURFACE, RECESSED FLUORESCENT LUMINAIRE: WALL MOUNTED, PENDANT LINEAR FLUORESCENT LUMINAIRE: WALL MOUNTED FLUORESCENT LUMINAIRE: BARE LAMP POLE LIGHT: LUMINAIRES AS SHOWN DESIGNATES LIGHT ON EMERGENCY CIRCUIT EXIT LIGHT: CEILING, WALL (ARROWS AS SHOWN) EMERGENCY BATTERY LIGHT: HEADS AS SHOWN
	CEILING LUMINAIRE: SURFACE, RECESSED CEILING LUMINAIRE: PENDANT MOUNTED WALL LUMINAIRE: PENDANT MOUNTED WALL WASHER: SURFACE, RECESSED WALL WASHER: SURFACE, RECESSED TRACK WITH HEADS LOCATED FLUORESCENT LUMINAIRE: SURFACE, RECESSED FLUORESCENT LUMINAIRE: WALL MOUNTED, PENDANT LINEAR FLUORESCENT LUMINAIRE: WALL MOUNTED POLE LIGHT: LUMINAIRE: BARE LAMP POLE LIGHT: LUMINAIRE: AS SHOWN DESIGNATES LIGHT ON EMERGENCY CIRCUIT EXIT LIGHT: CEILING, WALL (ARROWS AS SHOWN) EMERGENCY BATTERY LIGHT: HEADS AS SHOWN
	CEILING LUMINAIRE: SURFACE, RECESSED CEILING LUMINAIRE: PENDANT MOUNTED WALL LUMINAIRE: PENDANT MOUNTED WALL WASHER: SURFACE, RECESSED WALL WASHER: SURFACE, RECESSED TRACK WITH HEADS LOCATED FLUORESCENT LUMINAIRE: SURFACE, RECESSED FLUORESCENT LUMINAIRE: WALL MOUNTED, PENDANT LINEAR FLUORESCENT LUMINAIRE: WALL MOUNTED POLE LIGHT: LUMINAIRE: BARE LAMP POLE LIGHT: LUMINAIRE: AS SHOWN DESIGNATES LIGHT ON EMERGENCY CIRCUIT EXIT LIGHT: CEILING, WALL (ARROWS AS SHOWN) EMERGENCY BATTERY LIGHT: HEADS AS SHOWN
	CEILING LUMINAIRE: SURFACE, RECESSED CEILING LUMINAIRE: PENDANT MOUNTED WALL LUMINAIRE: PENDANT MOUNTED WALL WASHER: SURFACE, RECESSED WALL WASHER: SURFACE, RECESSED TRACK WITH HEADS LOCATED FLUORESCENT LUMINAIRE: SURFACE, RECESSED FLUORESCENT LUMINAIRE: WALL MOUNTED, PENDANT LINEAR FLUORESCENT LUMINAIRE: WALL MOUNTED, PENDANT LINEAR FLUORESCENT LUMINAIRE: WALL MOUNTED POLE LIGHT: LUMINAIRE: BARE LAMP POLE LIGHT: LUMINAIRE: AS SHOWN DESIGNATES LIGHT ON EMERGENCY CIRCUIT EXIT LIGHT: CEILING, WALL (ARROWS AS SHOWN) EMERGENCY BATTERY LIGHT: HEADS AS SHOWN SPRINKLER HEAD SUPPLY AIR DIFFUSER
	CEILING LUMINAIRE: SURFACE, RECESSED CEILING LUMINAIRE: PENDANT MOUNTED WALL LUMINAIRE: PENDANT MOUNTED WALL WASHER: SURFACE, RECESSED WALL WASHER: SURFACE, RECESSED TRACK WITH HEADS LOCATED FLUORESCENT LUMINAIRE: SURFACE, RECESSED FLUORESCENT LUMINAIRE: WALL MOUNTED, PENDANT LINEAR FLUORESCENT LUMINAIRE: WALL MOUNTED POLE LIGHT: LUMINAIRE: BARE LAMP POLE LIGHT: LUMINAIRE: AS SHOWN DESIGNATES LIGHT ON EMERGENCY CIRCUIT EXIT LIGHT: CEILING, WALL (ARROWS AS SHOWN) EMERGENCY BATTERY LIGHT: HEADS AS SHOWN
$\begin{array}{c} \bullet \\ \bullet $	CEILING LUMINAIRE: SURFACE, RECESSED CEILING LUMINAIRE: PENDANT MOUNTED WALL LUMINAIRE: PENDANT MOUNTED WALL WASHER: SURFACE, RECESSED WALL WASHER: SURFACE, RECESSED TRACK WITH HEADS LOCATED FLUORESCENT LUMINAIRE: SURFACE, RECESSED FLUORESCENT LUMINAIRE: WALL MOUNTED, PENDANT LINEAR FLUORESCENT LUMINAIRE: WALL MOUNTED, PENDANT LINEAR FLUORESCENT LUMINAIRE: WALL MOUNTED POLE LIGHT: LUMINAIRE: BARE LAMP POLE LIGHT: LUMINAIRE: AS SHOWN DESIGNATES LIGHT ON EMERGENCY CIRCUIT EXIT LIGHT: CEILING, WALL (ARROWS AS SHOWN) EMERGENCY BATTERY LIGHT: HEADS AS SHOWN SPRINKLER HEAD SUPPLY AIR DIFFUSER
$\begin{array}{c} \bullet \\ \bullet $	CEILING LUMINAIRE: SURFACE, RECESSED CEILING LUMINAIRE: PENDANT MOUNTED WALL LUMINAIRE: PENDANT MOUNTED WALL WASHER: SURFACE, RECESSED WALL WASHER: SURFACE, RECESSED TRACK WITH HEADS LOCATED FLUORESCENT LUMINAIRE: SURFACE, RECESSED FLUORESCENT LUMINAIRE: WALL MOUNTED, FENDANT LINEAR FLUORESCENT LUMINAIRE: WALL MOUNTED POLE LIGHT: LUMINAIRE: BARE LAMP POLE LIGHT: LUMINAIRE: BARE LAMP POLE LIGHT: CEILING, WALL (ARROWS AS SHOWN) DESIGNATES LIGHT ON EMERGENCY CIRCUIT EXIT LIGHT: CEILING, WALL (ARROWS AS SHOWN) EXHAUST FAN SPRINKLER HEAD SUPPLY AIR DIFFUSER RETURN AIR
$\begin{array}{c} \bullet \\ \bullet $	CEILING LUMINAIRE: SURFACE, RECESSED CEILING LUMINAIRE: PENDANT MOUNTED WALL LUMINAIRE: PENDANT MOUNTED WALL WASHER: SURFACE, RECESSED WALL WASHER: SURFACE, RECESSED TRACK WITH HEADS LOCATED FLUORESCENT LUMINAIRE: SURFACE, RECESSED FLUORESCENT LUMINAIRE: WALL MOUNTED, FENDANT LINEAR FLUORESCENT LUMINAIRE: WALL MOUNTED POLE LIGHT: LUMINAIRE: BARE LAMP POLE LIGHT: LUMINAIRE: BARE LAMP POLE LIGHT: CEILING, WALL (ARROWS AS SHOWN) DESIGNATES LIGHT ON EMERGENCY CIRCUIT EXIT LIGHT: CEILING, WALL (ARROWS AS SHOWN) EXHAUST FAN SPRINKLER HEAD SUPPLY AIR DIFFUSER RETURN AIR

VHI

VERY HIGH IMPACT

MATERIALS

PLAN, REFLECTED CEILING, AND ELEVATION VIEW CONCRETE Se para and WALK-OFF MAT METAL PANEL SYSTEM SUSPENDED GYPSUM BOARD CEILING UNO CP-CEMENT PLASTER GP-GYPSUM PLASTER FIBER CEMENT PANEL SYSTEM METAL MESH GLASS /// PROJECT TEAM ARCHITECT DECA Architecture Inc. 935 SE Alder Street Portland, OR 97062 Tel: (503) 239-1987 David Hyman / hyman@deca-inc.com Meredith Curran / Curran@deca-inc.com CLIENT Jesse Cuomo / Ph. (503) 982-5266 VICINITY MAP

		strate
	WOODBURN	*1+C
	Park Woodburns	
	Woodburn Pater Pater	
Vicobers Agusto Destor	And	Contraction of the second
Settemar Pak		

GENERAL		
000	COVER SHEET	
G001	DRAWING INDEX, ABBREVIATIONS & LEGEN	
G002	CODE SHEET	
G003	LIFE SAFETY PLAN	
ARCHITECTURAL		

AF

A001	ARCHITECTURAL SITE PLAN
A101	DEMOLITION PLAN
A102	OVERALL FLOOR PLAN
A201	REFLECTED CEILING PLAN
A202	REFLECTED CEILING PLAN LEGEND
A501	INTERIOR ELEVATIONS - MUSEUM
A502	INTERIOR ELEVATIONS - THEATER
A503	INTERIOR ELEVATIONS - ACCESSIBILITY CI
A601	DETAILS - INTERIOR
A602	DETAILS - INTERIOR
A603	DETAILS - INTERIOR
A700	FINISH & POWER PLAN
A701	ROOM FINISH LEGEND, SCHEDULE AND MA
	SCHEDULE
A702	SPECIFICATIONS
A703	SHIP LADDER SPECIFICATION



deca architecture.inc

935 SE Alder Street : Portland Oregon 97214 tel 503 239 1987 fax 503 239 6558 deca-inc.com



Woodburn Museum / Theater Renovation

455 N. Front St., Woodburn, OR 97071

SECTION VIEW

\boxtimes	ACOUSTIC WALL/CLG. PANEL
	CONCRETE
	STEEL
	ALUMINUM
<u>I</u>	FINISH WOOD
\ge	ROUGH WOOD
	BATT INSULATION
	RIGID INSULATION
	WOOD SHEATHING (PLYWD)
	GYPSUM BOARD
	WOOD PANEL (MDF)
	GLASS

DEFERRED SUBMITTALS

THE FOLLOWING ARE DESIGN- BUILD AND SUBMITTED BY TRADE:

MECHANICAL
ELECTRICAL
PLUMBING ~~~~~~~~~~~~~~~~~~~~~~~~~~~~~~~~~~~~
STRUCTURAL AS REQUIRED



Issue	Revision	Date
PERMIT SET		08/12/21
PERMIT REVISION	1	09/27/2021

ND

LEARANCES


ATERIAL & DOOR


DRAWING INDEX. **ABBREVIATIONS &** LEGEND

Scale Date

As indicated 08/12/2021

G001

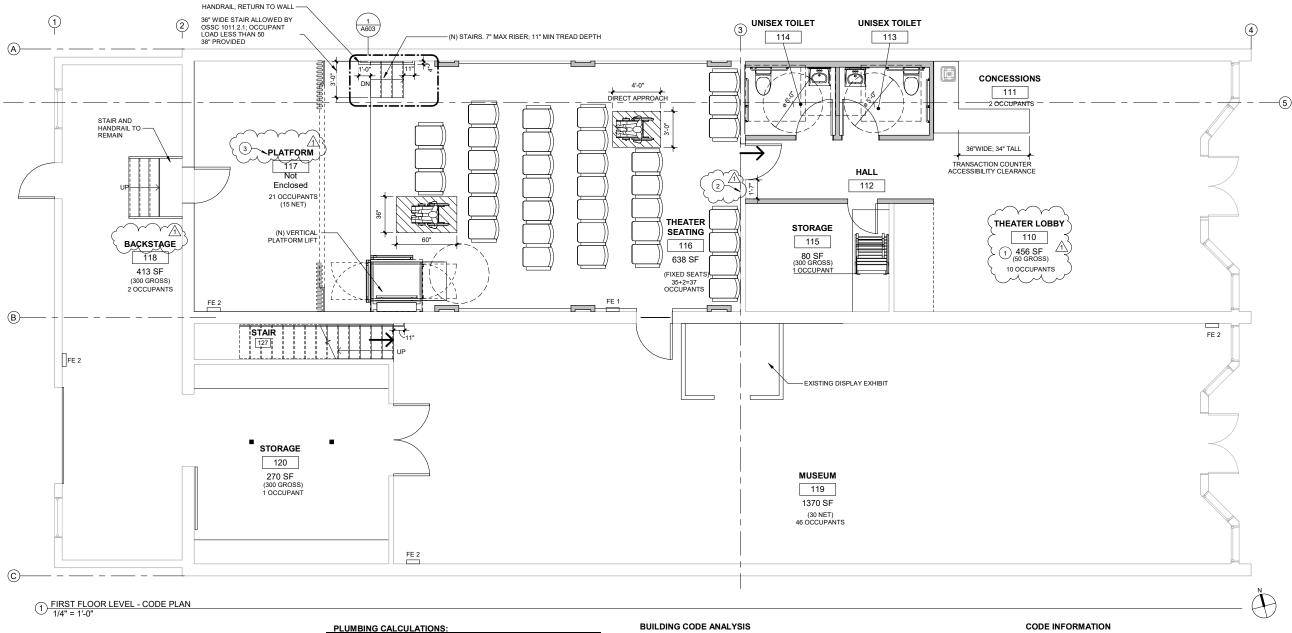

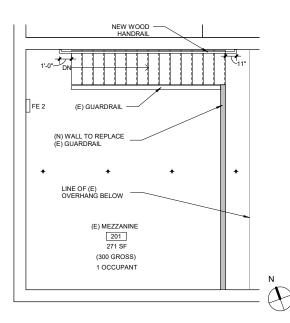


2 MEZZANINE LEVEL CODE PLAN - MUSEUM 1/4" = 1'-0"

TOTAL BUILDING OCCUPANTS: 137 (69M; 69F) OCCUPANCY TYPE: REQ'D WATER CLOSETS ASSEMBLY (THEATER 1 PER 125 MALE AND MUSEUM) 1 PER 65 FEMALE

PROPOSED 2 UNISEX RESTROOMS

REQ'D LAVATORIES PROPOSED 1 PER 200 MALE 1 PER 200 FEMALE 1 PER RESTROOM

THE (2) PROPOSED ADA RESTROOMS REPLACE (1) NON-ACCESSIBLE RESTROOM DRINKING FOUNTAIN NOT REQUIRED AS WATER IS AVAILABLE AT CONCESSION STAND.

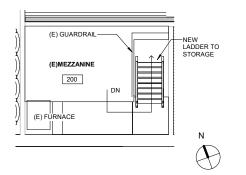

③ <u>MEZZANINE LEVEL CODE PLAN - THEATE</u>R STORAGE 1/4" = 1'-0"

BUI	BUILDING CODE ANALYSIS					
	504/506 ALLOWABLE HEIGHT AND AREA					
	JLAR AREA (TYPE III-B)					
THE	508.3 NONSEPARATED OCCUPANCIES THE BUILDING IS NON-SEPARATED. THE ALLOWABLE BUILDING AREA, HEIGHT, AND NUMBER OF STORIES ARE BASED ON THE OCCUPANCY GROUP WITH THE MOST RESTRICTVE ALLOWANCES, GROUP A-3.					
<u>602 (</u>	602 CONSTRUCTION CLASSIFICATION TYPE III-B (NON-SPRINKLERED) TWO HOUR RATED EXTERIOR WALLS REQUIRED, TABLE 601.					
	<u>903 AUTOMATIC SPRINKLER SYSTEM</u> AUTOMATIC SPRINKLER SYSTEM IS NOT REQUIRED FOR GROUP A-3 WITH OCCUPANCY LOAD < 300.					
	2019 OSSC 1604.5 RISK CATEGORY EXISTING BUILDING IS CAT 11; NEW WORK IN BUILDING MAINTAINS CAT 11 - NO CHANGE IN RISK CATEGORY.					
	OCCUPANT LOAD - MUSEUM					
NO.	ROOM	AREA	FACTOR	TOTAL OCCUPANTS		
119	(E) MUSEUM	1368 SF	30	46		
120	(E) STORAGE	270 SF	300	1]	
127	STAIR 2	50 SF				
201	(E) MEZZANINE	271 SF	300	1		
4	TOTAL	1959 SF		48		

OCCUPANT LOAD - THEATER
 No.
 ROOM
 AREA
 FACTOR
 TOTAL OCCUPANTS

 110
 THEATER LOBBY
 456 SF
 30
 10
 (SEE NOTE 1)

 111
 CONCESSIONS
 68 SF
 60
 2
 4
 12 HALL 13 UNISEX TOILET 42 SF 114 UNISEX TOILET 42 SF 15 STORAGE 80 SF 16 THEATER SEATING 638 SF 35 FIXED 117 PLATFORM 118 BACKSTAGE 215 MEZZ. STORAGE 0 SF 413 SF 0 SF 10 TOTAL 1811 SF

CODE INFORMATION

EXISTING MUSEUM: A3 EXISTING THEATER: A1

NON-SPRINKLERED BUILDING

APPLICABLE CODES:

8	KEY	NOTES
<	$\begin{pmatrix} 1 \\ 2 \end{pmatrix}$	LOBBY OCCUPANTS ARE A NOT BE COUNTED TWICE; POSTED OCCUPANCY TO E
Ę	3 ~~~~~~~~~~~~~~~~~~~~~~~~~~~~~~~~~~~~	THIS IS A PLATFORM PER C AREN'T ANY SCENERY DOC CURTAINS.


FLOOR PLAN LEGEND

EXISTING CONSTRUCTION TO REMAIN NEW CONSTRUCTION

(# OCC OCCUPANTS PER EXIT

PROJECT DESCRIPTION: THIS IS PRIMARILY A REPLACEMENT OF INTERIOR FINISHES AND ADA IMPROVEMENTS. MUSEUM: NEW FINISHES ONLY, AND REPLACEMENT LIGHT FIXTURES. THEATER: NEW ADA RESTROOMS AND WHEELCHAIR ACCESS TO STAGE, NEW LIGHTING, NEW FINISHES THROUGHOUT.

OCCUPANCY CLASSIFICATION; PREVIOUS TO REMAIN

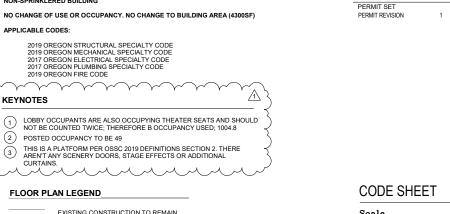



deca architecture.inc

935 SE Alder Street : Portland Oregon 97214 tel 503 239 1987 fax 503 239 6558 deca-inc.com



Woodburn Museum / Theater Renovation

455 N. Front St., Woodburn, OR 97071

Scale Date



Sheet No.


Issue


Revision

Date

08/12/21

09/27/2021

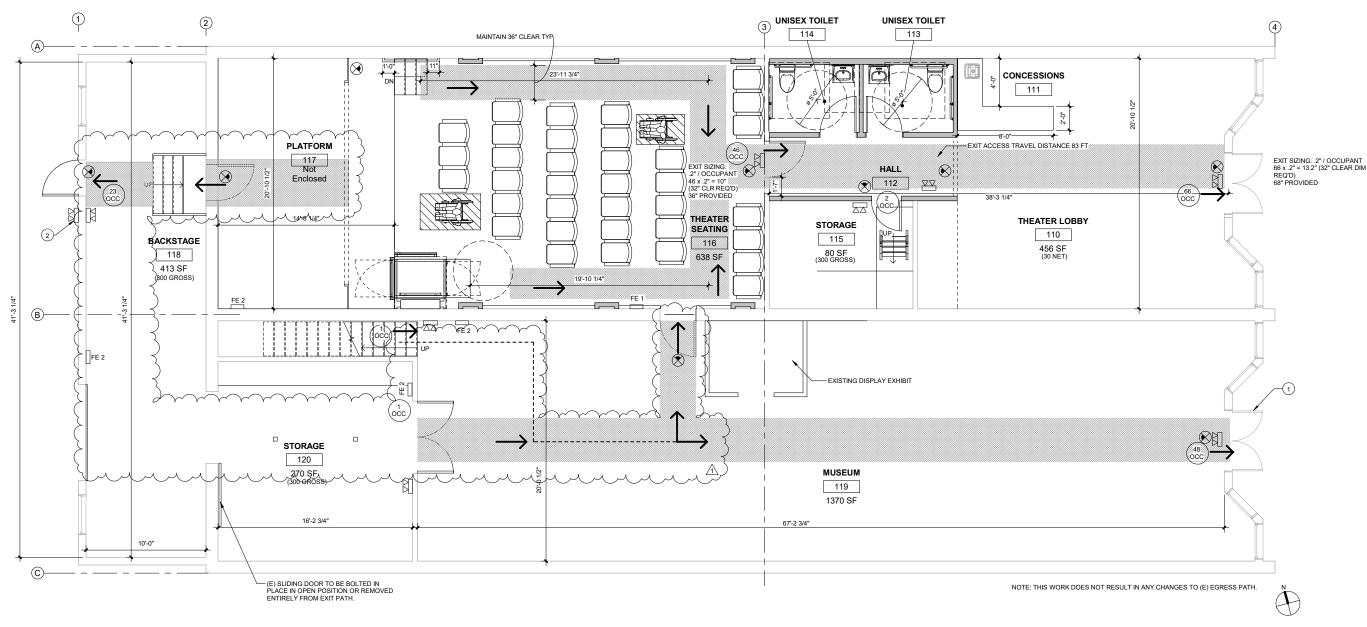

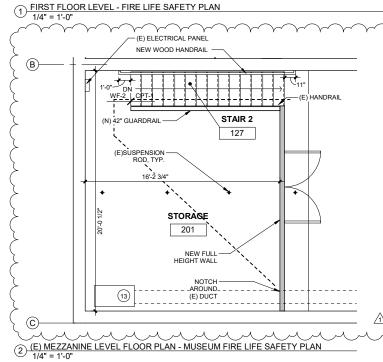

ADA ALTERATIONS

ORS 447.241

ORS 447.241 3403 2019 OSSC / IEBC 305.7 ADA REQUIREMENTS FOR ALTERATIONS IN A BUILDING ALL NEW WORK COMPLIES ADA REQUIREMENTS FC. WITH OSSC CHAPTER 11.

- PRIMARY USE ARE IN FULL COMPLIANCE
- PARKING : NONE PROVIDED: DOWNTOWN LOCATION WITH STREET PARKING
- EXTERIOR APPROACH: LEVEL SIDEWALKS AND GROUND LEVEL ENTRY DOOR ARE EXISTING

ROUTE TO PRIMARY FUNCTION: MUSEUM AND THEATER ARE ON THE GROUND FLOOR, WITH A LEVEL ENTRY TO THE BUILDING, LEVEL AND CLEAR PATH TO EXHIBIT AND THEATER SEATING. ENTRY DOOR WITH ADA ACCESSIBLE HARDWARE, NEW PANIC HARDWARE FOR EGRESS PROVIDED AT THEATER.

INSTALLING NEW ACCESSIBLE TOILET ROOMS PER CHAPTER 11 OF THE OSSC; ANSI AND AMERICANS WITH DISABILITIES ACT, PROVIDING 2 UNISEX SINGLE USE ACCESSIBLE ROOMS, WITH ALL NEW ADA- COMPLIANT TOILET EQUIPMENT/ ACCESSORIES.

• FURNISH AND INSTALL AN AUTOMATED LIFT FROM THE THEATER AISLE TO THE STAGE FOR ACCESSIBILITY.

ESTIMATED COST OF IMPROVEMENTS RELATED TO APPROACH: \$42,000 MEETS 25% OF THE COSTS OF THE ALTERATIONS AFFECTING THE PRIMARY AREAS OF FUNCTION, ESTIMATED AT \$160,000 BUDGET.

HAZARDOUS MATERIALS

ASBESTOS CONTAINING MATERIALS WILL BE ABATED BY OWNER PRIOR TO THIS PROJECT

KEYNOTES

- 1 EXISTING HISTORIC DOORS; PAIR IS OPERABLE TO CREATE OPENING; EXISTING HEIGHT IS 80" CLEAR
- (2) PROVIDE NEW EXTERIOR BATTERY BACK- UP LIGHT AT EXIT

FIRE RATINGS

1. ALL NEW MATERIALS TO MEET COMMERCIAL LEVELS FOR FIRE RESISTANCE, NFPA 701. 253 & 253: AND ASTM E84

2. NEW THEATER SEATING: THEATER SEAT STORE, MODEL "MEDALLION" WITH SEAT FABRIC "DILLON" 100% POLYURETHANE. THIS FABRIC PASSES CA STANDARD TB117-2013; UFAC CLASS I ; NFPA 260 CLASS I; MVSS 302 PASS.

3. NEW STAGE DRAPERY IS SAARIA BRAND, STYLE SS1 (VERIFY); PASSES NFPA 701, TEST METHOD 1-2015 EDITION

SMOKE DETECTOR

 $\sqrt{1}$

LOCAL DETECTORS NOT CONNECTED TO FIRE STATION. ELECTRICIAN TO PROVIDE SPECIFICATION FOR DETECTOR THAT MEETS LOCAL JURISDICTION CODE.

SMOKE ALARMS SHALL CONTACT OWNER'S SECURITY VENDOR, WILLAMETTE VALLEY SECURITY.

FLOOR PLAN LEGEND

FE 1 FE 2 \otimes EXIT SIGNAGE (# OCCUPANTS PER EXIT 1900) ---- EXIT PATH FROM MEZZANINE

SPECIFICATIONS



deca architecture.inc

935 SE Alder Street : Portland Oregon 97214 tel 503 239 1987 fax 503 239 6558 deca-inc.com



Woodburn Museum / Theater Renovation

455 N. Front St., Woodburn, OR 97071

SEMI-RECESSED FIRE EXTINGUISHER; PAINT WALL COLOR

SURFACE MOUNTED FIRE EXTINGUISHER; PAINT WALL COLOR

MEANS OF EGRESS PATH, MIN 44" WIDE, LIT TO MIN 1 FOOTCANDLE AVERAGE AT FLOOR LEVEL. SECTION 1008.2.1 EXCEPTION ALLOWS ILLUMINATION OF WALKING SURFACES TO BE REDUCED TO 0.2 FOOTCANDLES DURING PERFORMANCES. PROVIDED THAT ILLUMINATION IS AUTOMATICALLY RESTORED UPON ACTIVATION OF THE PREMISES' FIRE ALARM SYSTEM.

BATTERY BACK-UP EGRESS FIXTURE

⚠

FE-1: U-LINE OR SIM SEMI RECESSED WITH GLASS; CODE-REQUIRED CAPACITY


FE-2: U-LINE OR SIM SURFACE MOUNT WITH GLASS; CODE-REQUIRED CAPACITY

Issue	Revision	Date
PERMIT SET		08/12/21
PERMIT REVISION	1	09/27/2021

LIFE SAFETY PLAN

Scale Date

As indicated 08/12/2021 G003

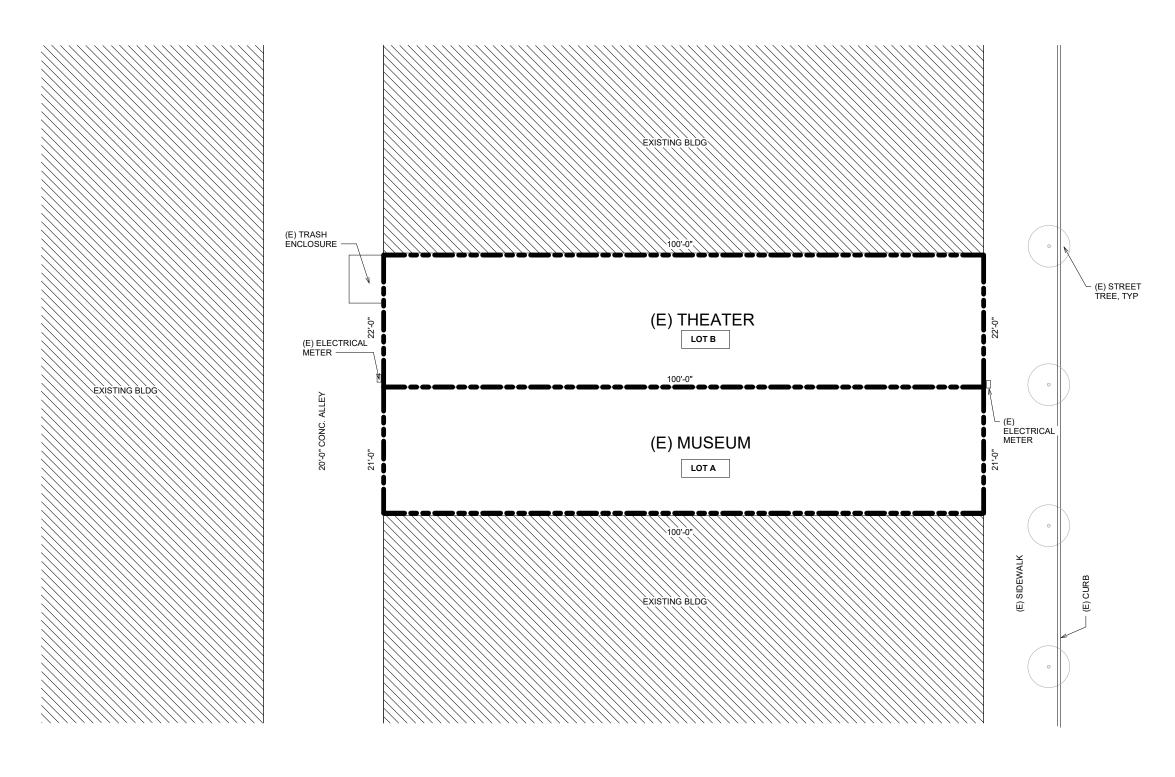

1 SITE PLAN 1/8" = 1'-0"

PLANNING & ZONING

ADDRESS:	455 N. FRONT St., WOODBURN, OR 97071	LOT AREA: (E) BLDG COVERAGE:	4,30 4,30
LEGAL DESCRIPTION:	WOODBURN BLOCKS/ LOT FR LTS 2+3 ACRES 0.05	(E) BUILDING HEIGHT:	17-9
TAX LOT ID:	LOT A = 051W18AB03900 LOT B = 051W18AB04000	FIRE DISTRICT:	WO
ACCOUNT:	108928		
JURISDICTION: PLAN DISTRICT:	CITY OF WOODBURN CITY OF WOODBURN		
SUBDIVISION:	99023 WOODBURN		
SETBACKS:	NO SETBACKS		



deca architecture.inc

935 SE Alder Street : Portland Oregon 97214 tel 503 239 1987 fax 503 239 6558 deca-inc.com

TERED ARCH XKI ATE OF

Woodburn Museum / Theater Renovation

455 N. Front St., Woodburn, OR 97071

UNION PACIFIC RAIL ROAD

Issue Revision Date
PERMIT SET 08/12/21



,300sf (COMBINED LOT A & LOT B) ,300sf (COMBINED LOT A & LOT B)

7-9" / 1 STORY

VOODBURN FIRE PROTECTION DISTRICT # 6

ARCHITECTURAL SITE PLAN


Scale Date


As indicated 08/12/2021

Sheet No.



N FRONT ST.

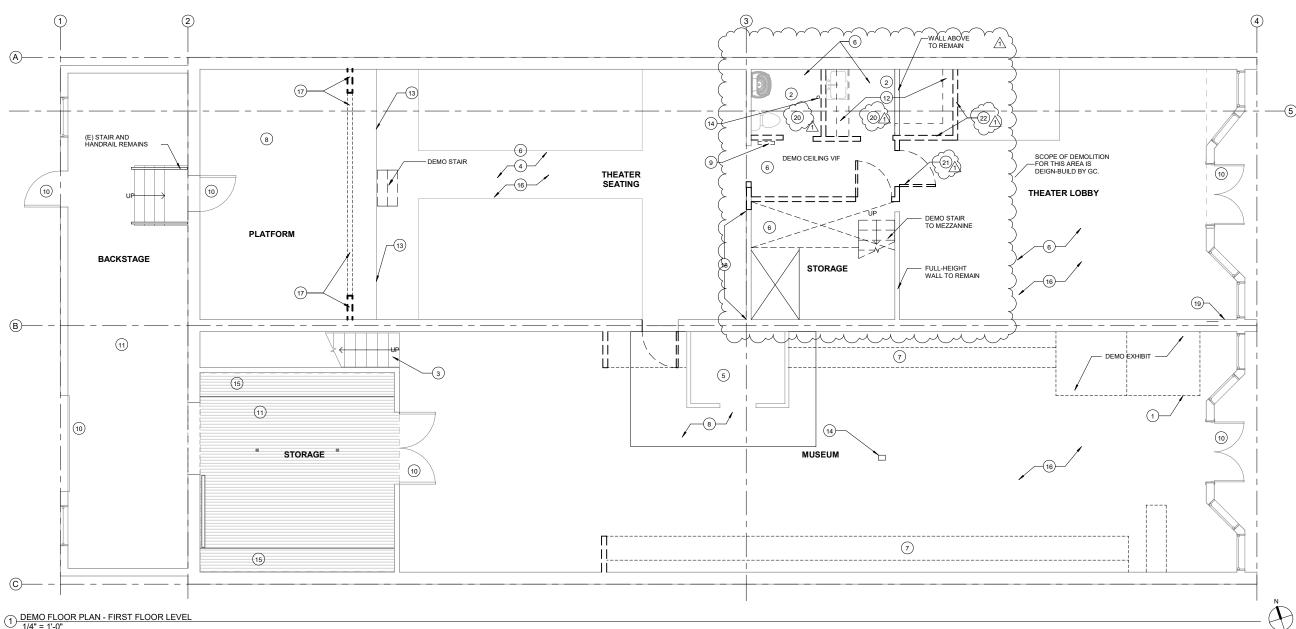

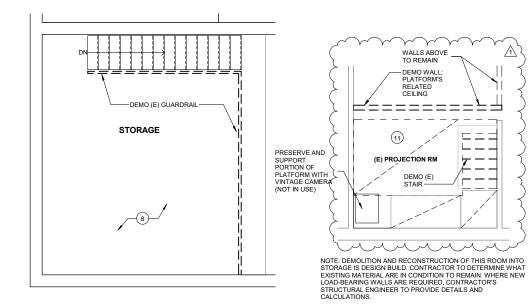

(2) DEMO FLOOR PLAN - MUSEUM MEZZANINE LEVEL 1/4" = 1'-0"

3 DEMO FLOOR PLAN -THEATER MEZZANINE LEVEL 1/4" = 1'-0"

DEMOLITION GENERAL NOTES

/1

- -

- 1. CONTRACTOR TO RELOCATE AND RE-ROUTE ALL UTILITIES IN CONFLICT WITH PROPOSED WORK, AS NEEDED. CAP AND/OR REMOVE UNUSED UTILITIES WHERE PRACTICABLE. SUBMIT DOCUMENTATION TO OWNER OF ANY UNUSED UTILITIES REMAINING AFTER COMPLETION OF WORK
- 2. COORDINATE ALL DEMO AND CONSTRUCTION ACTIVITIES. NOISE, HOURS OF WORK, UTILITY INTERRUPTIONS, ACCESS, ETC. WITH OWNER
- 3. G.C. TO PROVIDE ALL TEMPORARY WALLS, CONSTRUCTION BARRIERS, SIGNAGE, ETC TO PROTECT WORK AREAS NEEDED. COORDINATE WITH OWNER
- 4. CONTRACTOR RESPONSIBLE FOR DESIGN, ENGINEERING AND CONSTRUCTION OF ALL SHORING, FORMWORK, UNDERPINNING OR OTHER TEMPORARY MEASURES REQUIRED. WHERE TEMPORARY MEASURES WILL HAVE A VISIBLE IMPACT ON WORK, COORDINATE WITH ARCHITECT
- 5. REMOVE EXISTING FLOOR FINISHES WHERE MENTIONED AND PATCH EXISTING SUBSTRATES AS REQUIRED TO INSTALL NEW FLOOR FINISHES. REFERENCE ROOM FINISH SCHEDULE FOR AREAS WITH NEW FLOOR FINISH
- 6. CLEAN AND PREPARE ALL EXISTING SURFACES TO RECEIVE NEW FINISHES
- 7. WHERE EXISTING ITEMS AND FINISHES ARE REMOVED, PATCH AND REPAIR EXPOSED SURFACES TO MATCH ADJACENT EXISTING
- 8. FIELD VERIFY ALL EXISTING CONDITIONS AND DIMENSIONS. NOTIFY ARCHITECT OF ANY DISCREPANCIES
- 9. RECYCLE DEMOLISHED MATERIALS TO THE EXTENT POSSIBLE
- 10. RELOCATE HVAC VENTS AS REQUIRED
- 11. COORDINATE DEMOLITION W/ OWNER & CONFIRM ITEMS FOR REMOVAL OR SALVAGE IF IN QUESTION

12. OWNERS ITEMS / DISPLAY CASES NEED TO REMAIN ON SITE FOR DURATION OF REMODEL. INCLUDE TIME TO CAREFULLY MOVE AND PROTECT FOR PROJECT WORK

13. WHERE NEW DOORS OCCUR IN PREVIOUS DOOR LOCATIONS, HEADER HEIGHT MAY NEED TO ALTER TO ACCOMMODATE 6'-8" DOOR HEIGHT

- DEMOLITION SHEET NOTES
- 1. REMOVE ALL (E) LIGHT FIXTURES UNO; MANY EXISTING LOCATIONS WILL BE REUSED: VERIEY ON SHEET A201
- 2. DISPLAY CASES AND ITEMS LEFT ON SITE FOR REUSE TO BE PROPERLY PROTECTED.
- 3. IN MUSEUM, DISPLAY CASES WILL REMAIN BUT SURROUNDING SOFFIT/SHELF TO BE DEMOLISHED. WALK SITE W/ OWNER PRIOR TO DEMOLITION TO VERIFY SCOPE.
- 4. ALL PLUMBING IN THEATER BATHROOM AND BREAKROOM TO BE REMOVED; REUSE DRAIN AND WATER SUPPLY LINES AS ABLE FOR NEW PLUMBING, CONFIRM ALL PLUMBING LINES ARE IN WORKING CONDITION AND MEET CODE REQUIREMENTS.
- 5. REMOVE ANY WOOD TRIM AND MOLDING FROM THEATER, ESPECIALLY AT EAST WALL WHERE (E) "PORTALS" ARE LOCATED.
- 6. ENTRY AT THEATER IS A NEW STOREFRONT; PROTECT DURING CONSTRUCTION
- 7. REMOVE EXISTING CEILING MATERIAL TO PREPARE FOR ALL NEW GYPSUM CEILING THIS ROOM.

KEYNOTES

- (1) DEMO AND RELOCATE POWER TO NORTH WALL.
- 2 REMOVE ALL PLUMBING FIXTURES FOR NEW TOILET ROOMS.
- (3) REMOVE (E) CARPET ON STAIRS, PREP FOR NEW MATERIAL
- 4 REMOVE ALL (E) FLOORING AND CEILING THIS ROOM
- 5

- KEYNOTES, CONT.
- 9 RELOCATE HVAC VENT

(13)

(17)

(18)

(19)

(20)

- (14) RELOCATE VENT PIPE
- (16) DEMO (E) LIGHT FIXTURES & CEILING FAN (WHERE OCCURS)
 - REMOVE (E) PROSCENIUM THIS WALL, REMOVE TRIM AT WINDOW OPENINGS.
 - (E) ELEC PANEL LOCATION REMAINS, REPLACED WITH NEW EQUIPMENT
 - (E) CEILING TO REMAIN & GET REFINISHED. DEMO DOOR, FRAME AND PORTION OF WALL BELOW HALLWAY CEILING.
- (21)

LEGENED

- DEMOLISHED WALLS
- NO DEMOLITION WITHIN MUSEUM DISPLAY STRUCTURE; PROTECT AS NEEDED.
- 6 REMOVE ALL FINISHES, FIXTURES. VERIFY PRESENCE OF ANY HAZARDOUS MATERIALS.



deca architecture.inc

935 SE Alder Street : Portland Oregon 97214 tel 503 239 1987 fax 503 239 6558 deca-inc.com



Woodburn Museum / Theater Renovation

455 N. Front St., Woodburn, OR 97071

- (7) REMOVE SOFFITS BUT DISPLAY CASES TO REMAIN
- 8 REMOVE (E) FLOORING TO RECEIVE NEW MATERIAL AT/IN DISPLAY
- (10) EXISTING DOOR TO REMAIN
- (I) NO CHANGES TO FINISHES THIS ROOM
- 12 REMOVE EXISTING CASEWORK AND WOOD SHIP LAP FROM WALLS AND CEILING
 - REMOVE WOOD AT FRONT OF STAGE / FACE OF STAGE.
- (15) EXISTING SHELVING TO REMAIN
- (22) REMOVE THIS WALL BELOW EXISTING CEILING. MMMMM

____ DEMOLISHED OVERHANGS _____ WALLS TO REMAIN

DEMOLITION PLAN

Revision

Issue

PERMIT SET


Date

08/12/21


09/27/2021

Scale As indicated Date Sheet No.



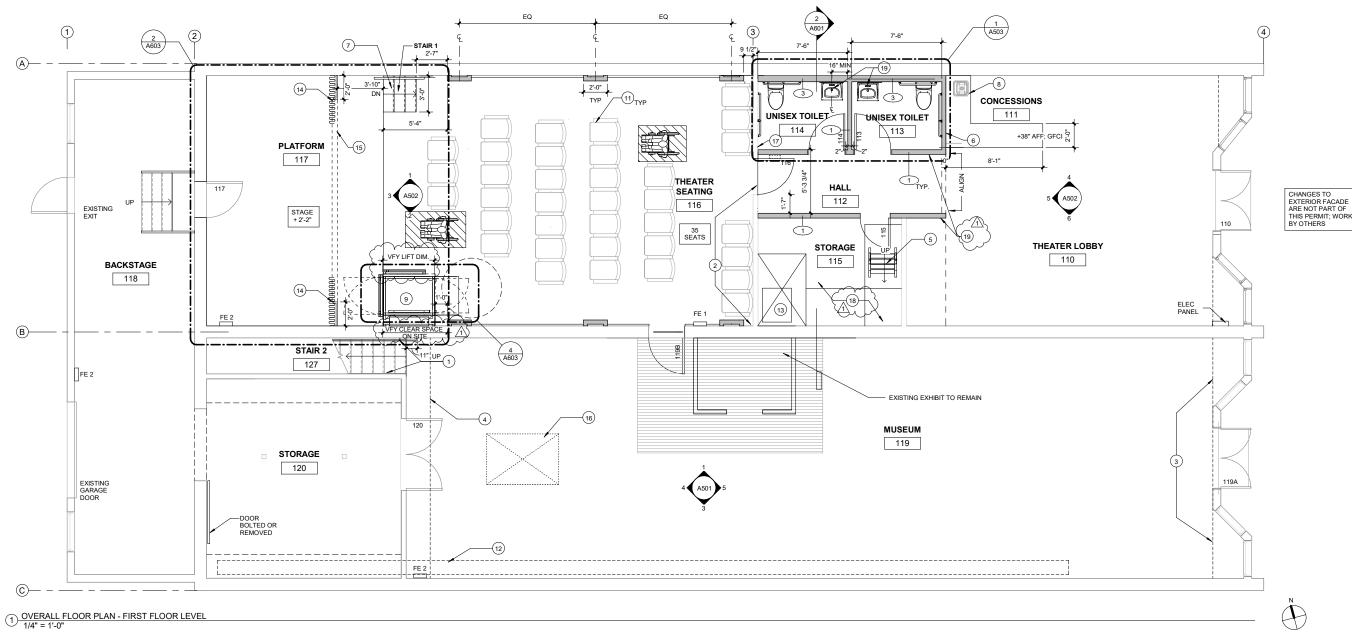



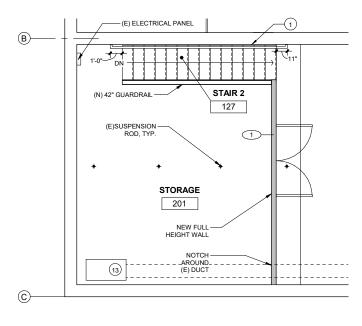


(2) (E) MEZZANINE LEVEL FLOOR PLAN - MUSEUM 1/4" = 1'-0"

FLOOR PLAN LEGEND

EXISTING CONSTRUCTION TO REMAIN NEW CONSTRUCTION OVERHEAD -----



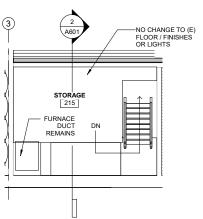

CONSTRUCTION GENERAL NOTES

- 1. CONTRACTOR TO RELOCATE AND RE-ROUTE ALL UTILITIES IN CONFLICT WITH PROPOSED WORK, AS NEEDED, CAP AND/OR REMOVE UNUSED UTILITIES WHERE PRACTICABLE. SUBMIT DOCUMENTATION TO OWNER OF ANY UNUSED UTILITIES REMAINING AFTER COMPLETION OF WORK.
- 2. FIELD VERIFY ALL EXISTING CONDITIONS AND DIMENSIONS. NOTIFY ARCHITECT OF ANY DISCREPANCIES.
- 3. SOUND SYSTEM: N.I.C., OWNER TO CONTRACT WITH OWN VENDOR 4. DIMENSIONS SHOWN ARE TO FACE OF FINISH, U.N.O.
- 5. CONCEAL ALL NEW CONDUITS, PIPING AND DUCT WORK TO THE EXTENT POSSIBLE. EXPOSED TO BE PAINTED ADJACENT WALL COLOR.
- 6. PATCH AND REPAIR ALL DAMAGE TO GYPSUM AND PLASTER FINISH SURFACES TO MATCH EXISTING/ ADJACENT PRIOR TO PAINTING
- 7. PROVIDE SOLID 2X WOOD BLOCKING IN NEW WALLS AT ALL WALL MOUNTED LOCATIONS, IN TOILETS AND WHERE NOTED.

8. NEW DOORS TO HAVE WOOD FRAMES.

KEYNOTES

- 2
- (3) NEW CABINET DOORS; CLEAN & FINISH OUT STORAGE UNDER WINDOW BOX.
- (4) EDGE OF MEZZANINE ABOVE / OVERHANG TO REMAIN, REPAINT.
- PRE-MANUFACTURED METAL SHIP LADDER IN PREVIOUS STAIR LOCATION. SEE A701 FOR MODEL INFORMATION 5
- $\overline{7}$ (N) WOODEN STAIR WITH WOOD HANDRAIL (8)
- INSTALL CABINET, SINK & PLUMBING; SEE 7/A502 SCREWS ATTACHING UNIT TO FLOOR.
- (TO) NOTE NOT USED
- (11) (N) THEATER SEATING OFCI
- (12) (E) DUCT ABOVE TO REMAIN; PAINT PER A700.
- (13) (14) (N) DRAPERY & TRACK OFCI
- (15) NEW STAGE PROSCENIUM
- (16) ADD NEW TRIM TO (E) SKYLIGHT, SEE A201
- BATT INSULATION & ADDITIONAL LAYER OF 5/8" GYPSUM BOARD ON RESILIENT CLIPS: VERIFY MAINTAINING CLEARANCES. NEW DESIGN BUILD PLATFORM FOR STORAGE. (17)
- (18)

(19)

(3) (E) MEZZANINE LEVEL FLOOR PLAN - THEATER 1/4" = 1'-0"



deca architecture.inc

935 SE Alder Street : Portland Oregon 97214 tel 503 239 1987 fax 503 239 6558 deca-inc.com



Woodburn Museum / Theater Renovation

455 N. Front St., Woodburn, OR 97071

1 NEW GYPSUM WALL BD AT SOUTH WALL; PAINT ENTIRE STAIRWAY; PROVIDE NEW WOOD HANDRAIL AT N WALL OF STAIR. ATTACH HANDRAIL TO WALL W/ SUPPORTS OPENINGS AT UPPER PORTION OF WALL TO BE INFILLED W/ GYP AND SEAMLESSLY FINISHED. OPENING AT LOWER LEVEL TO REMAIN; INSTALL TINTED FILM ON GLASS (N).

6 OUTLET LOCATED BELOW COUNTER; COORDINATE LOCATION OF GROMMET IN COUNTER FOR ACCESS/OWNER'S POINT OF SALE

VERTICAL PLATFORM WHEELCHAIR LIFT FOR STAGE OFCI, SEE SPECIFICATION ATOL
 POVOIDE POWER AS REQUIRED; INSTALL PER MANUFACTURER'S INSTRUCTION WITH LAG

FURNACE UNIT TO REMAIN; PROJECTOR TO REMAIN WITH PORTION OF PLATFORM TO SUPPORT. COORDINATE SALVAGED PORTION AND COLUMNS TO SUPPORT/REUSE (E) COLUMNS

CONTRACTOR TO DETERMINE IF WALL IS LOAD-BEARING AND PROVIDE STRUCTURAL DETAILS


 $\overline{\Lambda}$

Issue	Revision	Date
PERMIT SET		08/12/21
PERMIT REVISION	1	09/27/2021

OVERALL FLOOR PLAN

Scale As indicated 08/12/2021 Date Sheet No.



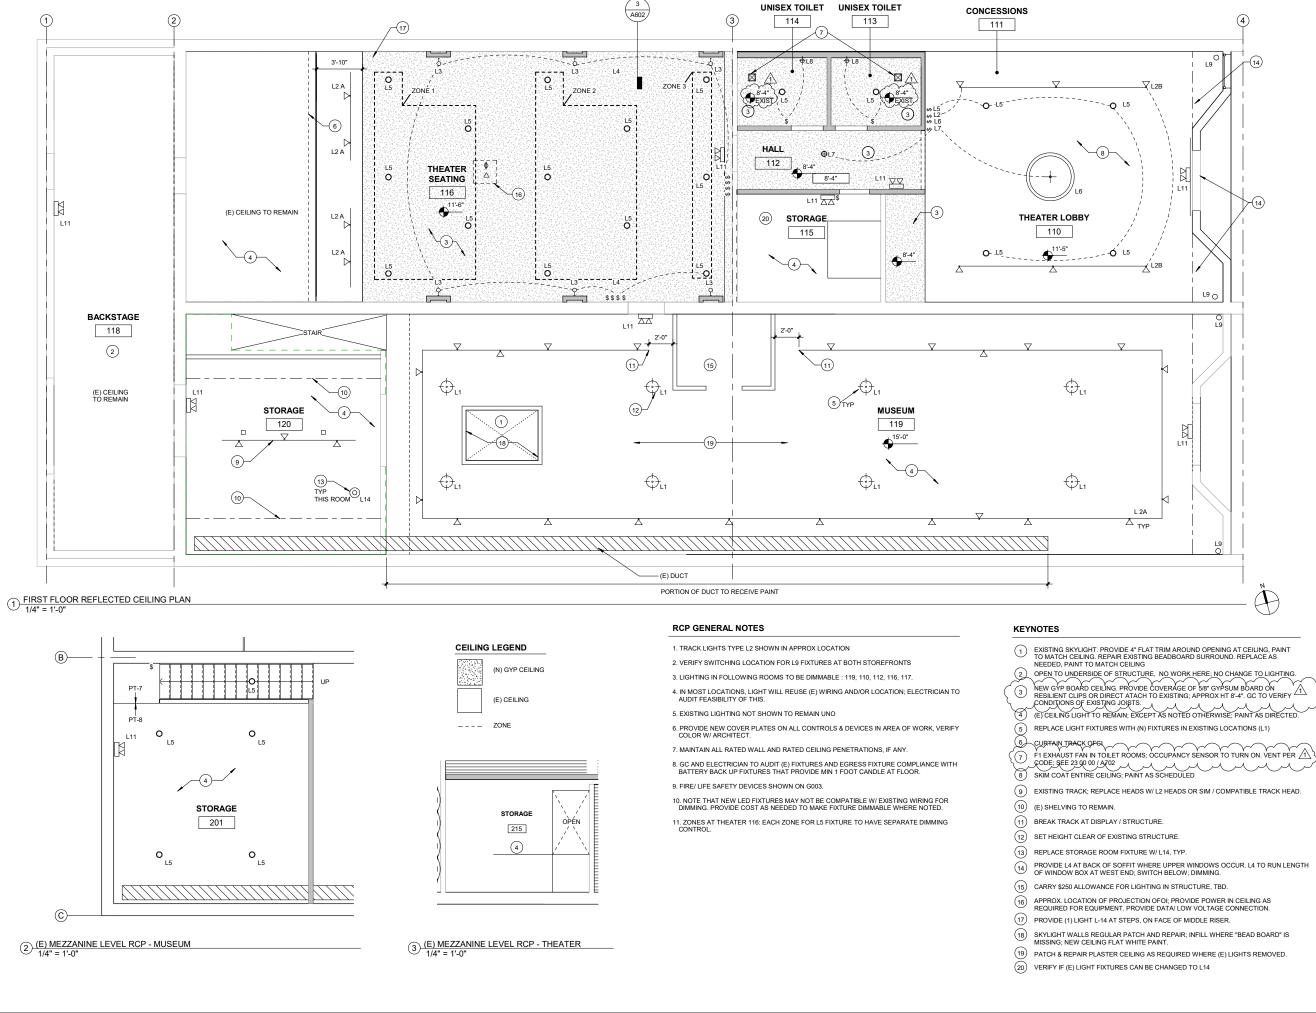



deca architecture.inc

935 SE Alder Street : Portland Oregon 97214 tel 503 239 1987 fax 503 239 6558 deca-inc.com



Woodburn Museum / Theater Renovation

455 N. Front St., Woodburn, OR 97071

Issue	Revision	Date
PERMIT SET		08/12/21
PERMIT REVISION	1	09/27/2021

REFLECTED CEILING PLAN

Scale Date

As indicated 08/12/2021



LIGHT FIXTURE LEGEND

NOTE: (E) LIGHTING AND WIRING IS NOT LED. PROVIDE NECESSARY WORK & WIRING REQUIRED TO MAKE NEW LED FIXTURES DIMMABLE WHERE INDICATED.

<u>L1</u>	-\$-	MUSEUM PENDANT MANUF: SEAGULL LIGHTING STYLE: PRATT STREET METAL / MEDIUM LED PENDANT 6506935-715 FINISH: AUTUMN BRONZE 715 UPC: 78652046735 KELVIN: 3000 SIZE: 13° DIM X 10° HIGH NOTE: VERIFY HEIGHT OF FIXTURE W/ ARCHITECT / CLEAR OF	<u>L10</u>	×	EXIT SIGNS MANUF: LITHONIA STYLE: QUANTUM THERMOPLASTIC EXIT LQM LAMP: LED MODEL: LQM-S-W-3-G-120/277 FINISH: WHITE/ BLACK NOTE: ORDER SIMILAR FIXTURE W/2 FACES WHERE NEEDED. LOCATIONS: BLACK AT 112,117. ALL OTHERS WHITE
<u>L2 A</u>	<u> </u>	DISPLAYS; ORDER POST /CHAIN AFTER DETERMINING LENGTH TRACK FIXTURE & TRACK MANUF: JUNO STYLE: TRAC LYTES 10 W LED CYLINDER CATIF: ROGU SERNES COLOR: BLACK SPEC: 3000 (30K), 30 CRI, NFL SIZE: 7X21/2" FUNCTION: NARROW FLOOD: DIMMING - VERIFY NOTE: TRACK TO BE SUSPENDED, VIF TRACK: TRAC MASTER; BLACK LIMITER: TRAC MASTER; BLACK	<u>L11</u> L12		EGRESS FIXTURES MANUF: LITHONIA STYLE: QUANTUM LED EMERGENCY LIGHT LAMP: LED MODEL: ELM2L FINISH: WHITE / BLACK NOTE: BATTERY BACK UP TO TURN ON FIXTURE IN EMERGENCY/ OUTAGE. LOCATIONS: BLACK AT 112,116,117. ALL OTHERS WHITE STEP LIGHT MANUF: WAC LIGHTING FIXTURE: LED HORIZONTAL STEP LIGHT FUNCTION: DIMMING FINISH: BRONZE ON ALUMINUM
<u>L2 B</u>	<u> </u>	TRACK FIXTURE & TRACK MANUF: JUNO STYLE: TRAC LYTES 10 W LED CYLINDER CAT#: R605L SERIES COLOR: WHITE SPEC: 3000 (30K), 90 CRI, NFL SIZE: 7X21/2" FUNCTION: NARROW FLOOD; DIMMING - VERIFY NOTE: TRACK TO BE SUSPENDED, VIF TRACK: TRAC MASTER; VIMITE LIMITER: TRAC MASTER; ELECTRICIAN TO VERIFY ELECTRICAL FEED LOCATION: 1110,120	<u>L14</u>	¢	SIZE: 5'W X 3'H X 2''D NOTE: IN FACE OF RISER AT NEAR STAGE STAIR FIXTURE AT STORAGE MANUF: SOUTHWIRE (OR SIM) STYLE: INDUSTRIAL I-LIGHT OUTDOOR WEATHERTIGHT FIXTURE INSTALL: FLUSHMOUNT AT EXISTING JUNCTION BOX FINISH: BRUSHED STELL SIZE: APPROX 5''W X 9'H
<u>L3</u>		NOT IN USE			
<u>L4</u>		LINEAR CONTINUOUS LED: ALTERNATE ITEM MANUF: KELVIX STYLE: BRETT 502-1 LENS: SWH SEAMLESS WHITE FINISH: SILVER (STANDARD) KELVIN: ZTK SIZE: TBD-VIF FUNCTION: DIMMING NOTE: USED IN THEATER LOBBY "WINDOW BOX"			
<u>L5</u>	0	LED RECESSED CAN MANUF: JUNO STYLE: 6" ROUND RECESSED CAN MODEL: JPD28 POD26" DOWNLIGHT LAMP: LED FINISH: TBD KELVIN: 27K SELS: 6" FUNCTION: DIMMABLE NOTE: VERIFY IF NEW OR REMODEL FIXTURE IS BEST. LIGHT FINISH AT 110, 201; DARK FINISH AT 113, 114, 116.			
<u>L6</u>	\bigcirc	LARGE LOBBY PENDANT MANUF: G LIGHTING STYLE: SONATA MODEL: 0.2-153 -1120-S-PAB-3DE- FINISH: ANTIQUE BRASS KELVIN: 3000 K FUNCTION:DIMMING INSTALL HEIGHT: 7-6" MIN AFF NOTE: CUSTOM LENGTH APPROX. 48" BELOW CLG			
<u>L7</u>	÷	CEILING MOUNTED HALLWAY LIGHT MANUF: GENERATION LIGHTING STYLE: ACADEMY SEMI FLUSH MOUNT LAMPING: LED CATH: 7743-782 FINISH: BRONZE LAMP; LED, 2700 K SIZE: 13'DIAM X 12.5' H FUNCTION: DIMMING			
<u>L8</u>	- -	VANITY SCONCE LED MANUF: GENERATION LIGHTING STYLE: ACADEMY SCONCE LAMPING: LED CAT#: 44436 - 710 FINISH: BRONZE LAMP: PROVIDE LED LAMP, 2700 K SIZE: 7°W X 10°H FUNCTION: DIMMING NOTE: CENTER OVER MIRROR IN TOILET ROOMS; LOCATE IN THEATER			
<u>L9</u>	0	COLUMNS DIFECTIONAL MONOPOINT MANUF: BRUCK STYLE: MONOPOINT CYLINDER GX35 CAT#: 350442 40LM 30K 25 ELV BK MPBK TRIM COLOR: BLACK ACCESSORY: 350442/HCLBK KELVIN: 3000 SIZE: 4* FUNCTION: ADJUSTABLE, DIMMABLE NOTE: ADD HONEYCOMB LOLIVER			



deca architecture.inc

935 SE Alder Street : Portland Oregon 97214 tel 503 239 1987 fax 503 239 6558 deca-inc.com

TERED ARCH 2919 DAVID T. HYMAN AND CHE Portland, degon


Woodburn Museum / Theater Renovation

455 N. Front St., Woodburn, OR 97071

Issue	Revision	Date
PERMIT SET		08/12/21

REFLECTED CEILING PLAN LEGEND


Scale Date 1/8" = 1'-0" 08/12/2021 **A202**

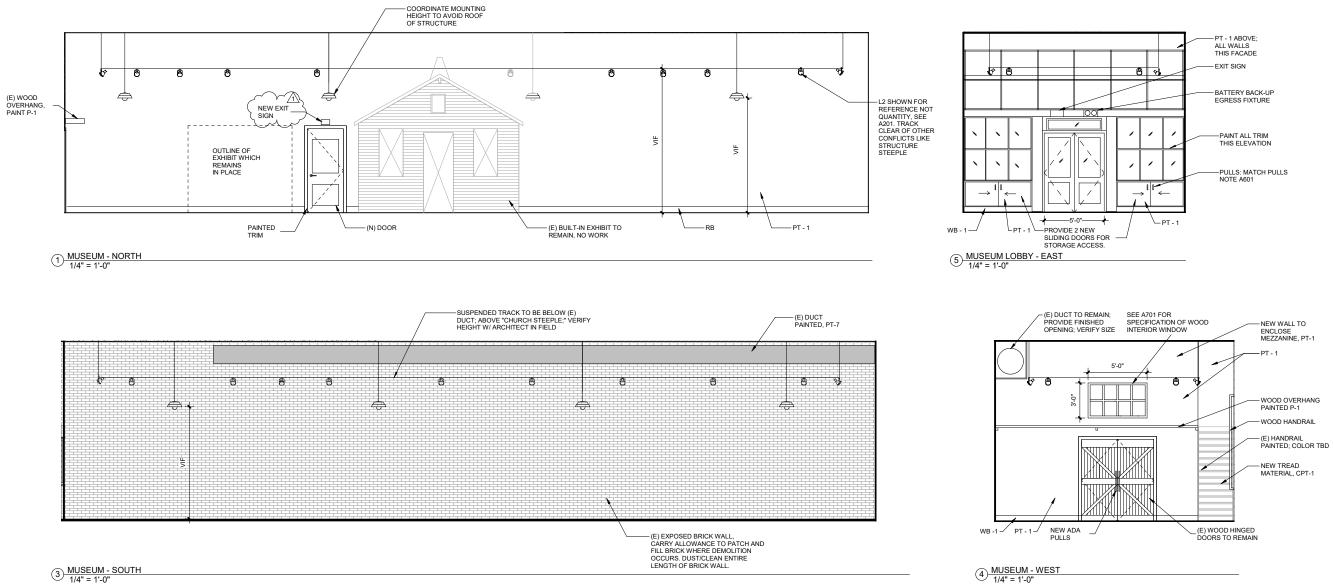



deca architecture.inc

935 SE Alder Street : Portland Oregon 97214 tel 503 239 1987 fax 503 239 6558 deca-inc.com

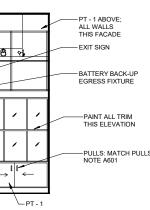



Woodburn Museum / Theater Renovation


455 N. Front St., Woodburn, OR 97071

Issue	Revision	Date
PERMIT SET		08/12/21
PERMIT REVISION	1	09/27/2021

INTERIOR ELEVATIONS - MUSEUM


Scale Date


1/4" = 1'-0" 08/12/2021 A501

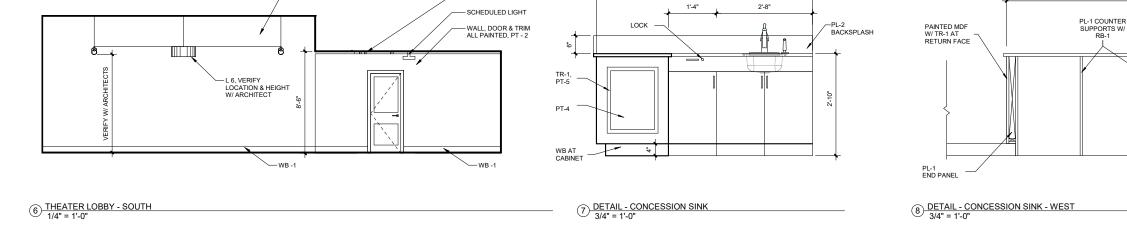


VIF TO SET HEIGHT

6'-0"

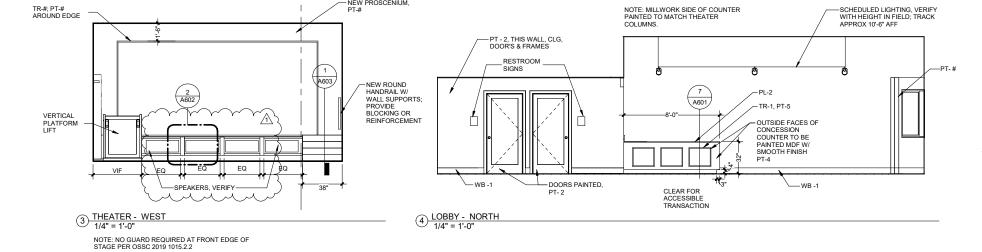

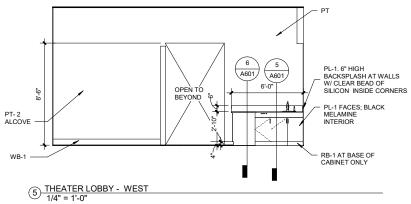



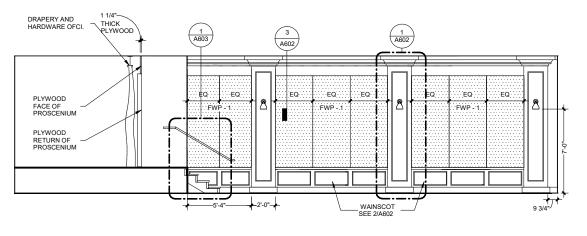


- NEW PROSCENIUM, PT-#

– PT - 1, THIS WALL

5

1 <u>THEATER - NORTH</u> 1/4" = 1'-0"

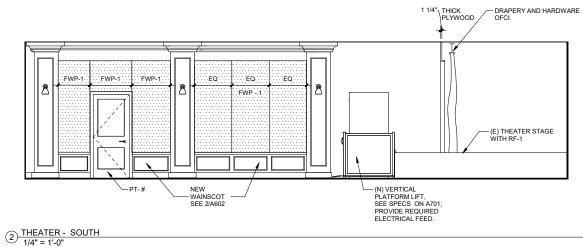




deca architecture.inc

935 SE Alder Street : Portland Oregon 97214 tel 503 239 1987 fax 503 239 6558 deca-inc.com



Woodburn Museum / Theater Renovation

455 N. Front St., Woodburn, OR 97071

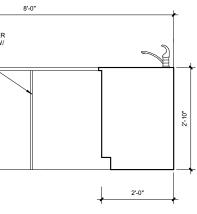



Issue	Revision	Date
PERMIT SET		08/12/21
PERMIT REVISION	1	09/27/2021


INTERIOR ELEVATIONS - THEATER


Scale As indicated Date Sheet No.



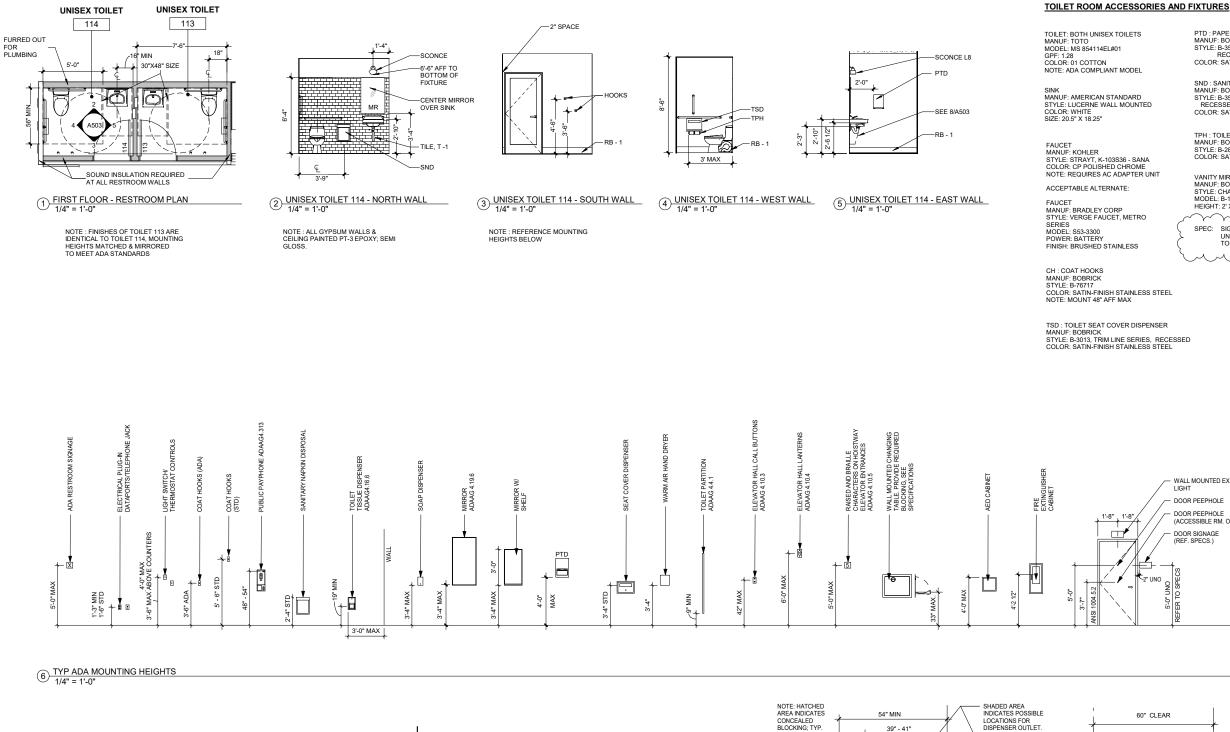


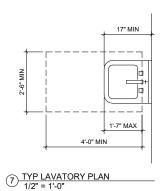

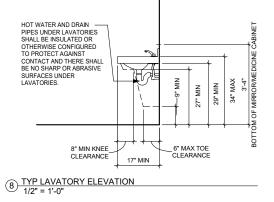

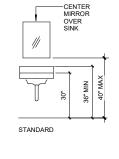

9 TYPICAL MOUNTING HEIGHTS 3/8" = 1'-0"

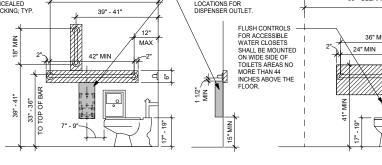

10 TOILET GRAB BAR DETAILS 1/2" = 1'-0"

PTD : PAPER TOWEL DISPENSER MANUF: BOBRICK STYLE: B-35903 TRIM LINE SERIES RECESSED COLOR: SATIN-FINISH STAINLESS STEEL

SND : SANITARY NAPKINS DISPOSAL MANUF: BOBRICK STYLE: B-353, CLASSIC SERIES, RECESSED COLOR: SATIN-FINISH STAINLESS STEEL

TPH : TOILET PAPER HOLDER MANUF: BOBRICK STYLE: B-2840, WITH UTILITY SHELF COLOR: SATIN-FINISH STAINLESS STEEL

VANITY MIRROR MANUF: BOBRICK STYLE: CHANNEL FRAME MIRROR MODEL: B-165 SERIES, B 165 2436 HEIGHT: 2' X 3'-0" ~

$\sim \sim$	$\gamma \sim$	$\gamma \sim$	$\gamma \sim$	$\gamma \sim$	` <i>F</i>
SPEC:	SIGN				<u> </u>
7		EX ACO	CESSIB DMS	LE	-
۲m.	Ĵ.	~	~, ~	J	ہہ



deca architecture.inc

935 SE Alder Street : Portland Oregon 97214 tel 503 239 1987 fax 503 239 6558 deca-inc.com




Woodburn Museum / Theater Renovation

455 N. Front St., Woodburn, OR 97071

_	WALL MOUNTED EXIT
	LIGHT

- DOOR PEEPHOLE
- DOOR PEEPHOLE (ACCESSIBLE RM. ONLY)
- DOOR SIGNAGE
- (REF. SPECS.)

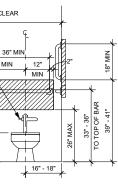


Issue	Revision	Date
PERMIT SET		08/12/21
PERMIT REVISION	1	09/27/2021

INTERIOR ELEVATIONS - ACCESSIBILITY CLEARANCES

Scale Date

As indicated 08/12/2021



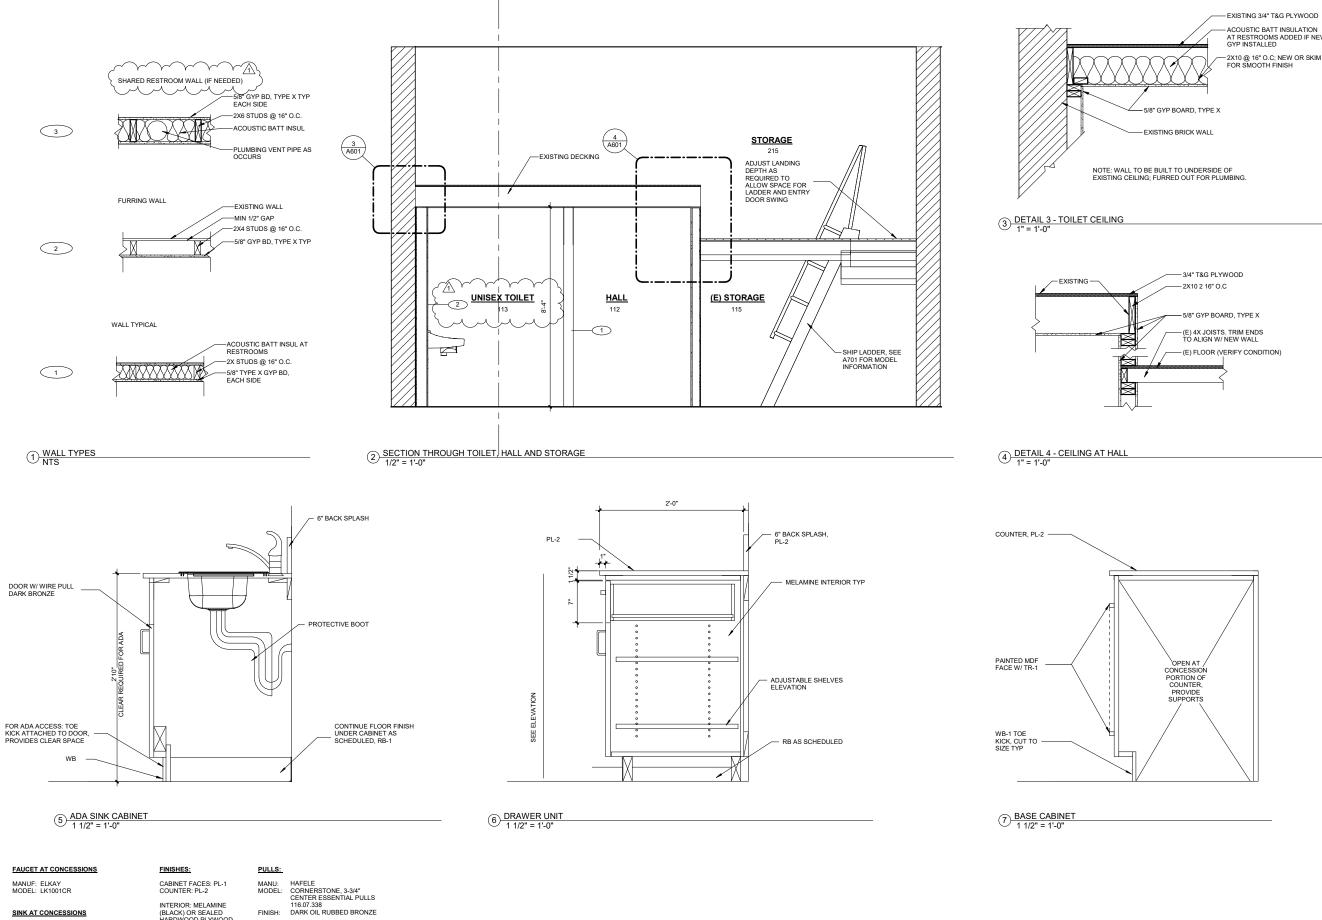

5

SINK AT CONCESSIONS

MANUF: ELKAY MODEL: CELEBRITY STAINLESS STEEL BCR15 SINGLE BOWL, DROP-IN SIZE: 15" X 15" X 6-1/8"

INTERIOR: MELAMINE (BLACK) OR SEALED HARDWOOD PLYWOOD

FINISH:

- ACOUSTIC BATT INSULATION AT RESTROOMS ADDED IF NEW GYP INSTALLED - 2X10 @ 16" O.C; NEW OR SKIM COAT FOR SMOOTH FINISH d

deca architecture.inc

935 SE Alder Street : Portland Oregon 97214 tel 503 239 1987 fax 503 239 6558 deca-inc.com



Woodburn Museum / Theater Renovation


455 N. Front St., Woodburn, OR 97071

Issue	Revision	Date
PERMIT SET		08/12/21
PERMIT REVISION	1	09/27/2021


DETAILS - INTERIOR


Scale	As indicated
Date	08/12/2021
Sheet No.	A601


2 DETAIL OF WOODEN WIANSCOT 1" = 1'-0"

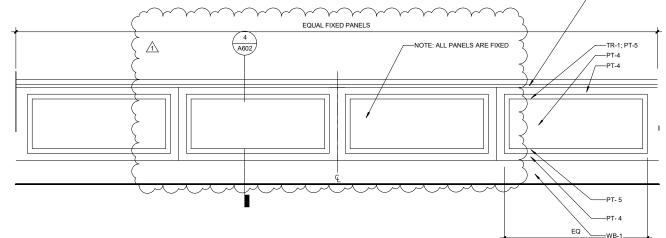



1 DETAIL OF WOODEN PILASTER 1" = 1'-0"

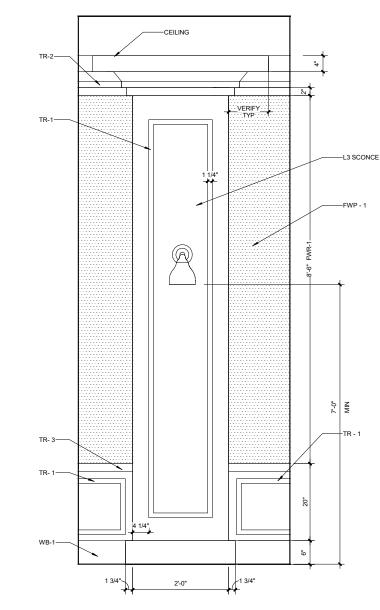


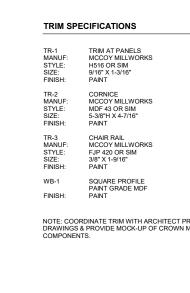


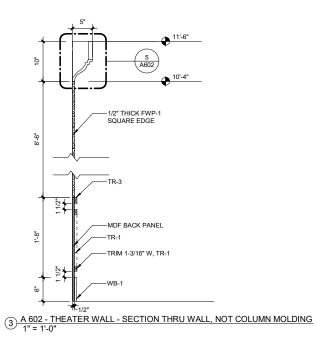


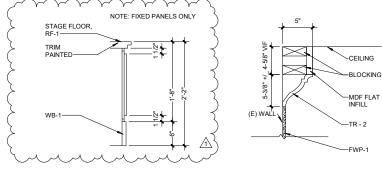

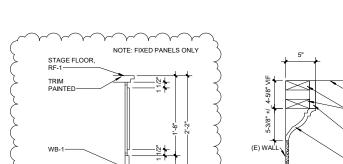

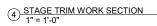

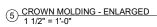

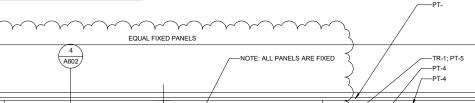





deca architecture.inc

935 SE Alder Street : Portland Oregon 97214 tel 503 239 1987 fax 503 239 6558 deca-inc.com

STERED ARCH AND CHECK Portland, degon

Woodburn Museum / Theater Renovation


455 N. Front St., Woodburn, OR 97071


Issue	Revision	Date
PERMIT SET		08/12/21
PERMIT REVISION	1	09/27/2021

DETAILS - INTERIOR

Scale As indicated 08/12/2021 Date Sheet No.




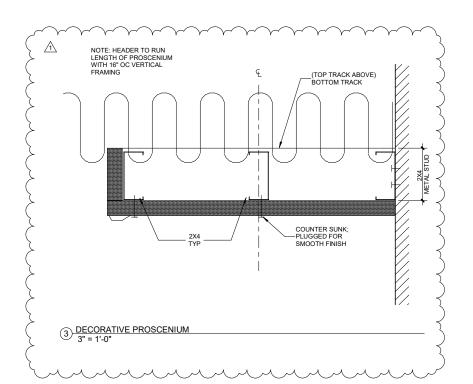


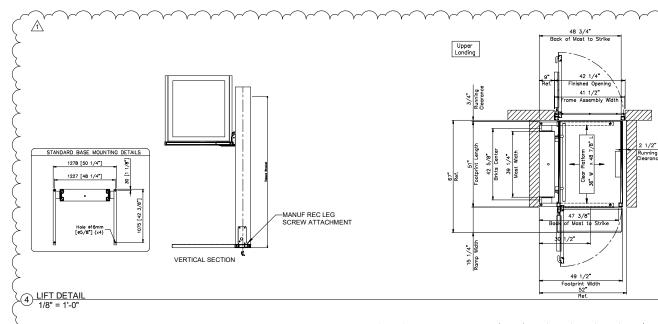


2 ENLARGED FLOOR PLAN - STAGE 1/2" = 1'-0"

1/2" = 1'-0"

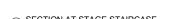

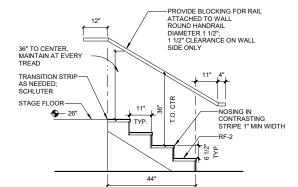

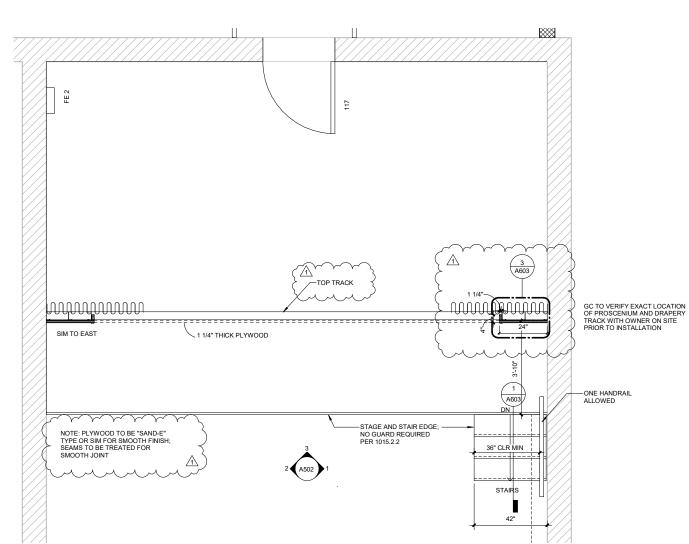



deca architecture.inc

935 SE Alder Street : Portland Oregon 97214 tel 503 239 1987 fax 503 239 6558 deca-inc.com

STERED ARCH David Davido ECI P PORTLAND, OF ORE

Woodburn Museum / Theater Renovation

455 N. Front St., Woodburn, OR 97071




Issue Revision Date PERMIT SET 08/12/21 1 PERMIT REVISION 09/27/2021


DETAILS - INTERIOR

Scale Date



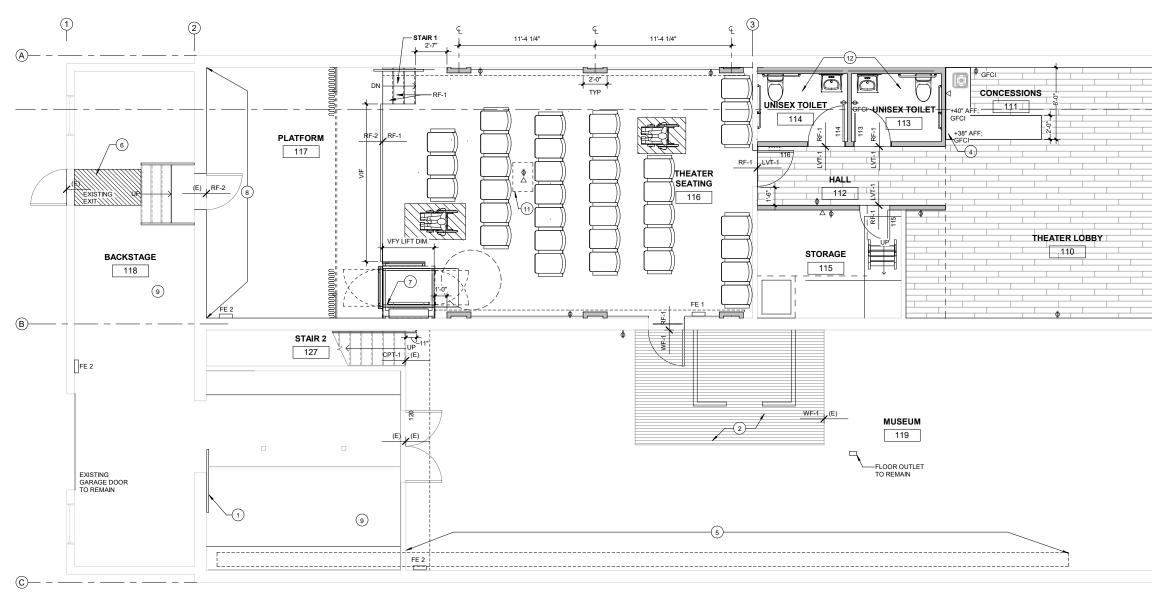

① OVERALL FLOOR PLAN - FIRST FLOOR LEVEL_POWER PLAN-1/4" = 1'-0"

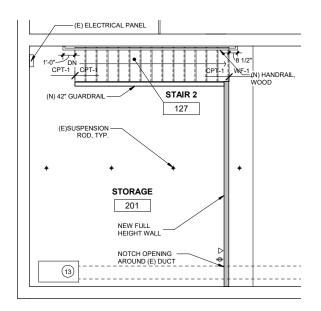


(2) (E) MEZZANINE LEVEL FLOOR PLAN - MUSEUM FINISH PLAN 1/4" = 1'-0"

GENERAL NOTES

- 1. WHERE FLOORING CHANGE OCCURS PROVIDE SCHLUTER TRANSITION OR OTHER AS NOTED.
- 2. TOILET ROOM PAINT TO BE EPOXY
- 3. WHERE RF INSTALLED, USE COLOR MATCH WELDING ROD.
- 4. (E) WOOD FLOORING AT MUSEUM 119 TO RECEIVE CLEAR SEAL COAT.
- 5. NEW PAINT THROUGHOUT
- 6. PROVIDE ALL ELECTRICAL RECEPTACLES REQUIRED BY CODE IN AREAS OF NEW FRAMING. ELECTRICAL SUBCONTRACTOR TO REVIEW UTILITY OUTLET LOCATIONS W/ ARCHITECT PRIOR TO INSTALL
- 7. ELECTRICAL SUBCONTRACTOR TO AUDIT ALL OUTLET LOCATIONS AND PROVIDE FEEDBACK ON NEW OUTLET LOCATIONS REQUIRED PER CODE.
- REPLACE ALL (E) OUTLET COVER PLATES; VERIFY COLOR AND STYLE W/ ARCHITECT BASED ON WHAT FITS WITH EXISTING OUTLETS.

KEYNOTES

- EXISTING DOOR TO REMAIN
- `A (1)WHERE PLYWOOD FLOOR REMOVED, INFILL W/ WF-1 TO MATCH EXISTING IN SIZE, STYLE: STAIN TO MATCH CLOSELY. PROVIDE SAMPLES FOR APPROVAL PRIOR TO INSTALLATION. 2
- 3 INDICATES LOCATION OF RELOCATED PANEL AS REQUIRED. 4
- GENERAL LOCATION OF NEW OUTLET; VERIFY IN FIELD IF ONE IS NEARBY / THIS OUTLET NEEDED. OUTLETS NEAR SINK LOCATIONS TO BE GFCI PER CODE
- 5 PAINT DUCT PT-7 WHERE EXPOSED IN MUSEUM 119. 6 REQUIRED AREA TO BE TAPED OR PAINTED 36" WIDE W/ CROSSHATCH FOR CLEAR EXIT PATH.
- 7 VERIFY & PROVIDE POWER REQUIRED FOR LIFT.
- BACK WALL AT STAGE: PROVIDE FINISHED GYP AT DOORWAY WHERE STUDS EXPOSED. PAINT ALL BACK WALL ITEMS BLACK. 8 9 NO NEW FINISHES IN THIS ROOM
- 10
- (E) BREAKER BOX TO BE COMPLETELY REPLACED WITH NEW UNIT.
- (1) CEILING: APPROX LOCATION FOR CEILING MOUNTED PROJECTOR, REQUIRING POWER & DATA. COORDINATE WITH OWNERS AV DESIGNER.
- 12 PROVIDE POWER AS REQUIRED BY 2017 OESC.

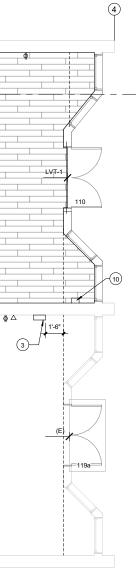

-(5)



deca architecture.inc

935 SE Alder Street : Portland Oregon 97214 tel 503 239 1987 fax 503 239 6558 deca-inc.com



Woodburn Museum / Theater Renovation

455 N. Front St., Woodburn, OR 97071



Issue	Revision	Date
PERMIT SET		08/12/21

DENOTES TAPED OR PAINTED PATH CLEAR FOR EGRESS

WF-1, NEW TO MATCH (E)

LEGEND

 ${\rm AFF}^{\bigoplus}$

Φ

 \bigtriangledown

 $\varphi_{\rm gfci}$

LVT-1

DATA

POWER OUTLET ABOVE FINISHED FLOOR

NEW POWER OUTLET @ 18" TYP PER CODE

NEW GFCI OUTLET

FINISH & POWER PLAN

Scale As indicated 08/12/2021 Date Sheet No.



	ROOM FINISH SCHEDULE								
						WAL	L FINISHES		
ROOM NUMBER	ROOM NAME	FLOOR	BASE	CEILING	N. WALL	E. WALL	S. WALL	W. WALL	REMARKS
110	THEATER LOBBY	LVT-1	WB-1	PT-8	PT-1	PT-1	PT-1	PT-1; PT-#	E
111	CONCESSIONS	LVT-1	WB-1	PT-8	PT-1	PT-1	PT-1	PT-1	
112	HALL	LVT-1	WB-1	PT-2	PT-2	PT-2	PT-2	PT-2	
113	UNISEX TOILET	RF-1	T-1, RB-1	PT-3	T-1, PT-3	PT-3 EPOXY	PT-3 EPOXY	PT-3 EPOXY	В
114	UNISEX TOILET	RF-1	T-1, RB-1	PT-3	T-1, PT-3	PT-3 EPOXY	PT-3 EPOXY	PT-3 EPOXY	В
115	STORAGE	RF-1	RB-1	PT-1 (VERIFY)	PT-1	PT-1	PT-1	PT-1	
116	THEATER SEATING	RF-1	WB-1	PT-7	PT-, FWP-1	PT-, FWP-1	PT- , FWP-1	PT	C, E
117	PLATFORM	RF-1	(E)	PT-7, VERIFY	PT-	N/A	PT	BLACK	D
118	BACKSTAGE	(E)	(E)	(E)	(E)	PT-1	(E)	(E)	F
119	MUSEUM	WF-1 / (E)	RB; WB-1	PT-7	PT-1	PT-1	(E) BRICK	PT-1	A
120	STORAGE	(E)	(E)	PT-1	N/A	N/A	N/A	N/A	
127	STAIR 2	CPT-1	RB	PT-7	PT-1	PT-1	PT-1	PT-1	
201	STORAGE	CPT-1	RB-1	PT-7	PT-1	PT-1	PT-1	PT-1	
215	MEZZ. STORAGE	(E)	(E)	(E)	(E)	(E)	(E)	(E)	

PAINT FINISHES

REMARKS

A. EXISTING BRICK TO REMAIN. CLEAN AND INFILL AS NEEDED.

B. EPOXY PAINT AT RESTROOM

- C. SEE ELEVATIONS FOR PAINT COLORS AT WALL AND MILLWORK TRIM
- D. THEATER STAGE : BACK WALL AND ELEMENTS PAINTED EXCEPT BRICK; VERIFY COLOR
- E. SEE ELEVATION FOR LOCATION OF MULTIPLE FINISHES
- F. PROVIDE LINE ITEM COST TO PAINT THIS WALL

GENERAL NOTES

- 1 CONTRACTOR RESPONSIBLE FOR VERIFYING FINISH LOCATIONS IN DRAWINGS AND SCHEDULES.
- 2 SUBSTITUTIONS MUST BE APPROVED BY ARCHITECT
- 3 SEE ELEVATIONS & DETAILS WHERE MULTIPLE FINISHES OCCUR
- 4 ALL EXISTING PAINTED SURFACES IN AREA OF WORK TO BE PREPPED AND RE-PAINTED, UNO
- 5 PROVIDE ARCHITECT WITH SUBMITTALS AND CASEWORK SHOP DRAWINGS FOR APPROVAL

FINISH AND EQUIPMENT LEGEND

CPT-1 MANUF: TYPE: STYLE: COLOR: WEIGHT: NOTE:	CARPET MOHAWK BROADLOOM NEW BASICS III 26 MINERALITE 978 26 OZ TREAD & RISER	LVT-1 MANUF: COLLEC: STYLE: COLOR: ITEM: SIZE: INSTALL: NOTE:	LUXURY VINYL TILE ARMSTRONG PARALLEL USA 20 HIGHTOP HICKORY CARAMEL COVE J5210 6X48 STRAIGHT; OFFSET AS SHOWN AT LOBBY 110, HALL 112
PT-1: MANUF: COLOR: FINISH: NOTE:	GENERAL PAINT SATIN	RB-1: MANUF: COLOR: SIZE: NOTE:	RUBBER BASE JOHNSONITE TBD 6° COVED
PT-2: MANUF: COLOR: FINISH: NOTE: PT-3	HALLWAY SATIN, SEMI-GLOSS BATHROOM	RF-1: MANUF: STYLE: COLOR: TYPE: NOTE:	RESILIENT FLOORING FORBO MARMOLEUM VIVACE 3421 OYSTER MOUNTAIN SHEET HEAT WELD AT SEAMS : MC2629 USED AT STAGE STAR AS WELL
MANUF: COLOR: FINISH: NOTE:	RODDA 0483 INDULGENCE SEMI GLOSS BATHROOM WALLS & CEILING	RF-2: MANUF: STYLE: COLOR:	RESILIENT FLOORING FORBO CONCRETE 3725 COSMOS
PT-4: MANUF: COLOR: FINISH: NOTE:	THEATER: WALLS / PANELS SHERWIN WILLIAMS SW 6107 NOMADIC DESERT SEMI GLOSS	PL-1: MANUF: FINISH: COLOR: INSTALL:	PLASTIC LAMINATE 1 WILSONART MATTE D50-60 KHAKI BROWN
PT-5: MANUF: COLOR: FINISH: NOTE:	THEATER SHERWIN WILLIAMS SW 7593 RUSTIC RED SEMI GLOSS MOLDING / TRIM	PT-2: MANUF: COLOR: FINISH:	DOORS/EXTERIOR OF BASE CABINET, SERVICE SIDE PLASTIC LAMINATE 2 PIONITE AT371 CRESSIDA SUEDE
PT-6: MANUF: COLOR: FINISH: NOTE:	THEATER	T-1: MANUF: STYLE:	COUNTER & BACKSPLASH TILE DALTILE COLOR WHEEL
PT-7: MANUF: COLOR: FINISH: NOTE:	CEILING; MUSEUM, THEATER (DARK) SHERWIN WILLIAMS SW 7020 BLACK FOX FLAT	SIZE: COLOR: INSTALL:	3X6 0100 WHITE HORIZONTAL BRICK PATTERN; 1/2 OVERLAY; FLOOR TO TOP OF MIRROR
PT-8: MANUF: COLOR: FINISH: NOTE:	CEILINGS (LIGHT) SHERWIN WILLIAMS SW 7551 GREEK VILLA FLAT	GROUT: COLOR: SIZE: WB-1: TYPE: HEIGHT: STYLE: PAINT: FINISH:	CUSTOM BUILDING PRODUCTS #335 WINTER GRAY 1/8" WOOD BASE MDF PRIMED 6" STRAIGHT / FLAT WALL COLOR, TYP UNO SEMI GLOSS

ALL PAINTED WALL SURFACES TO SATIN LATEX, UNO

ALL PAINTED METAL SURFACES TO BE SEMI-GLOSS ENAMEL

WF-1: Finish: Note:	EXISTING WOOD FLOOR CLEAN, REPAIR AS NEEDED INFILL MUSEUM FLOOR WHERE INDICATED. NEW WOOD TO CLOSELY MATCH (E) IN SIZE, COLOR. PROVIDE FINAL CLEAR SEAL COAT OF FINISH OVER ENTIRE FLOOR WHERE CLEAR / ABLE.
	ENTIRE FLOOR WHERE CLEAR / ABLE.

ALL PAINTED DOORS, DOOR TRIM, RELITE TRIM, WINDOW TRIM AND BASE TO BE SEMI-GLOSS ENAMEL

ALL PAINTED GYP BOARD CEILINGS IN PUBLIC AREAS TO BE FLAT LATEX UNO

EQUIPMENT

UNENCLOSED VERTICAL PLATFORM LIFT						
MANUF:	GARAVENTA LIFT					
STYLE:	GENESIS OPAL, GVL-OP-42S					
POWER:	PROVIDE AS REQUIRED BY MANUF.					

SHIP LADDER @ STORAGE 115

MODEL: S20A SHIP LADDER HEIGHT: VIF NGLE: 60-75, VERIFY DEPTH AT LOCATION NOTE: MUST MEET ANSI, OSHA SPECIFICATIONS FINISH: STANDAET MUST MEET INISH	HEIGHT: ANGLE: NOTE:	VIF 60-75, VERIFY DEPTH AT LOCATION MUST MEET ANSI, OSHA SPECIFICATIONS
--	----------------------------	---

INTERIOR WOOD WINDOW AT 201

MANUF: MATERIAL:	JELD-WEN OR SIM
MODEL:	SITELINE CLAD WOOD
STYLE:	FIXED PICTURE WITH SIMULATED DIVIDED LITES
GRILLE:	COLONIAL GRILLE CHESTNUT BRONZE
SIZE:	36"H X 60"W
GLASS:	CLEAR
TRIM:	PLAIN 90 FLAT TRIM, DARK ON EXTERIOR, WHITE ON INTERIOR
	1X3 MDF MOULDING OR SIM
SILL:	PAINT GRADE WOOD, PAINTED
NOSING FOR STA	AGE STAIR

MANUF: MATERIAL: MODEL:	JOHNSONITE / TARKETT - VIRCN - XX - B2 OR VIRCN - XX - A
COLOR:	TBD
FWP-1: THICKNESS: EDGE: FABRIC MANUF: STYLE: COLOR: INSTALL:	FABRIC WRAPPED PANEL 1/2" SQUARE GUILFORD OF MAINE CHASE 2138 BUFF 1242 CUSTOM PANELS TO FIT; FABRIT

INSTALL:	CUSTOM PANELS TO FIT; FABRITRAK OR SIM
DR: MANUF:	DRAPERY OFCI SAARIA
FABRIC:	903

WIANUT.	JAANA
FABRIC:	903
COLOR:	BURGUNDY - OL
RATING:	SEE G003

	DOOR SCHEDULE										
NO	TYPE	FROM ROOM	TO ROOM	WIDTH	HEIGHT	DOOR MATL	DOOR FIN	FRAME MATL	FRAME FIN	HDWR GRP	NOTES
110	(E)	ENTRY DOOR	LOBBY 110	E	E	AL (E)		STOREFRONT	NONE	(E)	3
113	D1	UNISEX TOILET/113/	HALL/112/	3'-0"	6'-8"	WD	PT-3	WD	1	2	2
114	D1	UNISEX TOILET/114/	HALL/112/	3'-0"	6'-8"	WD	PT-3	WD	1	2	2
115	D1	HALL/112/	STORAGE	2'-6"	6'-8"	WD	PT-3	WD	1	1	2
116	D1	(E) THEATER SEATING/116/	HALL/112/	3'-0"	6'-8"	WD	PT-3	WD	1	3	2, 9
117	(E)	PLATFORM	BACKSTAGE 118	E	E		PT-	(E)	PT-	(E)	4
118	(E)	BACKSTAGE	EXTERIOR	3'-0"	E	(E)HOLLOW METAL	PT-7	(E) HM	PT-7	(E)	4
119A	(E)	ENTRY DOOR	MUSEUM 119	E	6'-8" (E)	WD	N/A	(E) WD		5	6, 10
119B	D1	(E) MUSEUM/119/	(E) THEATER SEATING/116/	3'-0"	6'-8"	WD	PT-	WD	PT-	3	2
120	(E)	(E) STORAGE/120/	(E) MUSEUM/119/	E	E		WD	N/A		4	5

DOOR NOTES: GENERAL AND KEYED

1. PAINT DOOR FRAMES TO MATCH ADJACENT WALL COLOR - ALL DOORS EXCEPT 110.

2. WOOD FOR DOORS: PAINT GRADE WOOD; STILE & RAIL TYPE DOOR; 20-MINUTE FIRE DOOR EXCEPT WHERE HIGHER RATING REQUIRED. DOORS DI TO HAVE PANEL STYLE SIMILAR TO SIMPSON DOORS 82 TRADITIONAL PANEL OR LYNDEN MOLDED MERCER SOLID CORE. VERIFY DOOR HEIGHT AT SITE.

- 3. (E) STOREFRONT DOORS, NO CHANGE
- 4. (E) DOORS: PAINT BOTH SIDES; NO HARDWARE CHANGE
- 5. EXISTING DOOR REMAIN AS-IS
- 6. ADD STICKER ABOVE DOOR "THESE DOORS TO REMAIN UNCLOSED DURING BUSINESS HOURS"
- 7. DOOR TRIM: NEW AT DOORS 113, 114, 115, 116, 119B
- 8. NEW DOOR FRAMES TO BE WOOD CONSTRUCTION.

-

D1

- 9. PROVIDE WEATHER STRIPPING AROUND FOR ACOUSTIC SEPARATION.
- 10. PROVIDE MINOR SANDING & CLEAR SEAL TO (E) WOOD.

DOOR TYPES



ABBREVIATIONS

AL	ALUMINUM
AL/WD	AMUMINUM CLAD WOOD
CS	CLEAR SEAL
CSMF	CLEAR SEAL BY MANUFA
CTG	CLEAR TEMPERED GLAZ
E	EXISTING
FTG	FROSTED TEMPERED GL
FG	FIRE GLAZING
FR	FIRE RATED
HM	HOLLOW METAL
KDF	METAL KNOCKDOWN FRA
MFR	MANUFACTURER
PT	PAINT
WD	WOOD



deca architecture.inc

935 SE Alder Street : Portland Oregon 97214 tel 503 239 1987 fax 503 239 6558 deca-inc.com



Woodburn Museum / Theater Renovation

455 N. Front St., Woodburn, OR 97071

GRP 3: 116, 119 B

3 EA HINGES 1 EA PASSAGE LEVER STYLE: SCHLAGE ATHENS FINISH: 643-E

1 EA FLOOR STOP SILENCERS 1 EA IVES KICK DOWN DOOR HOLDER FINISH: OIL RUBBED BRONZE

GRP 4: 120

EACH (E) DOOR ON MUSEUM SIDE: ADD: VIES 8111-5 SOLID DOOR PULL FINISH: 631 MATTE BLEACH MOUNT: 36" TO CENTER NOTE: VERIFY THESE ARE REQUIRED.

CARRY \$500 ALLOWANCE: IF REQUIRED AT DOOR 119 A EXIT DEVICE FOR (E) DOORS

Iss	ue	Revision	Date
PERMIT	SET		08/12/21

ACTURER ZING

LAZING

AME

ROOM FINISH LEGEND, SCHEDULE AND MATERIAL & DOOR SCHEDULE

Scale Date

As indicated 08/12/2021



SPECIFICATIONS

01 20 90 SCHEDULE OF VALUES CONTRACTOR TO SUBMIT SCHEDULE OF VALUES TO ARCHITECT AND OWNER

CONTRACTOR TO SUBMIT SCHEDULE OF VALUES TO ARCHITECT AND OWNER 15 DAYS PRIOR TO FIRST APPLICATION FOR PAYMENT. SEPARATELY LIST VALUE OF EACH MAJOR WORK ITEM. EACH SUBCONTRACTED WORK ITEM, AND ANY PRODUCTS TO BE STORED FOR WHICH SEPARATE PAYMENT WILL BE REQUESTED. INCLUDE CONTRACTOR'S OVERHEAD AND PROFIT IN EACH LISTING. SUM OF VALUES SHALL EQUAL TOTAL CONTRACT SUM. SUBMIT SUBSTANTIATING DATA IF REQUESTED BY ARCHITECT.

01 23 00 ALTERNATES

ALTERNATE WORK IS IDENTIFIED IN THE BID DOCUMENTS. MINOR ADJUSTMENTS TO EXPOSED FINISH SURFACES, OR CONCEALED WORK BY THE INCORPORATION OF THE SELECTED ALTERNATES MAY OR MAY NOT BE INDICATED ON DRAWINGS OR BE SPECIFIED IN THE REFERENCED INDICATED ON DRAWINGS OR BE SPECIFIED IN THE REFERENCED SPECIFICATIONS. INCLUDE ADJUSTMENTS IN WORK AS REQUIRED TO ACHIEVE THE INTENDED RESULT. COORDINATE WORK MODIFIED BY THE INCORPORATION OF THE ALTERNATES. THE OWNER RESERVES THE RIGHT TO ACCEPT OR REJECT ANYONE OR ALL OF THE ALTERNATES. THE OWNER RESERVES THE RIGHT TO REINSTATE ALTERNATE BIDS AT ANY TIME WITHIN 30 DAYS AFTER CONTRACT AWARD.

013119 PROJECT MEETINGS CONTRACTOR WILL SCHEDULE PRE-CONSTRUCTION MEETING AND PROVIDE MEETING MINUTES. WEEKLY MEETINGS SHALL BE HELD AT JOBSITE BY CONTRACTOR, WHO SHALL DISTRIBUTE MEETING AGENDA IN ADVANCE OF MEETING AND RECORD MEETING MINUTES.

01 32 00 CONSTRUCTION PROGRESS DOCUMENTATION PREPARE AND SUBMIT TO ARCHITECT AND OWNER AN ESTIMATED PROGRESS SCHEDULE OF THE WORK. REVISE SCHEDULE WHEN APPROPRIATE. SUBMIT INITIAL SCHEDULE BY OR BEFORE PRE-CONSTRUCTION CONFERENCE.

01 33 00 SUBMITTALS

01 41 28 DESIGN BUILD

DESIGN-BUILD FLEMENTS THAT ATTACH TO STRUCTURAL FRAME OR ARE

DESIGN-BUILD ELEMENTS THAT ATTACH TO STRUCTURAL FRAME OR ARE SUPPLEMENTAL TO STRUCTURAL FRAME SHALL BE DESIGNED FOR ANTICIPATED LOADS REQUIRED BY THE INTERNATIONAL BUILDING CODE AS MODIFIED BY THE OREGON STRUCTURAL SPECIALTY CODE. COORDINATE DESIGN-BUILD ELEMENTS WITH APPROPRIATE SUBCONTRACTORS. DESIGN-BUILD INCLUDES BUT IS NOT LIMITED TO: HVAC; ELECTRICAL; STRUCTURAL WORK REQUIRED FOR ANY LOAD BEARING WALLS.

01 50 00 TEMPORARY FACILITIES AND CONTROLS CONTRACTOR TO PROVIDE TEMPORARY CONSTRUCTION FACILITIES REQUIRED FOR COMPLETION OF WORK INCLUDING FIELD OFFICE, COMMUNICATIONS EQUIPMENT, POWER DISTRIBUTION, WATER, TOILET FACILITIES, BARRICADES, EXTERIOR ENCLOSURES, FENCING, FIRE PROTECTION, LIGHTING, HEATING, AND VENTILATION

017419 CONSTRUCTION WASTE MANAGEMENT AND WASTE DISPOSAL REUSE OR RECYCLE DEBRIS GENERATED AS A RESULT OF WORK PERFORMED ON THE FROJECT WHEN PRACTICAL AND COST EFFECTIVE.

NON-USABLE ITEMS OR MATERIALS WILL BE DISPOSED OF IN THE MOST ENVIRONMENTALLY SENSITIVE MANNER AS DEFINED OR APPROVED BY THE OWNER. MINIMIZE THE IMPACT OF CONSTRUCTION WASTE ON LANDFILLS.

02 41 00 DEMOLITION SEE PROJECT MANUAL.

UTILITIES: COORDINATE DEMOLITION WORK WITH AFFECTED ELECTRICAL AND MECHANICAL WORK. REMOVE EXISTING UTILITY SERVICES WHICH ARE NOT A PART OF NEW WORK OR DESIGNATED TO REMAIN. FOR OF NEW WORK OR DESIGNALED TO REMAIN. SAVE AND PROTECT EXISTING UTILITIES SHOWN TO REMAIN. NOTIFY ARCHITECT AT ONCE IF UNKNOWN UTILITIES ARE FOUND IN THE WORK. COMPLY WITH THE APPLICABLE LAWS AND ORDINANCES GOVERNING TH VIDEO AN CONCENTRATION OF DESIGN OF DESIGN OF DESIGN. DISPOSAL OF DEBRIS.

IF DURING THE COURSE OF THE DEMOLITION WORK, THE CONTRACTOR OBSERVES OR SUSPECTS THE EXISTENCE OF HAZARDOUS MATERIAL IN THE BUILDING, THE CONTRACTOR SHALL IMMEDIATELY STOP WORK IN THAT AREA AND PROMPTLY NOTIFY THE OWNER, COORDINATE WITH THE OWNER THE REMOVAL OF HAZARDOUS MATERIAL BY OTHER CONTRACTORS SO AS NOT TO DELAY THE WORK

06 10 00 ROUGH CARPENTRY GYPSUM WALL SHEATHING TO BE G-P DENSGLASS GOLD EXTERIOR GUARD, NATIONAL GYPSUM GOLD BOND E2XP OR APPROVED, PAPERLESS AND MOLD-RESISTANT, ASTM C-1177, 5/8 INCH THICKNESS UNO.

07 84 00 FIRESTOPPING FIRESTOPPING TO BE BIDDER DESIGNED WHERE NEEDED. IN ACCORDANCE WTH GOVERNING LAWS, REGULATIONS, CODES, AND REQUIREMENTS SEAL OPENINGS THROUGH FIRE-RATED ASSEMBLIES AS REQUIRED TO PREVENT THE PASSAGE OR SPREAD OF FLAME. SMOKE, AND HOT GASES, INCLUDING: MECHANICAL PIPING, DUCTWORK, AND ELECTRICAL CONDUIT PASSING THROUGH LEFE PATED MAILS ELOGES AND CENTRICAL CONDUCTIONS. THROUGH FIRE-RATED WALLS, FLOORS, AND CEILINGS; OPEN JOINTS LOCATED BETWEEN ADJACENT FIRE-RATED WALLS, FLOORS, & CEILINGS.

CONTRACTOR TO SCHEDULE A FIRESTOPPING MEETING WITH THE BUILDING CONTRACTOR TO SCHEDULE A FIRESTOPPING MEETING WITH THE BUILDING INSPECTOR AND ALL SUBCONTRACTORS THAT WILL BE INSTALLING FIRESTOPPING MATERIALS. EACH SUBCONTRACTOR WILL PROVIDE A LIST OF FIRESTOP MATERIALS/ASSEMBLIES WHICH WILL BE USED, THE TYPE OF PENETRATIONS WHERE EACH MATERIAL/ASSEMBLY WILL BE USED; AND THE LISTING AND APPROVAL INFORMATION (I.E. UL, ICBO, ICC RO THER APPROVED REPORT / JUSTING NUMBERS.) THIS INFORMATION MUST BE SUBMITTED TO, AND APPROVED BY, THE BUILDING INSPECTOR PRIOR TO ANY INSTALLATION. (SEE CITY OF PORTLAND FIRESTOPPING PROGRAM GUIDE AT: HTTP//WWW.BDS.CI.PORTLAND.OR.US/PUBS/PROGRAM%20GUIDE/PDF/WEB% 20FIRESTOPPING.PDF)

07 92 00 JOINT SEALANTS FURNISH ALL LABOR, MATERIALS, EQUIPMENT, AND SERVICES NECESSARY FOR THE FURNISH ALL LABOR, MATERIALS, EQUIPMENT, AND SERVICES NECESSARY FOR THE INSTALLATION OF BUILDING SEALANTS FOR WEATHERPROOFING AND JOINT FILLING INCLUDING, BUT NOT LIMITED TO ROOFTOP PENETRATIONS. FOLLOW ASTM AND FEDERAL SPECIFICATIONS THAT MAINTAIN WATERTIGHT AND AIRTIGHT CONTINUOUS SEALS THAT DON'T STAIN OR DETERTIORATE OVER TIME. FOLLOW ASTM GUIDELINES FOR TESTING ON SITE. MATERIALS DELIVERED TO SITE TO BE STORED AND HANDLED IN COMPLIANCE WITH MANUFACTURER'S RECOMMENDATION TO PREVENT DETERTIORATION OR DAMAGE. JOINT SEALANTS TO BE INSTALLED UNDER CORRECT ENVIRONMENTAL CONDITIONS, AND TESTED TO MEET ACCEPTABLE ADHESION, COMPLIANCE. COMPLIANCE

INSTALLER'S WARRANTY: TWO YEARS FROM DATE OF SUBSTANTIAL COMPLETION. MANUFACTURER'S WARRANTY: TYPICAL DURATION PER SEALANT TYPE AND MANUFACTURER. SOME ACCEPTABLE PRODUCTS INCLUDE SEALANTS PRODUCED BY: DOW CORNING, PECORA, GE SILPRUF, TREMCO, PROSOCO. PROVIDE PROPER PREPARATION, BACKING, PRIMING, INSTALLATION AND INSPECTION PER MANUFACTURER'S RECOMMENDED INSTALLATION

98 21 99 WOOD DOORS FABRICATE DOORS TO BE FIRE-RESISTIVE WHERE SCHEDULED IN ACCORDANCE WITH UL REQUIREMENTS; AFIX UL LABEL TO EACH DOOR.

MANUFACTURER: GRAHAM, LYNDEN, MOWHAWK, OREGON DOOR, EGGERS VANCOUVER OR APPROVED AWI GRADE: CUSTOM (AT OPAQUE FINISH DOORS) TYPE: SEE DRAWINGS

TYPE: SEE DRAWINGS.

CONSTRUCTION: 7 PLY

CORES: AS REQUIRED TO MEET CODE AT FIRE RATED DOORS SOLID CORE AT UNIT ENTRY DOORS FACE VENEER: SOUND, CLOSE-GRAINED HARDWOOD OF FABRICATORS CHOICE, AWI

GRADE B

MIN. THICKNESS: 1/50TH ON AN INCH AT 12% MOISTURE CONTENT HEAD RAIL: MIN HEIGHT 8"

EDGE BANDS: MULTI-PLY LAMINATE AND INTUMESCENT TO MEET CODE AT FIRE RATED DOORS OTHERWISE HARDWOOD, MIN. THICKNESS 1/2"

08 31 00 ACCESS DOORS AND PANELS FURNISH ALL LABOR, MATERIAL, EQUIPMENT AND SERVICES FOR THE INSTALLATION OF ACCESS PANELS IN WALLS AND CEILINGS FOR ACCESS TO CONCEALED EQUIPMENT AND CLOSED SPACES AS REQUIRED.

SOME ACCEPTABLE MANUFACTURERS: ACUDOR, UF-5500, NON-RATED(7), UNIVERSAL, WALL-CEILING, FLANGED TYPE. OTHER MANUFACTURERS: ACCESS PANEL SOLUTIONS, INC., BABCOCK-DAVIS, CIERRA PRODUCTS, ELMDOR, NYSTROM

FURNISH AND INSTALL MINIMUM 24-INCHES X 24-INCHES CEILING ACCESS PANELS AND FORMULT AND INSTRUCTION CANCELS PARELS, ALL ACCESS PARELS SHALL OPEN A INSTRUCTION OF 00 DEGREES. MINIMUM 24-INCHES X 24-INCHES OR CRAVIL ACCESS, LARGER SIZES AS DETAILED OR SUITABLE FOR MINITENANCE ACCESS TO CONCEALED EQUIPMENT AND DEVICES

FURNISH CYLINDER LOCKS TO MATCH BRAND AND KEYWAY DESIGN OF CYLINDER LOCKS. FASTEN DOOR PANELS TO FRAMES WITH CONTINUOUS HINGE, SUPPLY ACCESS DOORS AND PANELS WITH FACTORY-APPLIED WHITE RUST-INHIBITIVE PRIME COAT. INSTALL ALL PANELS IN ACCORDANCE WITH MANUFACTURER'S STANDARD SPECIFICATIONS AND RECOMMENDATIONS.

PROVIDE ACCESS PANELS IN NON-ACCESSIBLE WALLS AND CEILINGS WHEREVER THERE IS EQUIPMENT OR A DEVICE THAT NEEDS MAINTENANCE DIRECTLY UNDER OR IN FRONT OF THE EQUIPMENT OR DEVICE TO ENABLE SERVICE PERSONNEL TO REACH AND SERVICE EQUIPMENT. PANELS SHALL BE SIZED TO ACCOMMODATE THE LARGEST PIECE OF EQUIPMENT. PROVIDE ACCESS TO ALL MAINTAINED EQUIPMENT SUCH AS FIRE DAMPERS, SMOKE DAMPERS, VALVES, RELAYS, RESETS, MONITOR DEVICES, ETC. COORDINATE ELEMENTS BEING INSTALLED BY MULTIPLE TRADES TO ENSURE CLEAR ACCESS TO ELEMENTS REQUIRING MAINTENANCE. PROVIDE REINFORCING, BACKING OR BLOCKING AS REQUIRED

98.71.00 DOOR HARDWARE SUBMIT DOOR HARDWARE SCHEDULE PRIOR TO ORDERING AND INSTALLATION. CONFORM TO UL REQUIREMENTS FOR FIRE-RATED OPENINGS. WARRANT CLOSERS FOR 10 YEARS AGAINST FAULTY OPERATION. PROVIDE KEYING AS REQUIRED BY OWNER AND PERMANENT KEYS INCLUDING MULTIPLE CHANGE KEYS, MASTER KEYS, GRAND MASTER KEYS AND KEY BLANKS.

PROVIDE EXTERIOR EMERGENCY ACCESS KEY STORAGE BOX, KNOX CO, OR APPROVED, RECESSED, AND MEETING AHJ FIRE MARSHAL REQUIREMENTS FOR LICENSING AND ACCESS AS REQUIRED.

09 20 00 GYPSUM BOARD

09 90 00 PAINTING SEE PROJECT MANUAL

10 20 00 EXTERIOR WALL LOUVERS AND VENTS IF REQUIRED: CONSTRUCT WITH ALUMINUM OR GALVANIZED STEEL. PROVIDE BIRD SCREEN, COORDINATE WITH MECHANICAL REQUIREMENTS.

10 44 00 FIRE PROTECTION SPECIALTIES PROVIDE SEMI-RECESSED FIRE EXTINGUISHER CABINETS AT ALL NEW FEC LOCATIONS, EXCEPT WHERE CONDITIONS PERMIT INSTALLATION OF FULLY RECESSED CABINET. CABINET FINISH TO BE WHITE POWDER COATED STELL OR STAINLESS STEEL, VERIFY PER LOCATION WITH DESIGNER. PROVIDE FIRE EXTINGUISHERS TO MEET CODE.

23 00 00 - MECHANICAL SYSTEMS

GENERAL PROVISIONS

1.1 GENERAL REQUIREMENTS:

DRAWINGS AND GENERAL PROVISIONS OF THE CONTRACT, INCLUDING GENERAL AND OTHER CONDITIONS AND DIVISION 1 - GENERAL REQUIREMENTS SECTIONS APPLY FOR THE WORK SPECIFIED IN THIS SECTION.

1.2 SCOPE OF WORK:

- A. THE WORK COVERED BY THIS SPECIFICATION SHALL INCLUDE FURNISHING ALL LABOR, MATERIALS," EQUIPMENT AND SERVICES TO DESIGN, CONSTRUCT AND INSTALL RESTROOM EXHAUST FANS. VERIFY ALL CONDITIONS ON THE JOB SITE AND LAY OUT WORK ACCORDINGLY, PERMITS AND DESIGN
- FEES ARE TO BE PAID BY THE MECHANICAL CONTRACTOR.
- B. PROVIDE INLINE EXHAUST WITH DIRECT DRIVE FOR THE RESTROOMS: 100 CFM EXHAUSTED TO THE EXTERIOR. EXHAUST FANS TO BE INDIVIDUALLY SWITCHED FROM THE LIGHTS PER CODE; OPERATED BY AN OCCUPANCY SENSOR.
- C. INVESTIGATE AND BE APPRISED OF APPLICABLE CODES, RULES, AND REGULATIONS AS ENFORCED,

1.3 RELATED WORK

- A. THE GENERAL PROVISIONS APPLY TO THIS DIVISION, INCLUDING BUT NOT LIMITED TO: DRAWINGS AND SPECIFICATIONS.
- 1. DRAWINGS AND SPECIFICATIONS. 2. CONTRACT MODIFICATIONS, ADDENDUMS AND CHANGE ORDERS. B. CUTTING AND PATCHING, THE COST OF CUTTING AND PATCHING REQUIRED WORK OF DIVISION 23 AND NOT SHOWN IN OTHER DIVISIONS OF WORK SHALL BE INCLUDED IN THE COST OF DIVISION 23. C. INSTALLATION ONLY OF ACCESS PANELS IN CEILINGS OF RESTROOMS; PROVIDE ACCESS PANELS AS PART OF MECHANICAL WORK; COORDINATE W/ DRYWALL CONTRACTOR.

I.4 QUALITY ASSURANCE REGULATORY REQUIREMENTS:

- 1. ALL WORK, INSTALLATIONS, MATERIALS AND EQUIPMENT SHALL COMPLY WITH THE PROVISION OF THE FOLLOWING CODES, STANDARDS AND REGULATIONS, EXCEPT WHERE MORE STRINGENT REQUIREMENTS ARE SHOWN OR SPECIFIED:
- A. STATE OF OREGON INTERNATIONAL MECHANICAL CODE. (IMC)
- B. STATE OF OREGON PLUMBING SPECIALTY CODE. (UPC) C. STATE OF OREGON STRUCTURAL SPECIALTY CODE. (IBC)
- NATIONAL ELECTRICAL CODE (NEC)
- NATIONAL FIRE PROTECTION AGENCY (NEPA)
- E. NATIONAL INCLEMENTATION AGENCIE (IN FAC) F. ALL CITY, COUNTY, STATE AND FEDERAL APPLICABLE LAWS AND REGULATIONS. G. REGULATIONS AND STANDARDS SET FORTH BY ASME, ASHRAE, SMACNA, AGA AND ARI.

- 2. SHOULD THERE BE ANY DIRECT CONFLICT BETWEEN CODES AND THE DRAWINGS AND SPECIFICATIONS, THE CODES, RULES AND REGULATIONS SHALL GOVERN. 3. WHERE TWO OR MORE CODES OR REGULATIONS APPLY, THE MORE STRINGENT OF THE TWO SHALL BE EXERCISED.

- BE EXERCISED. 4. SHOULD THE DOCUMENTS INDICATE A CONDITION, WHICH WILL CONFLICT WITH THE CODES, THE CONTRACTOR SHALL INFORM THE OWNER'S REPRESENTATIVE AND REFRAIN FROM INSTALLING THAT PORTION UNTIL RESOLVED. ANY WORK INSTALLED IN VIOLATION OF THE CODES WILL BE REMOVED AND CORRECTLY INSTALLED AS PART OF THE CONTRACT WORK. 5. IF THE DRAWINGS AND SPECIFICATIONS INDICATE A HIGHER QUALITY THAN CODE, THE DRAWINGS 4. IN DROP MONTON PONCHING FOR THE CONTRACT WORK.
- AND SPECIFICATIONS SHALL GOVERN. 6. ELECTRICAL PRODUCTS SHALL BEAR THE U.L. LABEL

26 05 33 CONDUITS A. GALVANIZED RIGID STEEL CONDUIT (GRC):

A, ORL VANIZED WIDD STEEL CONDOIL (BOR). I. HOT-DIP GALVANIZED AFTER THREAD CUTTING. 2. MANUFACTURE IN CONFORMANCE WITH FEDERAL SPECIFICATION WWC-581 AND ANSI C80.1. 3. UNIFORM FINISH COAT WITH CHROMATE FOR ADDED PROTECTION.

- B. RIGID ALUMINUM CONDUIT: ALLOY 6063, THREADED AT EACH CONNECTION

- C. INTERMEDIATE METAL CONDUIT (IMC): 1. HOT-DIP GALVANIZED AFTER THREAD CUTTING. 2. MANUFACTURE IN CONFORMANCE WITH FEDERAL SPECIFICATION WWC-581. 3. UNIFORM FINISH COAT WITH CHROMATE FOR ADDED PROTECTION.
- D. ELECTRICAL METALLIC TUBING (EMT): 1. HOT-DIP GALVANIZED AND CHROMATE COATED.
- 2. MANUFACTURE IN CONFORMANCE WITH FEDERAL SPECIFICATION WWC-563 AND ANSI C80.3.
- E. FLEXIBLE CONDUIT NOT ALLOWED



deca architecture.inc

935 SE Alder Street : Portland Oregon 97214 **tel** 503 239 1987 **fax** 503 239 6558 **deca-inc.com**

STERED ARCH Hyn FOF OF OR

Woodburn Museum / Theater Renovation

455 N. Front St., Woodburn, OR 97071

Issue	Revision	Date
PERMIT SET		08/12/21

SPECIFICATIONS

Scale 12" = 1'-0" Date Sheet No.



SPECIFICATION SECTION 05515: LADDERS O'Keeffe's Aluminum Ladders PART 1 GENERAL 1.1 SECTION INCLUDES

A. Aluminum access ladders B. Aluminum ship's ladders. C. Aluminum cade ladders

1.2 RELATED SECTIONS

A. Section 05500 - Metal Fabrications: Fasteners and installation requirements used to attach ladders to structure Section 14200 – Elevators: For pit ladders.
 C. Section 15050 – Basic Electrical Materials and Methods: For electrical grounding of ladders

1.3 REFERENCES

A. AA – Aluminum Association.
 B. ASTM B 209 - Standard Specification for Aluminum and Aluminum-Alloy Sheet and Plate.
 C. ASTM B 221 - Standard Specification for Aluminum and Aluminum-Alloy Extruded Bars, Rods, Wire, Profiles, and Tubes.
 D. OSHA 1910.27 – Fixed Ladders.

1.4 SUBMITTALS

A. Submit under provisions of Section 01300.

B. Product Data: Manufacturer's data sheets on each product

2. Provide templates for anchors and bolts specified for installation under other Sections.

Provide templates for anchors and botts specified for installation under other Sections.
 Provide reaction loads for each hanger and bracket.
 Qualification Data:
 Refer to Quality Assurance provisions for submittal requirements evidencing experience, certifications and resources.
 Selection Samples: For each finish specified, two complete sets of color chips representing manufacturer's full range of available colors.
 Verification Samples: For each finish specified, two samples, minimum size 6 inches (150 mm) square, represent actual product color.

1.5 QUALITY ASSURANCE

A. Manufacturer Qualifications: A firm experienced in producing aluminum metal ladders similar to those indicated for this Project. Record of successful in-service performance.

2. Sufficient production capacity to produce required units 3. Professional engineering competent in design and structural analysis to fabricate ladders in compliance with industry standards and local

B. Installer Qualifications: Competent and experienced firm capable of selecting fasteners and installing ladders to attain designed operational and structural performance.

C. Product Qualification: Product design shall comply with OSHA 1910.27 minimum standards for ladders.

D. Mock-Up: Provide a mock-up for evaluation of surface preparation techniques and application workmanship.

MOL-OP, Fronces a flock-op for evaluation or source preparation reclamptes and application won 1. Install ladder in area designated by Architect.
 Do not proceed with remaining work until workmanship and installation are approved by Architect.
 Rework mock-up as required to produce acceptable work.

1.6 DELIVERY, STORAGE, AND HANDLING

A. Store products in manufacturer's unopened packaging until ready for installation

1.7 PROJECT CONDITIONS

A. Field Measurements: Verify dimensions by field measurement before fabrication. 1. Established Dimensions: Where field measurements cannot be made without del

ements cannot be made without delaying the Work, indicate established dimensions on shop drawing submittal and proceed with fabrication.

1.8 WARRANTY

A. A. Manufacturer has responsibility for an extended Corrective Period for work of this Section for a period of 5 years commencing on the shipment date of the product against all the conditions indicated below, and when notified in writing from Owner, manufacturer shall promptly and without inconvenience and cost to Owner correct said deficiencies.

 Defects in materials and workmanship.
 Deterioration of material and surface performance below minimum OSHA standards as certified by independent third party testing laboratory. Ordinary wear and tear, unusual abuse or neglect excepted. 3. Within the warranty period, the manufacturer shall, at its option, repair, replace, or refund the purchase price of defective ladder.

B. Manufacturer shall be notified immediately of defective products, and be given a reasonable opportunity to inspect the goods prior to Dr. manufacturer sinan de inclined immeduately of before the products, and be given a reasonable option of the product and the product and

1 9 EXTRA MATERIALS

A. Furnish touchup kit for each type and color of paint finish provided.

2.1 MANUFACTURERS

A. Acceptable Manufacturer: O'Keeffe's, Inc.; 100 N Hill Drive, Suite 12, Brisbane, CA 94005. Toll Free Tel: (888) 653-3333. Tel: (415) 824-4900. Fax: (415) 824-5900. Email: info@okeeffes.com. Web: http://www.okeeffes.com.

B. Substitutions: Not permitted. C. Requests for substitutions will be considered in accordance with provisions of Section 01600.

2.2 APPLICATIONS/SCOPE

A. Fixed and Cage Ladder Design:
1. Safety cages are required on ladders over 24 feet (7315 mm)
2. Safety cages are required on all ladders in high or hazardous areas.
3. Landing platforms are required at 50 feet (15,240 mm) above the bottom of the ladder.
4. Rail and harness fall arrest system as alternate to safety cage and landing platforms shall be a permissible manufacturer's option.
a. Fixed Ladder Bottom Bracket:
b. Bottom wall supported bracket.
d. Bracket as drawn.

B. Fixed Access Ladder

- Standard Duty Channel Rail.
 a. Model 500 as manufactured by O'Keeffe's Inc.
- 2. Heavy Duty Tubular Rail.
- a. Model 501 as manufactured by O'Keeffe's Inc

Tubular Rail Low Parapet Access Ladder with Roofover Rail Extension
 Model 502 as manufactured by O'Keeffe's Inc.

- Tubular Rail Low Parapet Access Ladder with Platform and Return.
 Model 503 as manufactured by O'Keeffe's Inc.

- a. moder suc as manuactured by O Keene's inc. 5. Tubular Rail Low Parapet Access Ladder with Platform. a. Model 503A as manufactured by O Keeffe's Inc. 6. Tubular Rail Low Parapet Access Ladder with Walk-through Rail Extension a. Model 504 as manufactured by O Keeffe's Inc.

- C. Cage Ladder: 1. Cage Ladder with Roof Hatch Rail Extension. a. Model 531 as manufactured by O'Keeffe's Inc. 2. Cage Ladder with Roofover Rail Extension. a. Model 532 as manufactured by O'Keeffe's Inc.

- 3. Cage Ladder with High Parapet Access, Platform and Return.
- Model 533 as manufactured by O'Keeffe's Inc.
- Cage Ladder with High Parapet Access, Platform and No Return
- Model 533A as manufactured by O'Keeffe's Inc
- Tubular Rail Low Parapet Cage Ladder with Walk-through Extension.
 Model 534 as manufactured by O'Keeffe's Inc.

- D. Ship Ladder: 1. Ships Ladder. a. Model 520 as manufactured by O'Keeffe's Inc. 2. Ship Ladder with Platform. a. Model 521 as manufactured by O'Keeffe's Inc. O Note of Advanter Defension and Pacific Advanter of the P
- 3. Ship Ladder with Platform and Return. a. Model 522 as manufactured by O'Keeffe's Inc.
- 4. Ship Ladder with Access to Roof Hatch.
- a. Model 523 as manufactured by O'Keeffe's Inc
- 5. Incline
- a. 60 degree
 b. 75 degree
 c. As drawn.
- 2.3 FINISHES
- A. Mill finish. As extruded.
 B. Clear Anodic Finish: AAA-M10C22A41 Mechanical finish as fabricated. Architectural Class I, clear coating
 0.018 mm or thicker.
 C. Paint Urethane over chemically pretreated substrate.
- 1. Fire Red (RAL 2002). 2. Alert Orange (RAL 2003)
- Warning Blue (RAL 5005).
 Caution Yellow (RAL 1018)
- 5. Safety Green (RAL 6001). 6. As scheduled on drawings
- 2.4 MATERIALS

A. Aluminum Sheet: Alloy 5005-H34 to comply with ASTM B209. B. Aluminum Extrusions: Alloy 6063-T6 to comply with ASTM B221

2.5 FABRICATION

A. Rungs: Not less than 1-1/4 inches (32 mm) in section and 18-3/8 inches (467mm) long, formed from tubular aluminum extrusions. Squared and deeply serrated on all sides. 1. Rungs shall withstand a 1,500 pound (454 kg) load without deformation or failure.

B. Channel Side Rails: Not less than 1/8 inch (3 mm) wall thickness by 3 inches (76 mm) wide.

C. Heavy Duty Tubular Side Rails: Assembled from two interlocking aluminum extrusions no less than 1/8 inch (3 mm) wall thickness by 3 inches (76 mm) wide. Construction shall be self-locking stainless steel fasteners, full penetration TIG welds and clean, smooth and burr-free surfaces.

D. Ship Ladders: Not less than 1-1/4 inches (32mm) high, 4-1/8 inch (105 mm) deep and 2 feet (610 mm) wide; tread spacing shall be 1 foot (305 mm) on center. Handrails shall be aluminum pipe, not less than 1 wide; tread spacing shall be 1 foot (305 mm) on center. inches (38 mm) in diameter with hemispheric end caps not less than 1-1/2

E. Walk-Through Rail and Roof Rail Extension: Not less than 3 feet 6 inches (1067 mm) above the landing and shall be fitted with deeply serrated, square, tubular grab rails.

F. Landing Platform: 1-1/2 inches (38 mm) or greater diameter, tubular aluminum guardrails and decks of serrated aluminum treads.

G. Security Doors: Formed 1/8 inch (3 mm) thick aluminum sheet. Security panels shall extend on both sides, perpendicular to the door face, to within 2 inches (51 mm) of the wall. Security door shall be furnished with continuous aluminum piano hinge and heavy duty forged steel locking hasps.

H. Ship Ladder Seismic Bottom Support; Manufacturer's standard; two isolation bearings per stringer.

L Ladder Safety Post: Retractable hand hold and tie off.

A. Protect installed products until completion of project.

B. Touch-up, repair or replace damaged products before Substantial Completion.

J. Rail and Harness Fall Arrest System: Supplied where specified as alternate to safety cage and landing platforms, in accordance with OSHA regulation 1910.27; permanently mounted to ladder rungs and complete with necessary components.

K. Safety Cages: 1. Fabricate ladder safety cages to comply with authority having jurisdiction. Assemble by welding. Spacing of primary hoops, secondary hoops and vertical bars shall not exceed that required by code. 2. Safety cage hoops and vertical bars: 3/16 inch (5 mm) by 2 inches (51 mm) aluminum bar.

PART 3 EXECUTION 3.1 EXAMINATION

3.3 PROTECTION

END OF SECTION


A. Coordinate anchorages. Furnish setting drawings, templates, and anchorage structural loads for fastener resistance

B. Do not begin installation until supporting structure is complete and ladder installation will not interfere with orting structure work

C. If supporting structure is the responsibility of another installer, notify Architect of unsatisfactory supporting work before proceeding. 3.2 INSTALLATION

A. Install in accordance with manufacturer's instructions and in proper relationship with adjacent construction

In the interest of continuous improvement of its product line, O'Keeffe's reserves the right to modify its products' composition, colors, textures, sizes, and other physical and performance attributes and these guide specifications at any time. O'Keeffe's makes no expressed or implied warranties regarding content, errors, or omissions in the information presented. Specifications modified or rewritten not in conformance with manufacturer's standard processes, products, and procedures may void warranties and related remedies.

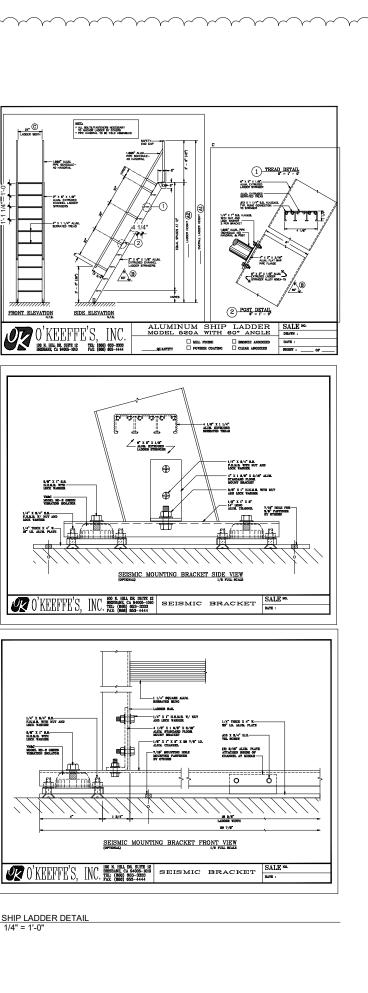

HOTE: ALL BOLTS,/TASTENERS MECESSARY TO ANCHOR LADDER BY OTHERS PREVANDRAL TO BE FELD ASSEMBLED

SIDE ELEVATION

1.000" ALUV.--PIPE SCHEDULE 40 HANDRAL

₩-

*(*س

- 2" X 6" X 1/8" ALUM EXTRUDED CHANNEL LADDER STRINGERS

<u>316 316 316</u>

 \oplus

₽

æ

1 1/4" SQUARE AL

-1/4" X 1" BRMB W/ NUT

4 1/2" X 1 8/8" X 8/16" ALUM, STANDARD FLOOR

-7/16" MOUNTING HOLE MOUNTING PASTENER BY OTHERS

-1/6" X 1" X 3" X 39 7/8" 10. ALUM CHANNEL

odilb*

∎**d**∰b

ز 🖻

24* C

FRONT ELEVATION

- 1.666" ALUM. PIPE SCHEDULI

2" X 6" X 1/6" ALUM, EXTRUDED CHANNEL LADDER STRINGERS

-4" X 1 1/4" ALU SERRATED TREAD

O'KEEFFE'S, INC

S/O X 1 S.S. H.H.M.B. WITH --

1/4" X S/4" S.S. F.H.M.B. W/ NUT AND

1/4" X S/4" S.S. P.H.M.B. WITH NUT AND LOCK WASHER

8/8" X 1" 8.8.-H.H.M.B. WITH LOCK WASHER

1 SHIP LADDER DETAIL

VIAC-NODEL RD-2 GREEN VIBRATION ISOLATOR

£ fin

VIAC NODEL RD-2 CREEN VIBRATION ISOLATOR

100 N. HILL DR. SUITE 12 TEL: (888) 653-3333 BRISBANE, CA 94005-1010 PAX: (888) 653-4444



deca architecture.inc

935 SE Alder Street : Portland Oregon 97214 tel 503 239 1987 fax 503 239 6558 deca-inc.com



Woodburn Museum / Theater Renovation

455 N. Front St., Woodburn, OR 97071

Issue	Revision	Date
PERMIT SET		08/12/21
PERMIT REVISION	1	09/27/2021

SHIP LADDER **SPECIFICATION**

Scale Date

⚠

As indicated 08/12/202

