

INDEX OF DRAWINGS


SHEET NO.

TITLE

TITLE SHEET
DEMOLITION AND PAVING PLAN

CURB AND STRIPPING PLAN

ODOT AREA DRAIN RD374

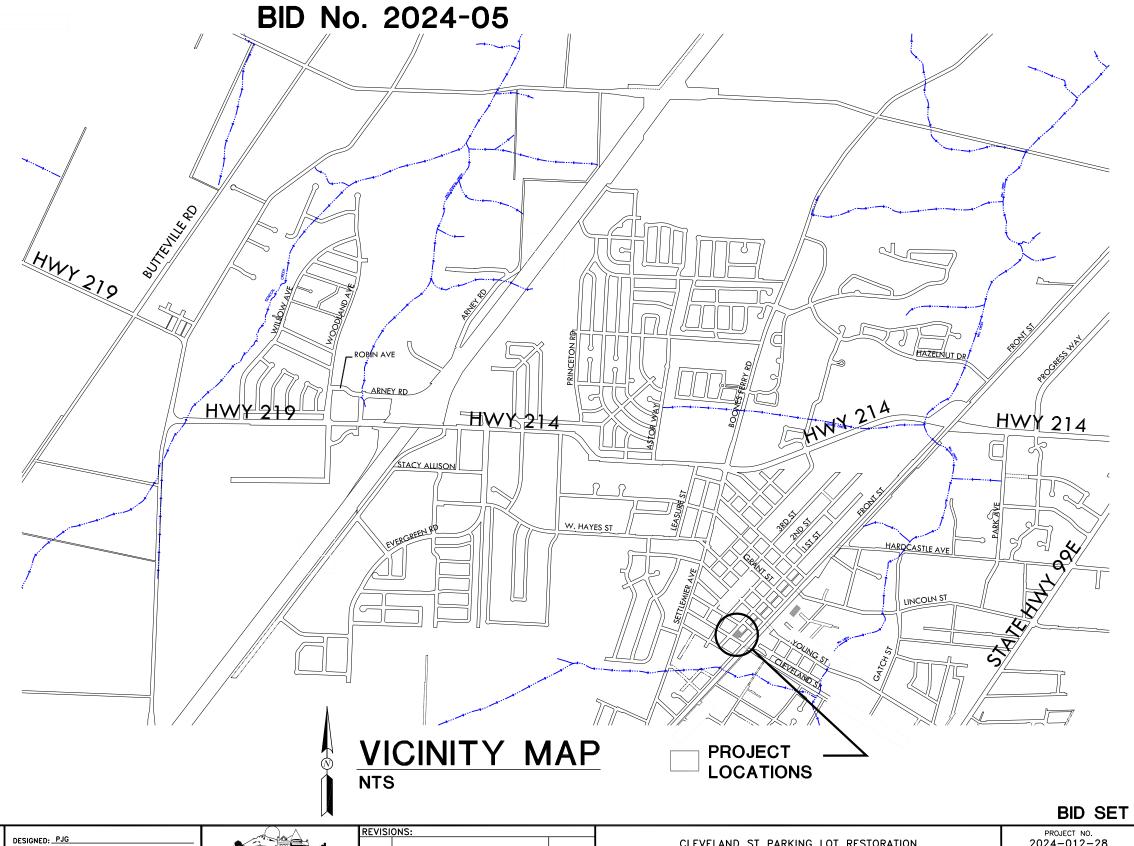

THIS BAR IS ONE-INCH ON ORIGINAL DRAWING.

HORIZONTAL DATUM: N/A VERTICAL DATUM: N/A


CLEVVELAND ST PARKING LOT RESTORATION

PROJECT No. 2023-011-28

CLEVELAND ST PARKING LOT RESTORATION TITLE SHEET

PROJECT NO. 2024-012-28 DATE MAY 2024 SHEET NO. OF

PLOT DATE: May 8, 2024

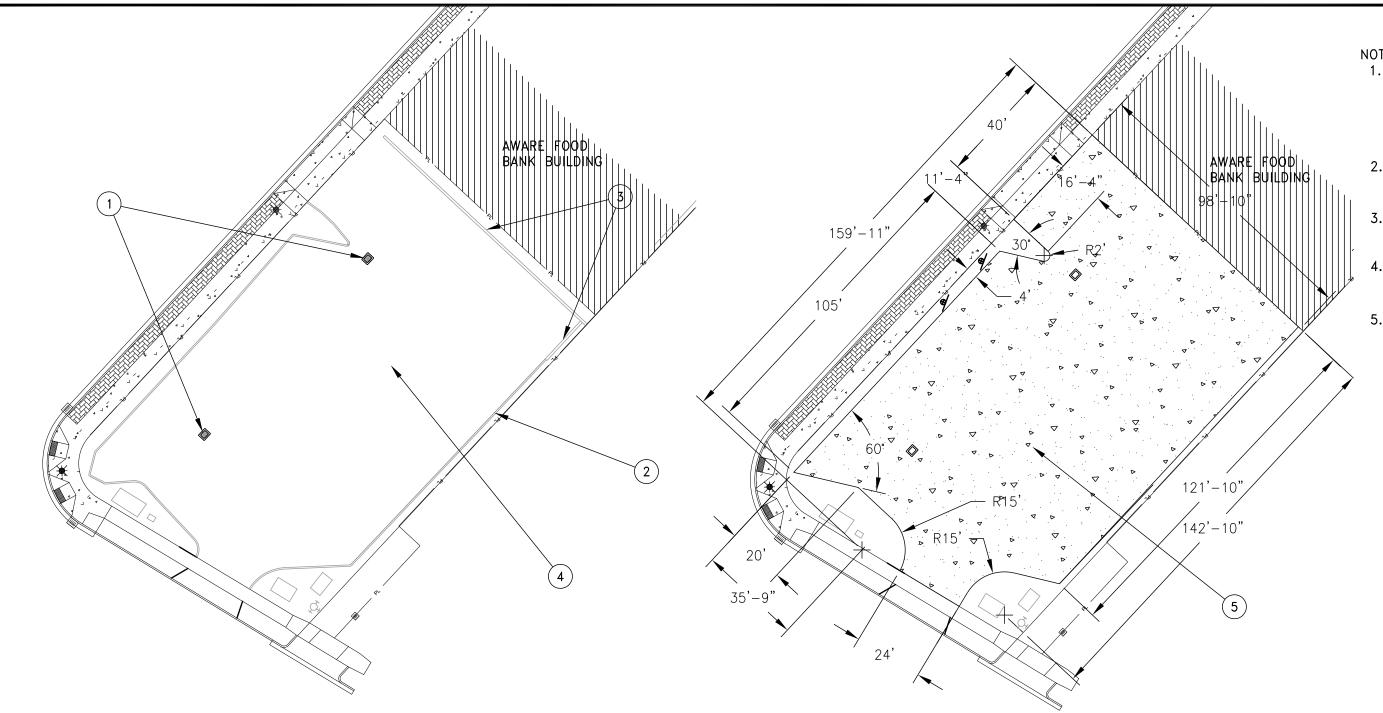

NOTES:

- 1. REMOVE EXISTING AREA DRAIN AND REPLACE WITH Clean WATER SERVICE AREA DRAIN TYPE II OR APPROVED EQUAL.
 2. REMOVE EXISTING
- EXTRUDED CURB (APPROX. 340 FT)
- 3. REMOVE 20 6" WHEEL STOPS AND SAVE FOR OWNER.
- 4. REMOVE EXISTING AC AND BASE (APPROX. 14,200 SF,).
- 5. 2" AC OVER 4" AGGREGATE BASE

DEMOLITION PLAN

SCALE: 1" = 400'

PAVING PLAN

SCALE: 1" = 400'





ENGINEERING DIVISION


PROJECT TITLE:
CLEVELAND ST PARKING LOT RESTORATION

DRAWING NAME:

DEMO & PAVING PLAN

2023-012-28 DESIGNED: PROJ. NO: DWG. NO: 1 OF 3 DRAWN BY: 05/02/2024 REVIEWED: DATE: SCALE: NTS APPROVED:

PLOT DATE: 5.8.2024

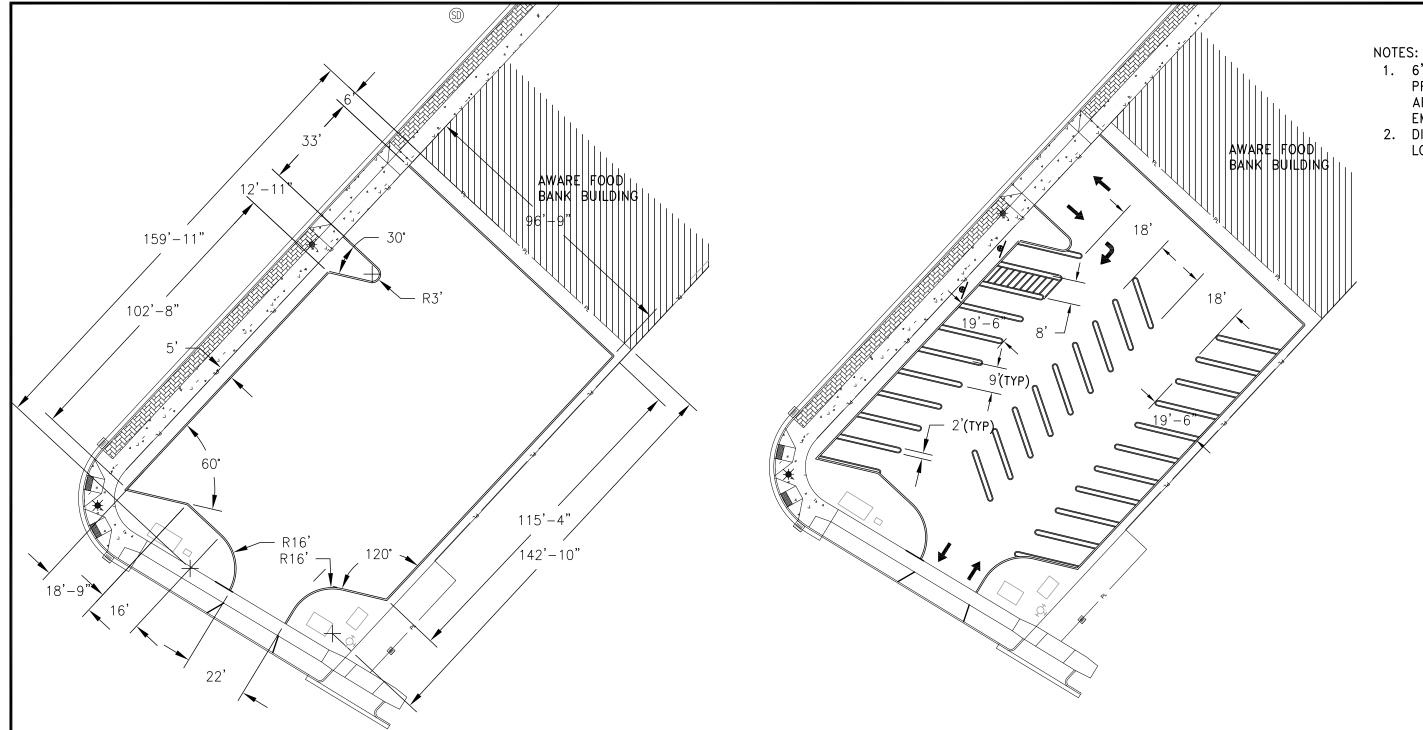


- 1. 6" EXTRUDED CURB, PROFILE TO BE APPROVED BY THE EMGINEER.

 2. DIMENSIONS TO PARKING LOT FACE OF CURB

STRIPING PLAN

SCALE: 1" = 400'

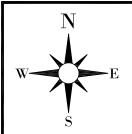

Incorporated 1889 PUBLIC WORKS DEPARTMENT ENGINEERING DIVISION

PROJECT TITLE:
CLEVELAND ST PARKING LOT RESTORATION


DRAWING NAME:
EXTRUDED CURB & STRIPING PLANS

PROJ. NO:	2023-012-28	DESIGNED:	PJG
DWG. NO:	2 OF 3	DRAWN BY:	PJG
DATE:	05/02/2024	REVIEWED:	XX
SCALE:	NTS	APPROVED:	XX

PLOT DATE: 5.8.2024

EXTRUDED CURB PLAN

SCALE: 1" = 400'

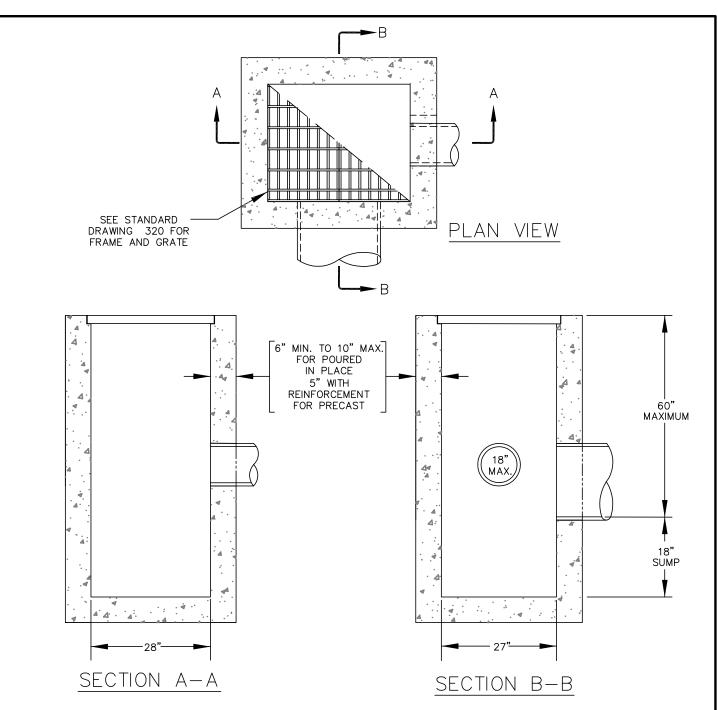

NOTES:

- ALL PRECAST SECTIONS SHALL CONFORM TO REQUIREMENTS OF ASTM C-478.
 INSTALL STRUCTURE ON MIN. OF 8" OF 3/4"-0" COMPACTED BASE MATERIAL.
 PRE CAST REINFORCEMENT SHALL BE REBAR MEETING ASTM A615 GRADE OR WELDED WIRE MEETING ASTM A497.
- 4. ALL POURED INPLACE CONCRETE SHALL HAVE A 28 DAY STRENGTH OF 3000 P.S.I. AND A SLUMP OF 2" TO 4".
- 5. AREA DRAINS IN REAR OR SIDE YARDS SHALL NOT BE SUMPED AND SHALL BE PROPERLY CHANNELIZED.
- 6. PRECAST STRUCTURES CONFORMING TO ODOT TYPE CG-2 CATCH BASIN INLETS ARE AN ACCEPTABLE ALTERNATE. (ALL GRATE MATERIALS AND DIMENSIONS SHALL MEET CWS STANDARDS AS SHOWN ON DRAWING 320).

AREA DRAIN TYPE II

